



DAVID MUSA - LUIS MIGUEL PIZANO - TIANYU YANG - REEM YASSIN

ADDRESS

Columbia University Graduate School of Architecture, Planning and Preservation 1172 Amsterdam Ave New York, NY 10027

PROJECT TEAM

ARCHITECTURE TECHNICAL CONSULTING

JOSEPH HAND Shop Architects 233 Broadway 11th Floor New York, NY 10279

STRUCTURAL AMY HARRINGTON PE Silman 32 Old Slip New York, NY 10005

MECHANICAL & SUSTAINABILITY JONCE WALKER LEED AP CSBA

Thornton Tomasetti, Inc. 51 Madison Ave New York, NY 10010

ENCLOSURE KATHERINE CHAN

Walter P Moore 180 Maiden Ln #803 New York, NY 10038

100% CONSTRUCTION DOCUMENTS

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> **PROJECT** Greenpoint Theater 18 Greenpoint Ave. Brooklyn, NY 11222

DRAWING TITLE Title Sheet

DRAWING SCALE

T000




DRAWING KEY



Concrete

Steel

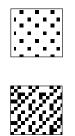

Wood

Insultation

DRAWING SYMBOLS

North Arrow



Scale



Below / Behind

× /

_ · _ · _ · _ · _ · _

Void

Above

ABBREVIATIONS

WC	Bathroom				
STO	Storage				
DR	Dressing Room				
MECH	Mechanical Room				
ІТ	IT Room				
ELEC	Electrical Room				
ELEV	Elevator				
sq. ft.	Square Feet				

ARCHITECTURE GENERAL NOTES

1. Coordinate all work with architectural drawings and specifications.

2. Do not scale drawings.

3. Contractor and sub-contractors shall familiarize themselves with existing conditions, locations, and project requirements prior to submitting a bid.

4. Contractor and sub-contractors shall field verify dimensions, and familiarize themselves with project requirements prior to commencing with the work. Contractor shall report any discrepancies to architect.

5. Work shall include all required permits, labor, materials, and equipment to complete all work indicated on drawings and as necessary for a complete project.

6. Provide temporary dust-proof partitions as required to protect all exist. Areas and equipment from damage due to demolition or new construction activities. Coordinate locations and requirements with owner.

7. General contractor to patch, repair and paint (refinish) surfaces and building elements damaged by mechanical, electrical, and plumbing work and where items are removed, relocated or added.

8. Repair floors where damaged by the work of this project.

9. Patch and repair all surfaces to match existing where items are removed or altered - field verify extent required.

10. All painting shall be done in accordance with manufacturer's specifications. Contractor is responsible for protecting adjacent finishes and cleanup.

11. Contractor is responsible for final cleanup of work area and all exposed building surfaces at substantial completion.

12. All trash and tools shall be removed from premises each day and the area left clean whenever unattended. Each contractor shall be responsible for cleanup. Coordinate with owner if secure storage is needed onsite.

13. Contractor shall be responsible for damage to finished surfaces, equipment, furniture, existing materials or finishes, caused as a result of his work. Repair or replace damaged items as directed by architect.

14. All work shall be done in accordance with applicable codes and standards.

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S202 Structural Section
S301 Structural Details



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ENCLOSURE

KATHERINE CHAN Walter P Moore 180 Maiden Ln #803 New York, NY 10038

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DRAWING TITLE Table of Contents & Drawing Key

DRAWING SCALE

T001

IRONMENT

1 Sustainability Strategy Diagram


- 2 Sustainability Strategy Diagram
- HVAC Zone Plans
- 2 Mechanical First Floor Plan
- 3 Mechanical Second Floor Plan
- 04 Mechanical Third Floor Plan
-)5 Mechanical Roof Plan
- 6 Air Riser Diagram
- 7 Water Riser Diagram

LOSURE

Enclosure Systems
 Enclosure Systems,
 Mapped Elevations E/W
 Enclosure Systems,
 Mapped Elevations N/S
 System 1 Roadmap

ST ESTIMATE

mate Spreadsheet

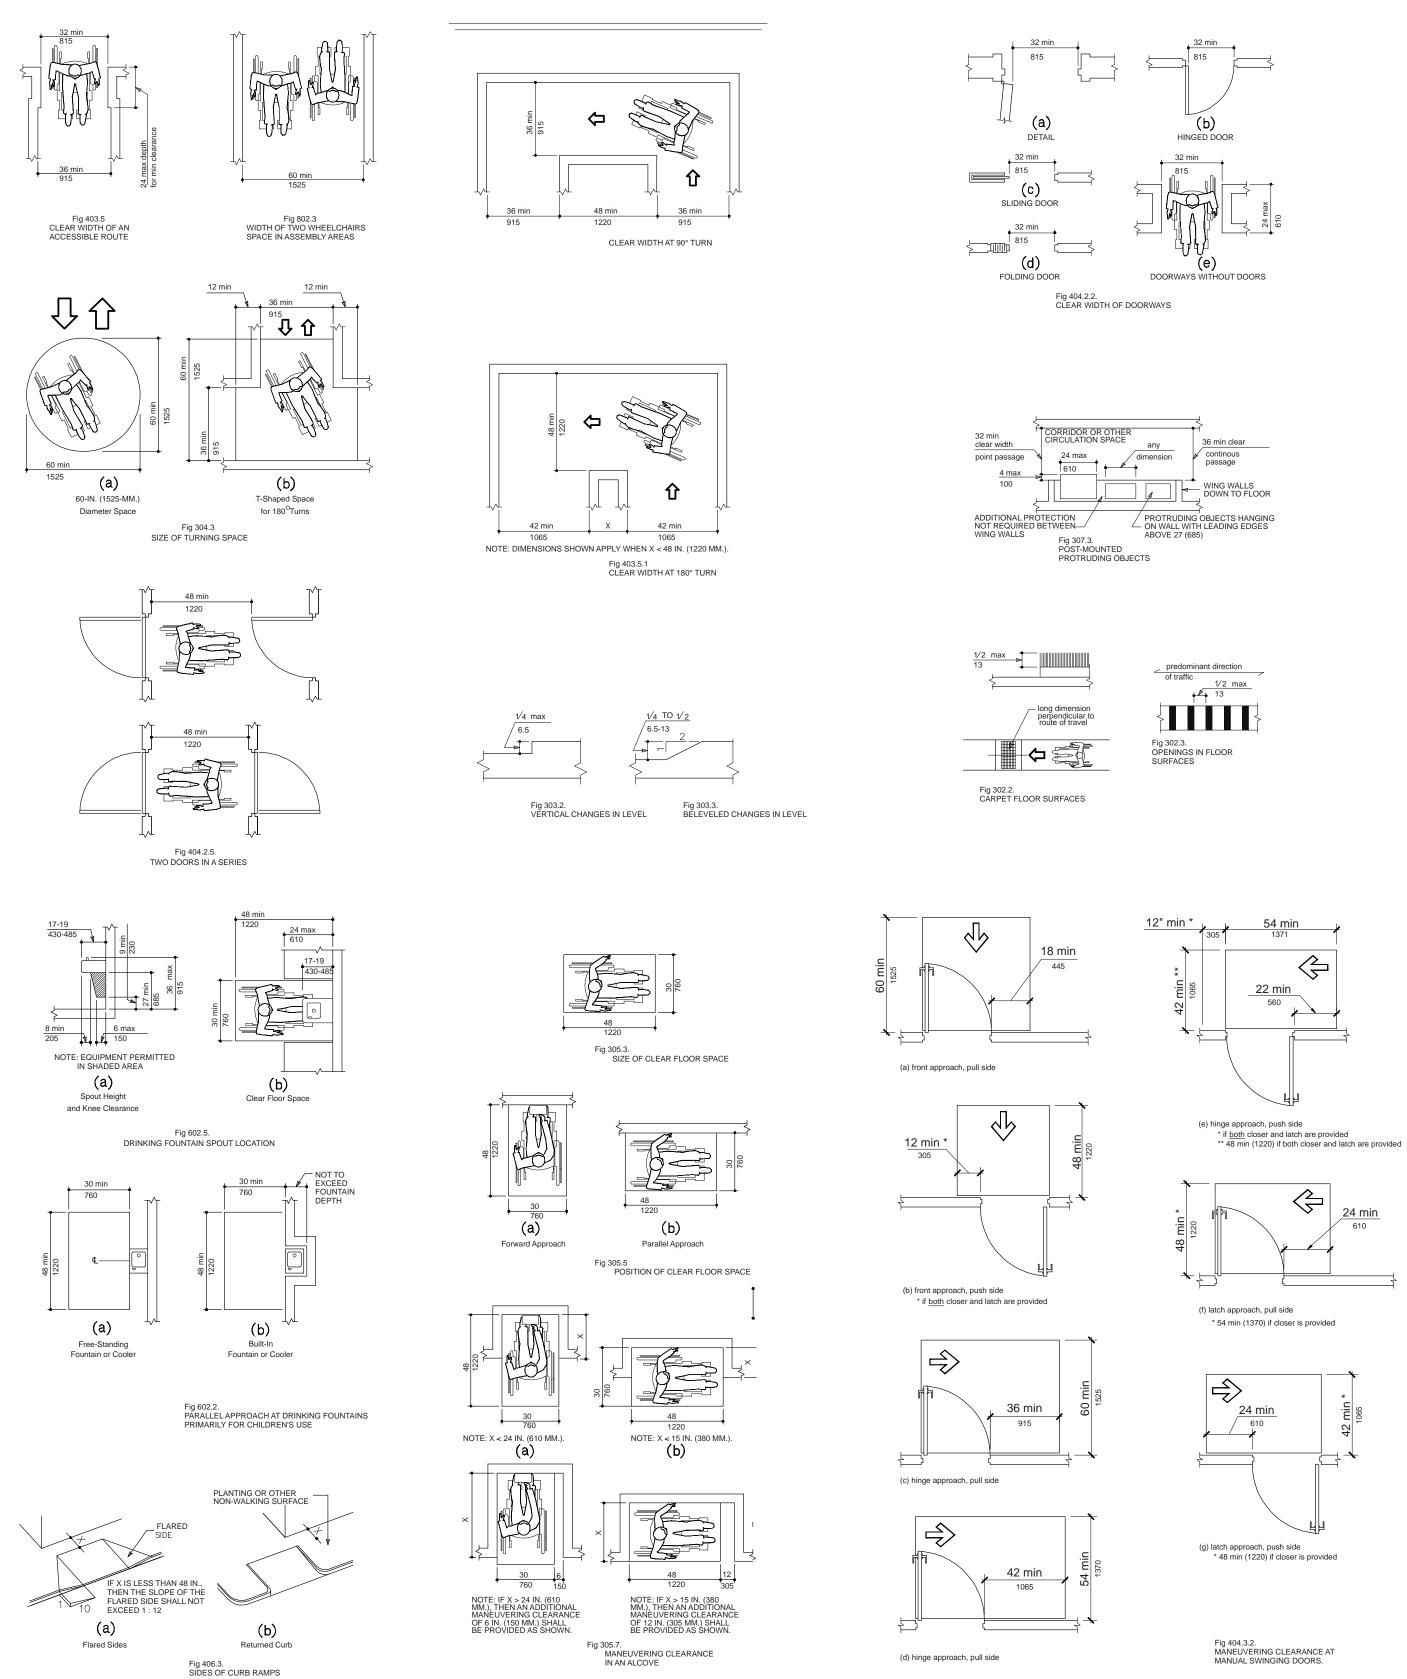


ADA NOTES

- 1. PROVIDE ACCESSIBLE MEANS OF EGRESS COMPLIANT WITH 2014
- NEW YORK CITY BUILDING CODE [CH11] AND 2009 ICC/ANSI A117.1 CODE. 2. ALL TACTILE SIGNAGES TO BE TO BE MOUNTED AT 60" A.F.F. ON THE

NEW YORK CITY ADA DIAGRAMS AS PER 2009 ICC/ ANSI A117.1

LATCH SIDE OF THE DOOR

Fig 404.3.2. MANEUVERING CLEARANCE AT MANUAL SWINGING DOORS.

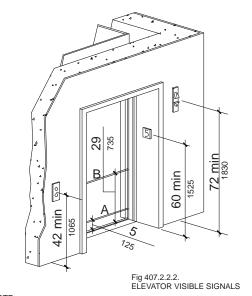

NOTE: 1. THE AUTOMATIC DOOR REOPENING DEVICE IS ACTIVATED IF AN OBJECT PASSES THROUGH EITHER LINE 'A' OR LINE 'B' LINE 'A' & LINE B' REPRESENT THE VERTICAL LOCATIONS OF THE DOOR REOPENING DEVICE NOT REQUIRING CONTACT. ELEVATOR INTERIOR MUST HAVE SUPPORT RAIL ON AT LEAST ONE WALL. ALL SUPPORT RAILS TO BE SMOOTH & HAVE NO SHARP EDGES & MUST NOT BE MORE THAN 1 1/2" THICK OR 2 1/2" DIAM. SUPPORT RAILS MUST BE CONTINUOUS & A MIN. LENGTH OF 42" OVERALL. THE INSIDE SURFACE OF THE RAIL MUST BE 1 1/2" CLEAR OF THE CAR WALL. THE DISTANCE FROM THE TOP OF THE SUPPORT RAIL TO THE FINISH CAR FLOOR MUST BE AT LEAST 31" AND NOT MORE THAN 33". PADDED OR TUFTED MATERIAL OR DECORATIVE MATERIALS SUCH AS WALLPAPER, VINYL, CLOTH OR THE LIKE MAY NOT BE USED ON SUPPORT RAILS.



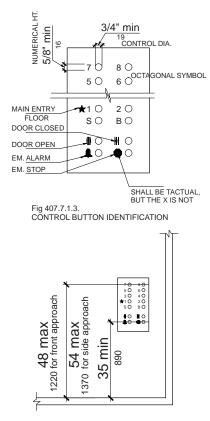



Fig 407.2.1.1. HEIGHT OF ELEVATOR CALL BUTTONS

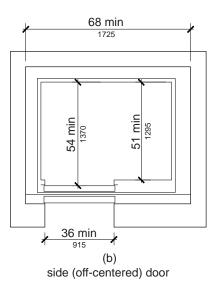

407.4.1 INSIDE DIMENSIONS OF ELEVATOR CRAS

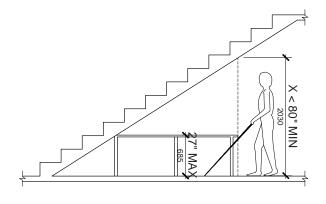


307.4 REDUCED VERTICAL CLEARANCE

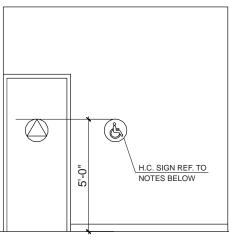


MIN. HEIGHT OF BRAILLE CHARACTERS ABOVE FLOOR


1. RAISED CHARACTERS OR SYMBOLS SHALL CONFORM TO THE FOLLOWING: a) LETTERS AND NUMBERS ON THE PERMANENT IDENTIFICATION SIGN SHALL BE RAISED 1/32" MIN. AND SHALL BE SANS-SERIFF UPPERCASE CHARACTERS ACCOMPANIED BY GRADE 2 BRAILLE. b) RAISED CHARACTERS OR SYMBOLS SHALL BE A MIN OF 5'-0" HIGH c) PICTORIAL SYMBOL SIGNS (PICTOGRAMS) SHALL BE ACCOMPANIED BY THE EQUIVALENT VERBAL DESCRIPTION PLACED DIRECTLY BELOW THE PICTOGRAMS. THE BORDER DIMENSION OF THE PICTOGRAM SHALL A MIN OF 6" IN HEIGHT.

2. CONTRACTED GRADE BRAILLE SHALL BE USED ON THE PERMANENT IDENTIFICATION SIGN. DOTS SHALL BE 1/10" ON CENTERS IN EACH CELL WITH 2/10" SPACE BETWEEN CELLS. DOTS SHALL BE RAISED A MIN OF 1/40" ABOVE THE BACKGROUND. 3. LETTERS AND NUMBERS ON THE PERMANENT IDENTIFICATION SIGN SHALL HAVE A WIDTH-TO-HEIGHT RATIO BETWEEN 3:5 AND 1:1 AND A STROKE WIDTH-TO-HEIGHT RATIO BETWEEN 3:5 AND 1:1 AND A STROKE WIDTH-TO-HEIGHT RATIO BETWEEN 1:5 AND 1:10. 4. CHARACTERS AND NUMBERS ON THE PERMANENT IDENTIFICATION SIGN SHALL BE SIZED ACCORDING TO THE VIEWING DISTANCE FROM WHICH THEY ARE READ. THE MIN HEIGHT IS MEASURED USING AN UPPERCASE X LOWERCASE CHARACTERS ARE PERMITTED. 5. CHARACTERS AND SYMBOLS SHALL CONTRAST WITH THEIR BACKGROUND, EITHER LIGHT CHARACTERS ON A DARK BACKGROUND OR DARK CHARACTERS ON LIGHT BACKGROUND.

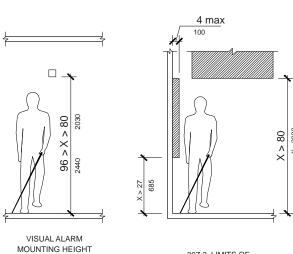

307.2 LIMITS OF PROTRUDING OBJECTS

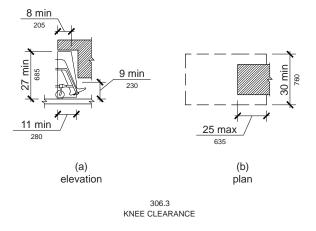

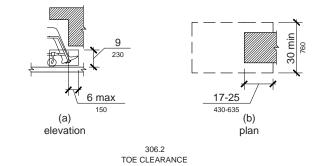



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ENCLOSURE

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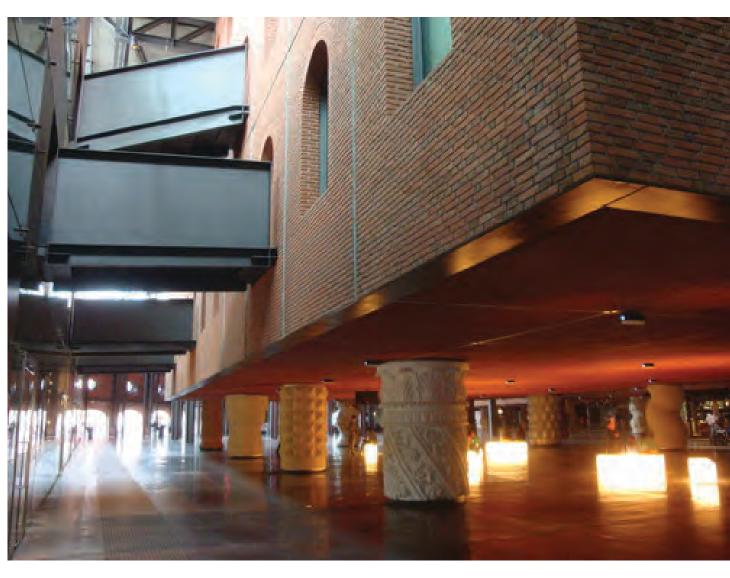
PROJECT **Greenpoint Theater** 18 Greenpoint Ave. Brooklyn, NY 11222

DRAWING TITLE ADA Diagrams

DRAWING SCALE

0 02








Extech Lightwall 3440 Philippe Starck, Azkuna Zentroa Culture Centre, Bilbao, Spain Trisha Brown Horizontal Dreaming





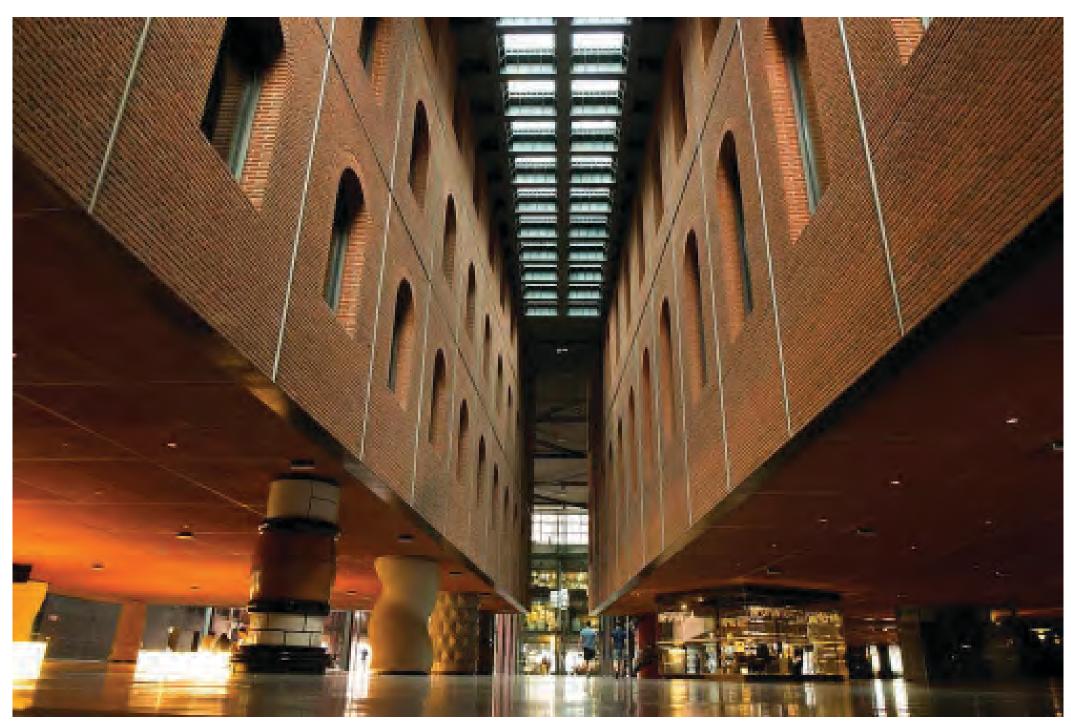





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DRAWING TITLE Precedent Images

DRAWING SCALE





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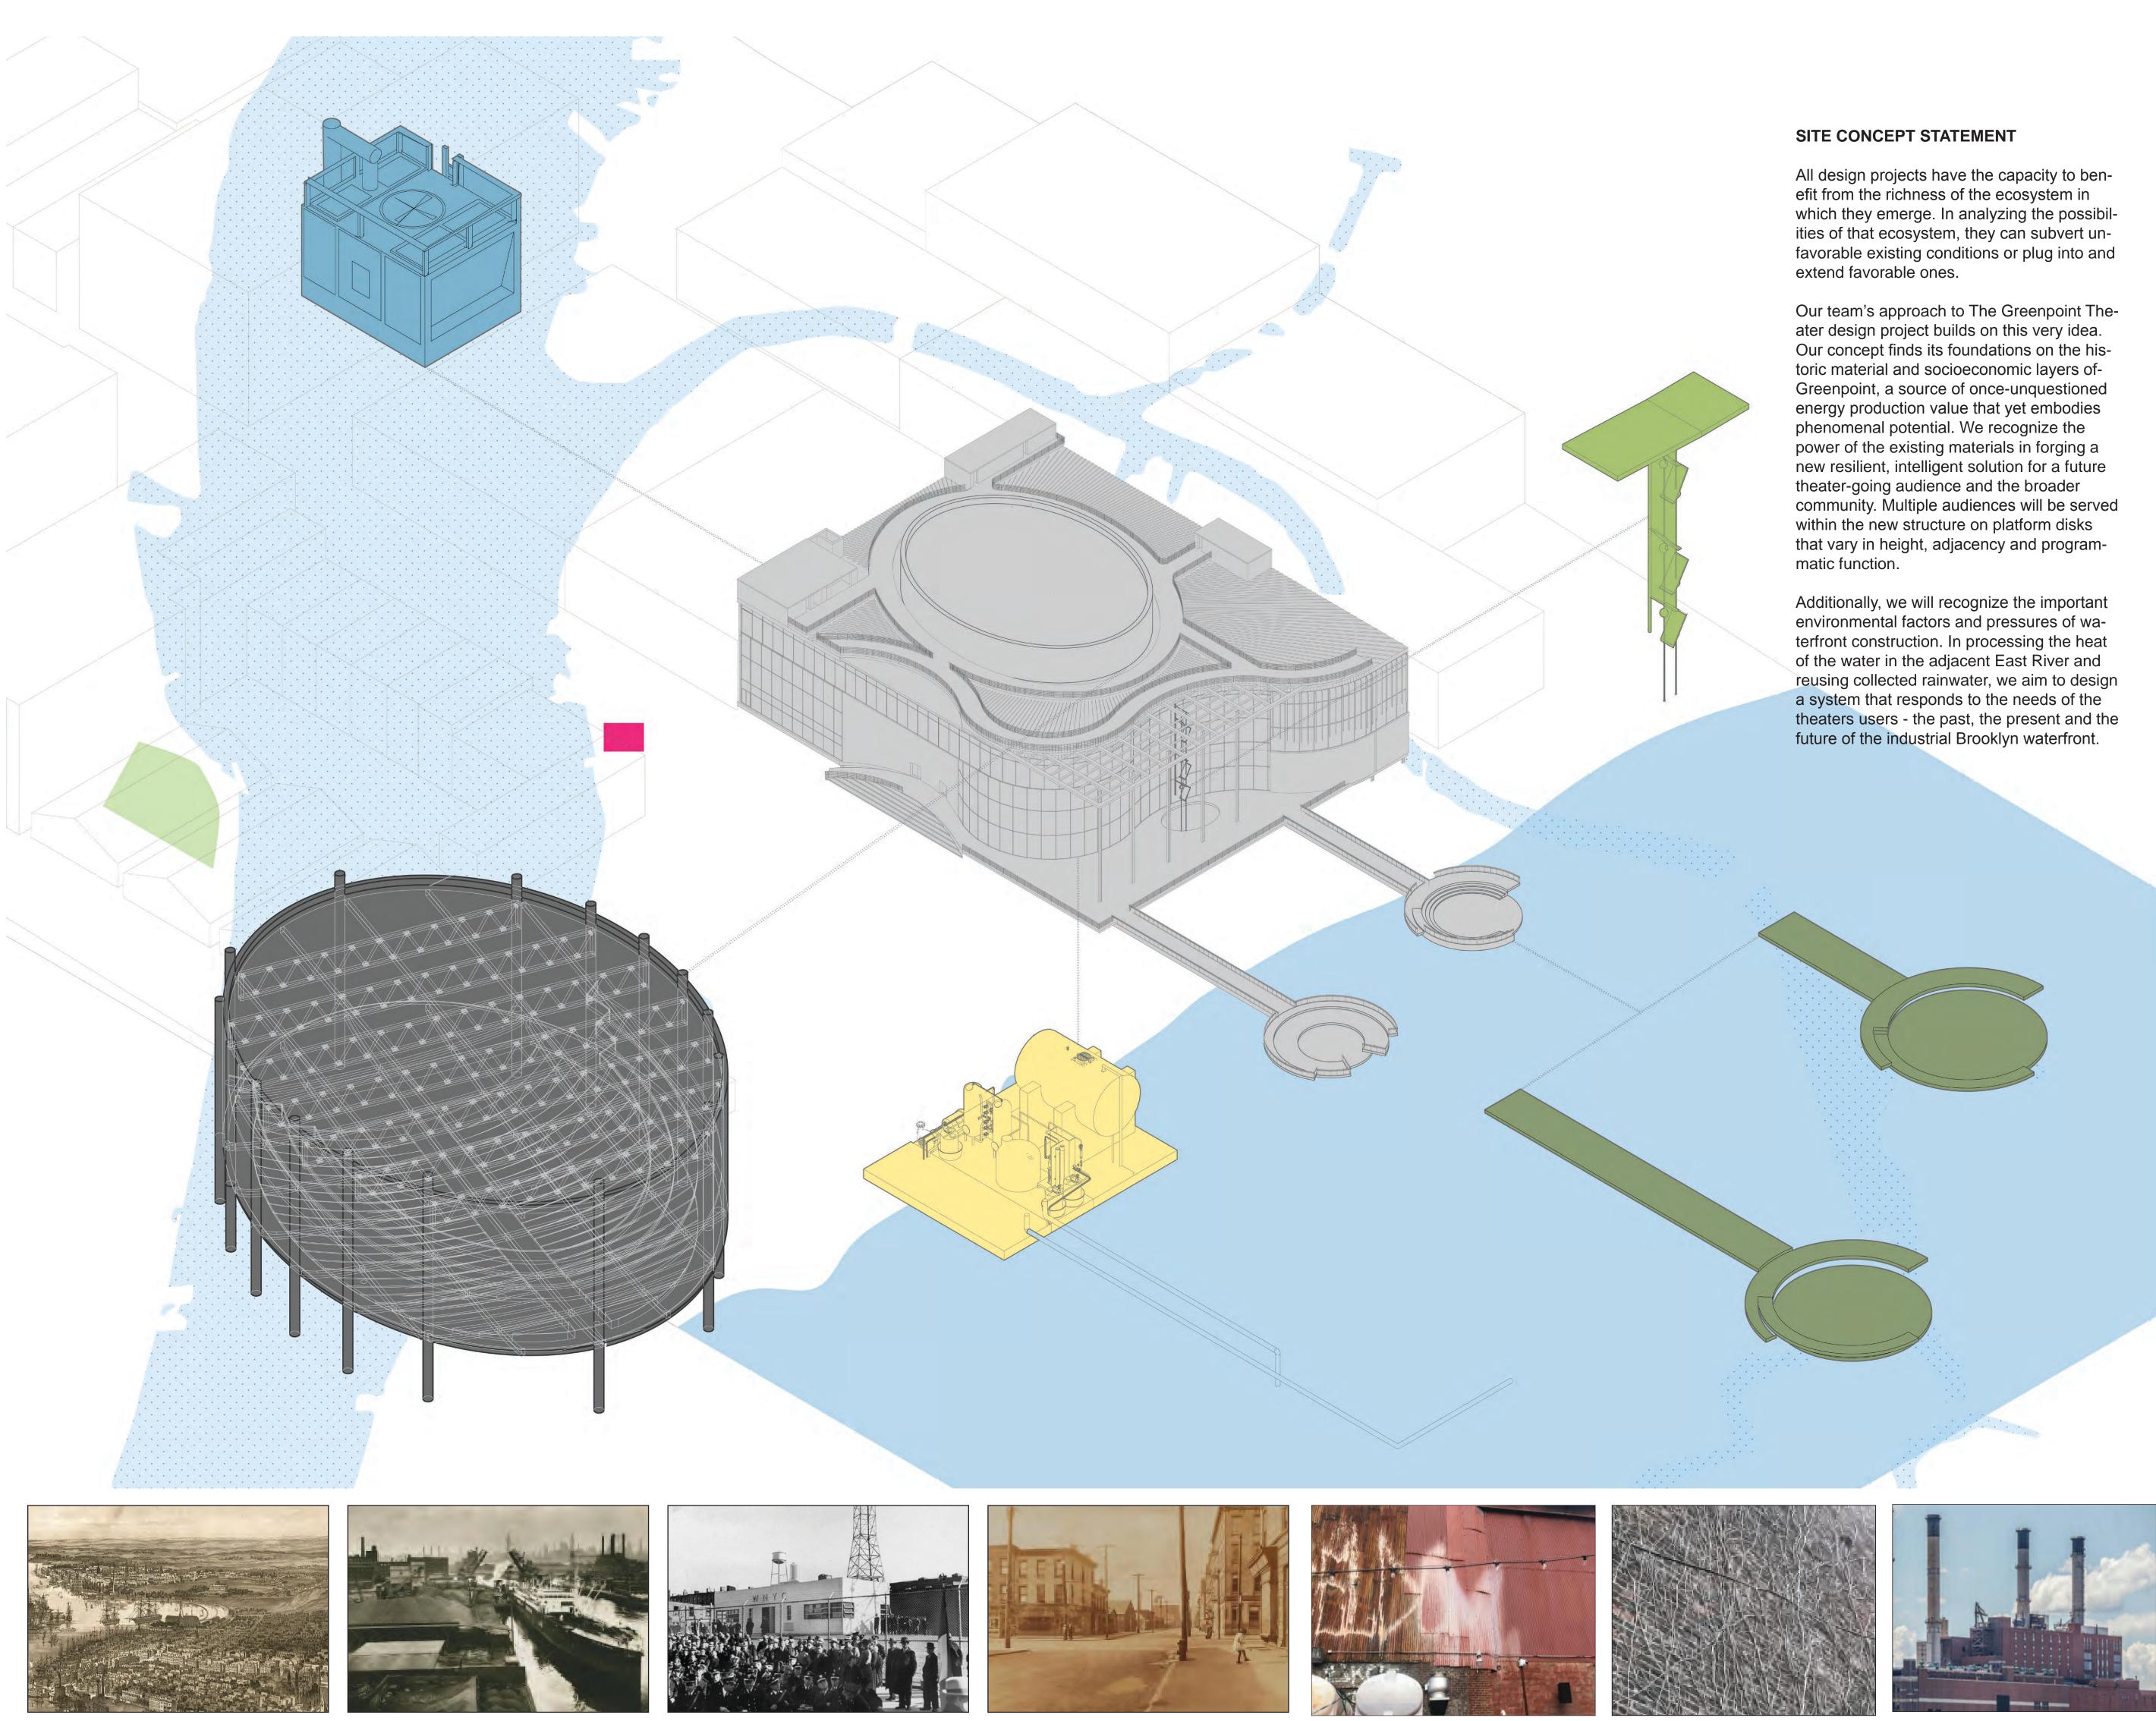
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> **PROJECT** Greenpoint Theater 18 Greenpoint Ave. Brooklyn, NY 11222

DRAWING TITLE Site Context

DRAWING SCALE

T004





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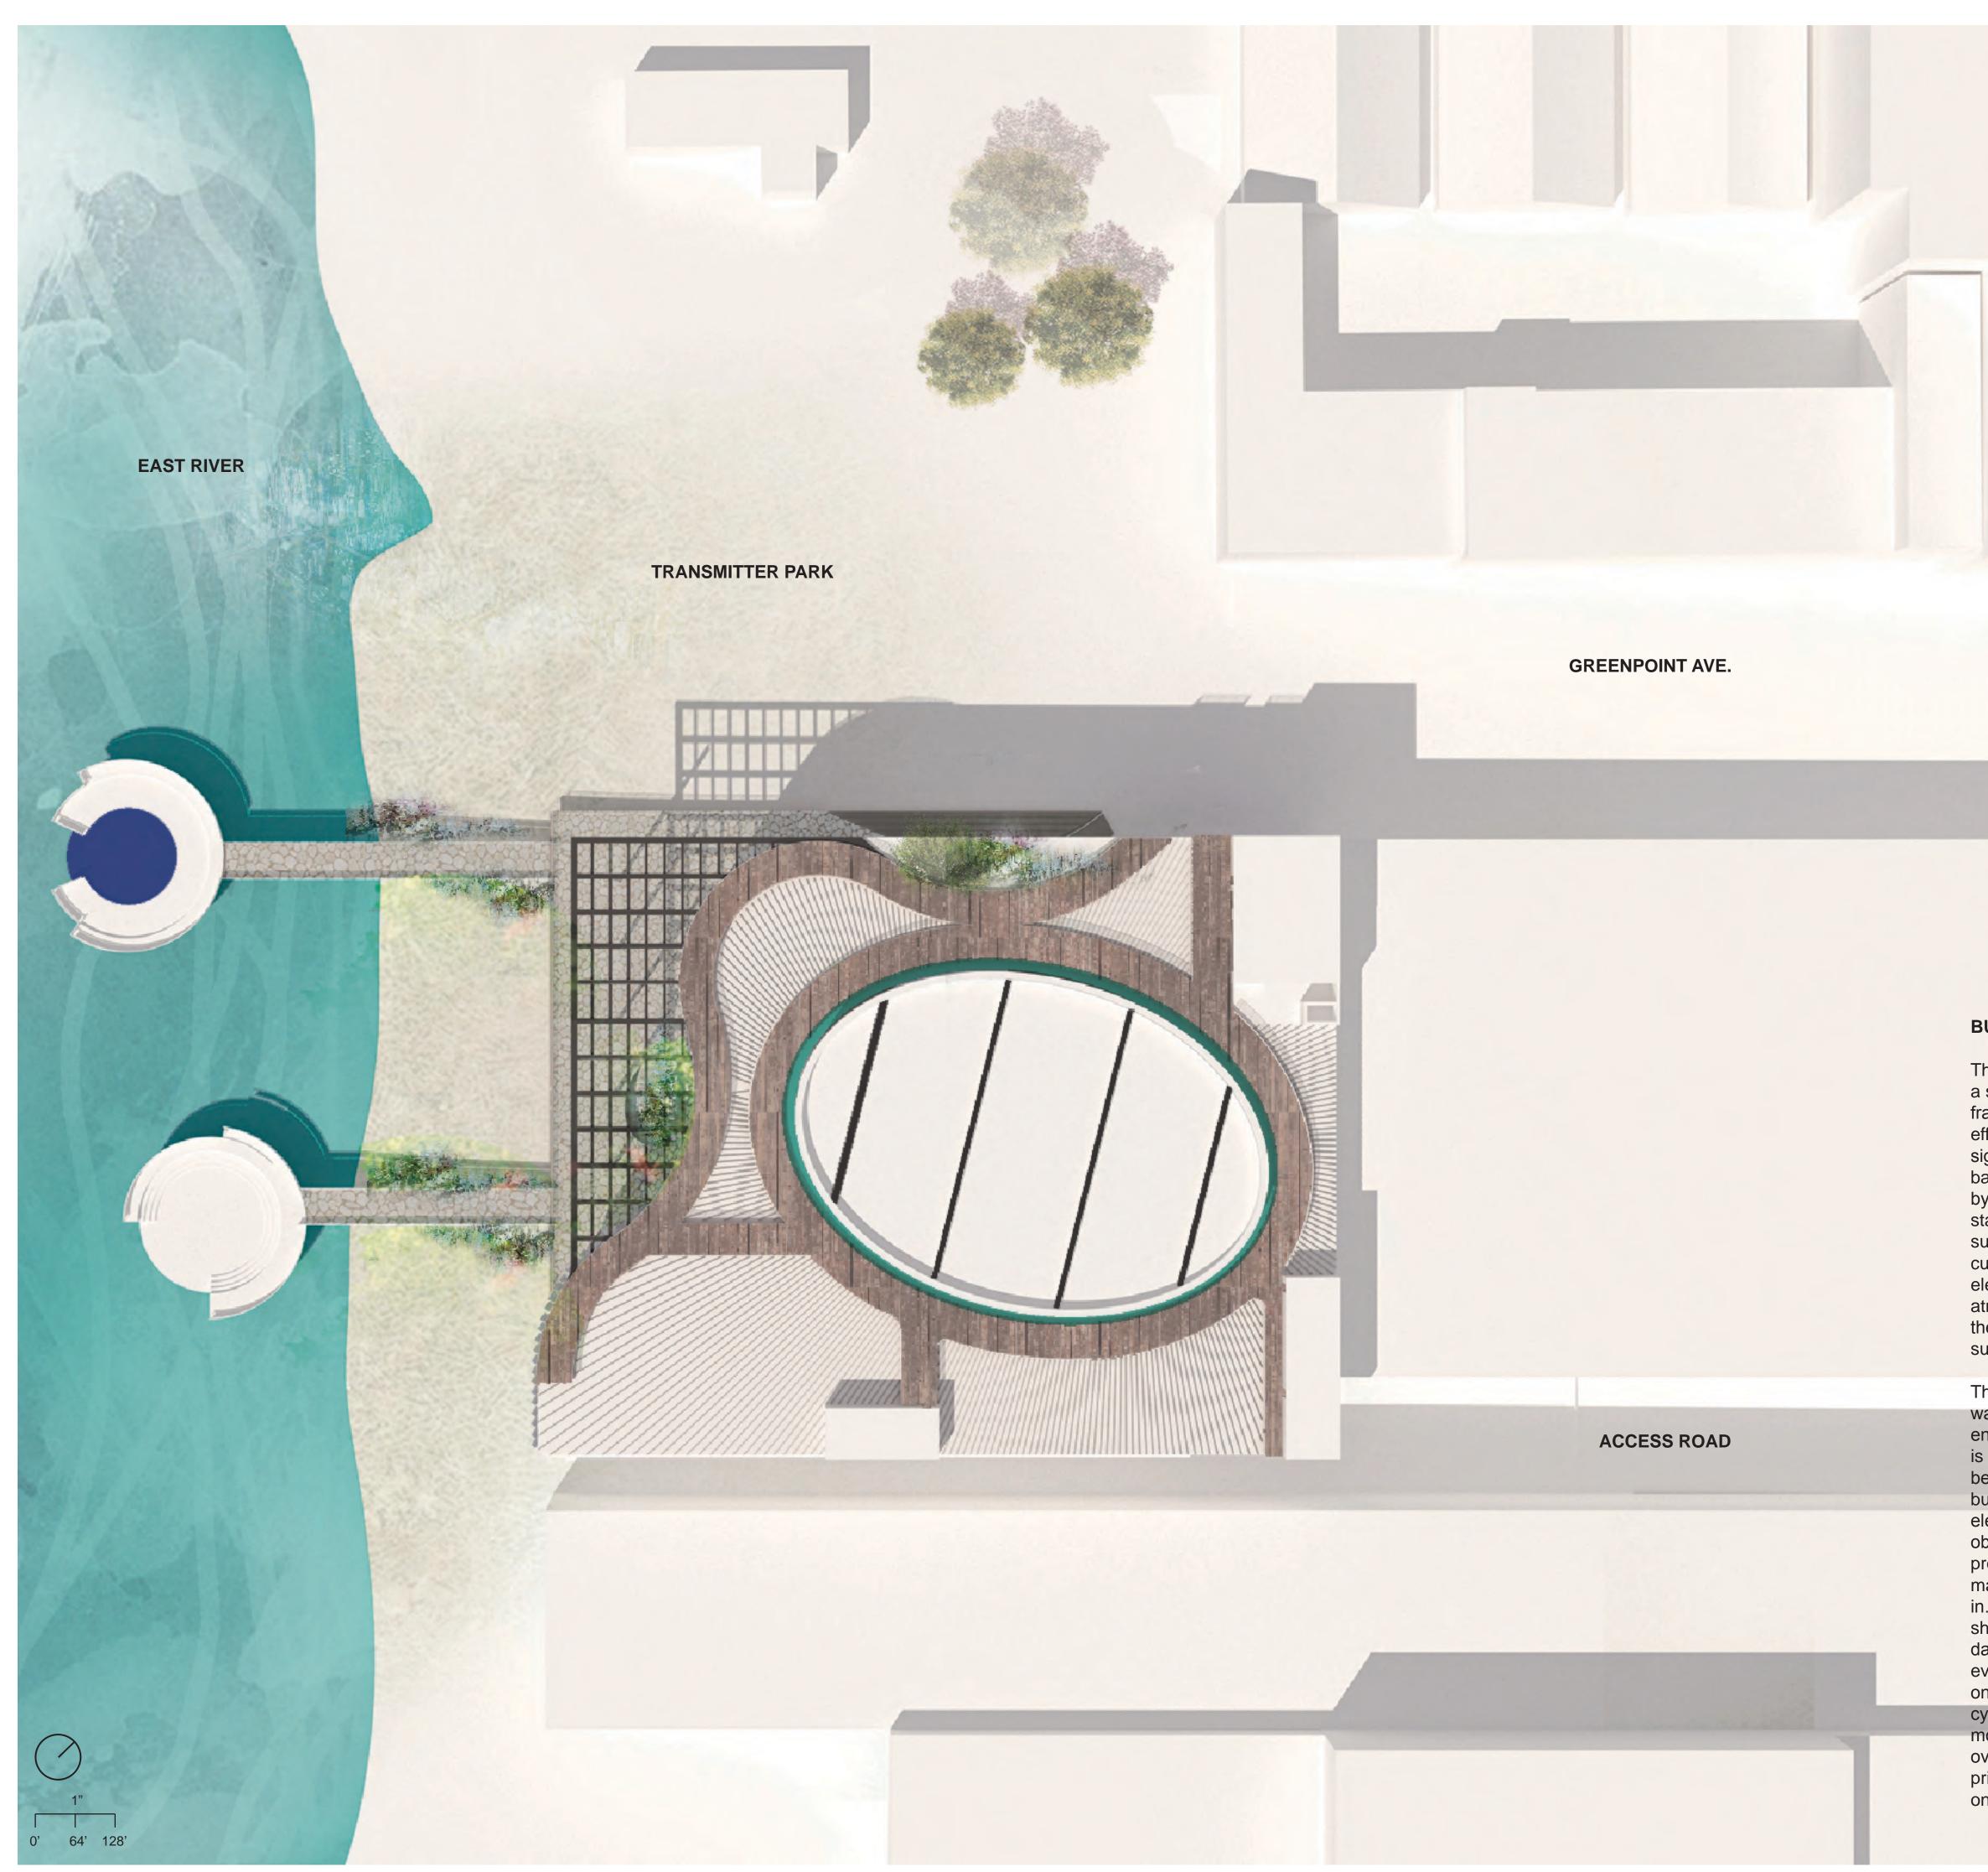
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> PROJECT **Greenpoint Theater** 18 Greenpoint Ave. Brooklyn, NY 11222

DRAWING TITLE Concept Diagram

DRAWING SCALE

 \bigcirc 05





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PROJECT Greenpoint Theater 18 Greenpoint Ave.

18 Greenpoint Ave. Brooklyn, NY 11222

DRAWING TITLE Site Plan

DRAWING SCALE 1/64" : 1'-0"

ISSUE DATE

December 13, 2019


A001

/EST ST.

BUILDING CONCEPT STATEMENT

The goal with this design was to emphasize a series of major spaces within the framework of our theater's layout. Thus efforts were made to bring these spaces of significance, such as the theater, black box, bar, performance spaces, etc. to the forefront by giving them differences in form than the standard orthogonal nature of other spaces such as the back of house. We felt that the curve of an ellipse was a strong thematic element, representative of the organic atmosphere we wish to create with this theater by connecting it to the nature which surrounds it.


The entrance to the theater is a curved brick wall creating a sense of mystery around the entry point, while the rest of the front facade is more transparent glass. The main theater, being the most significant space in the building, is designed to stand out. Thus it is elevated above the ground level very obviously with large columns. Its profile protrudes from the roof of the building making it a beacon of what goes on within. The channel glass finish sparkles and shines, allowing it to stand out in both daylight and artificial light used in the evening. The black box and the bar stack one on top of the other both reflecting the cylindrical shape of the theater, in a slightly more understated way. The attractive view over the river toward Manhattan's skyline is prioritized through the use of a glass facade on the east facade.

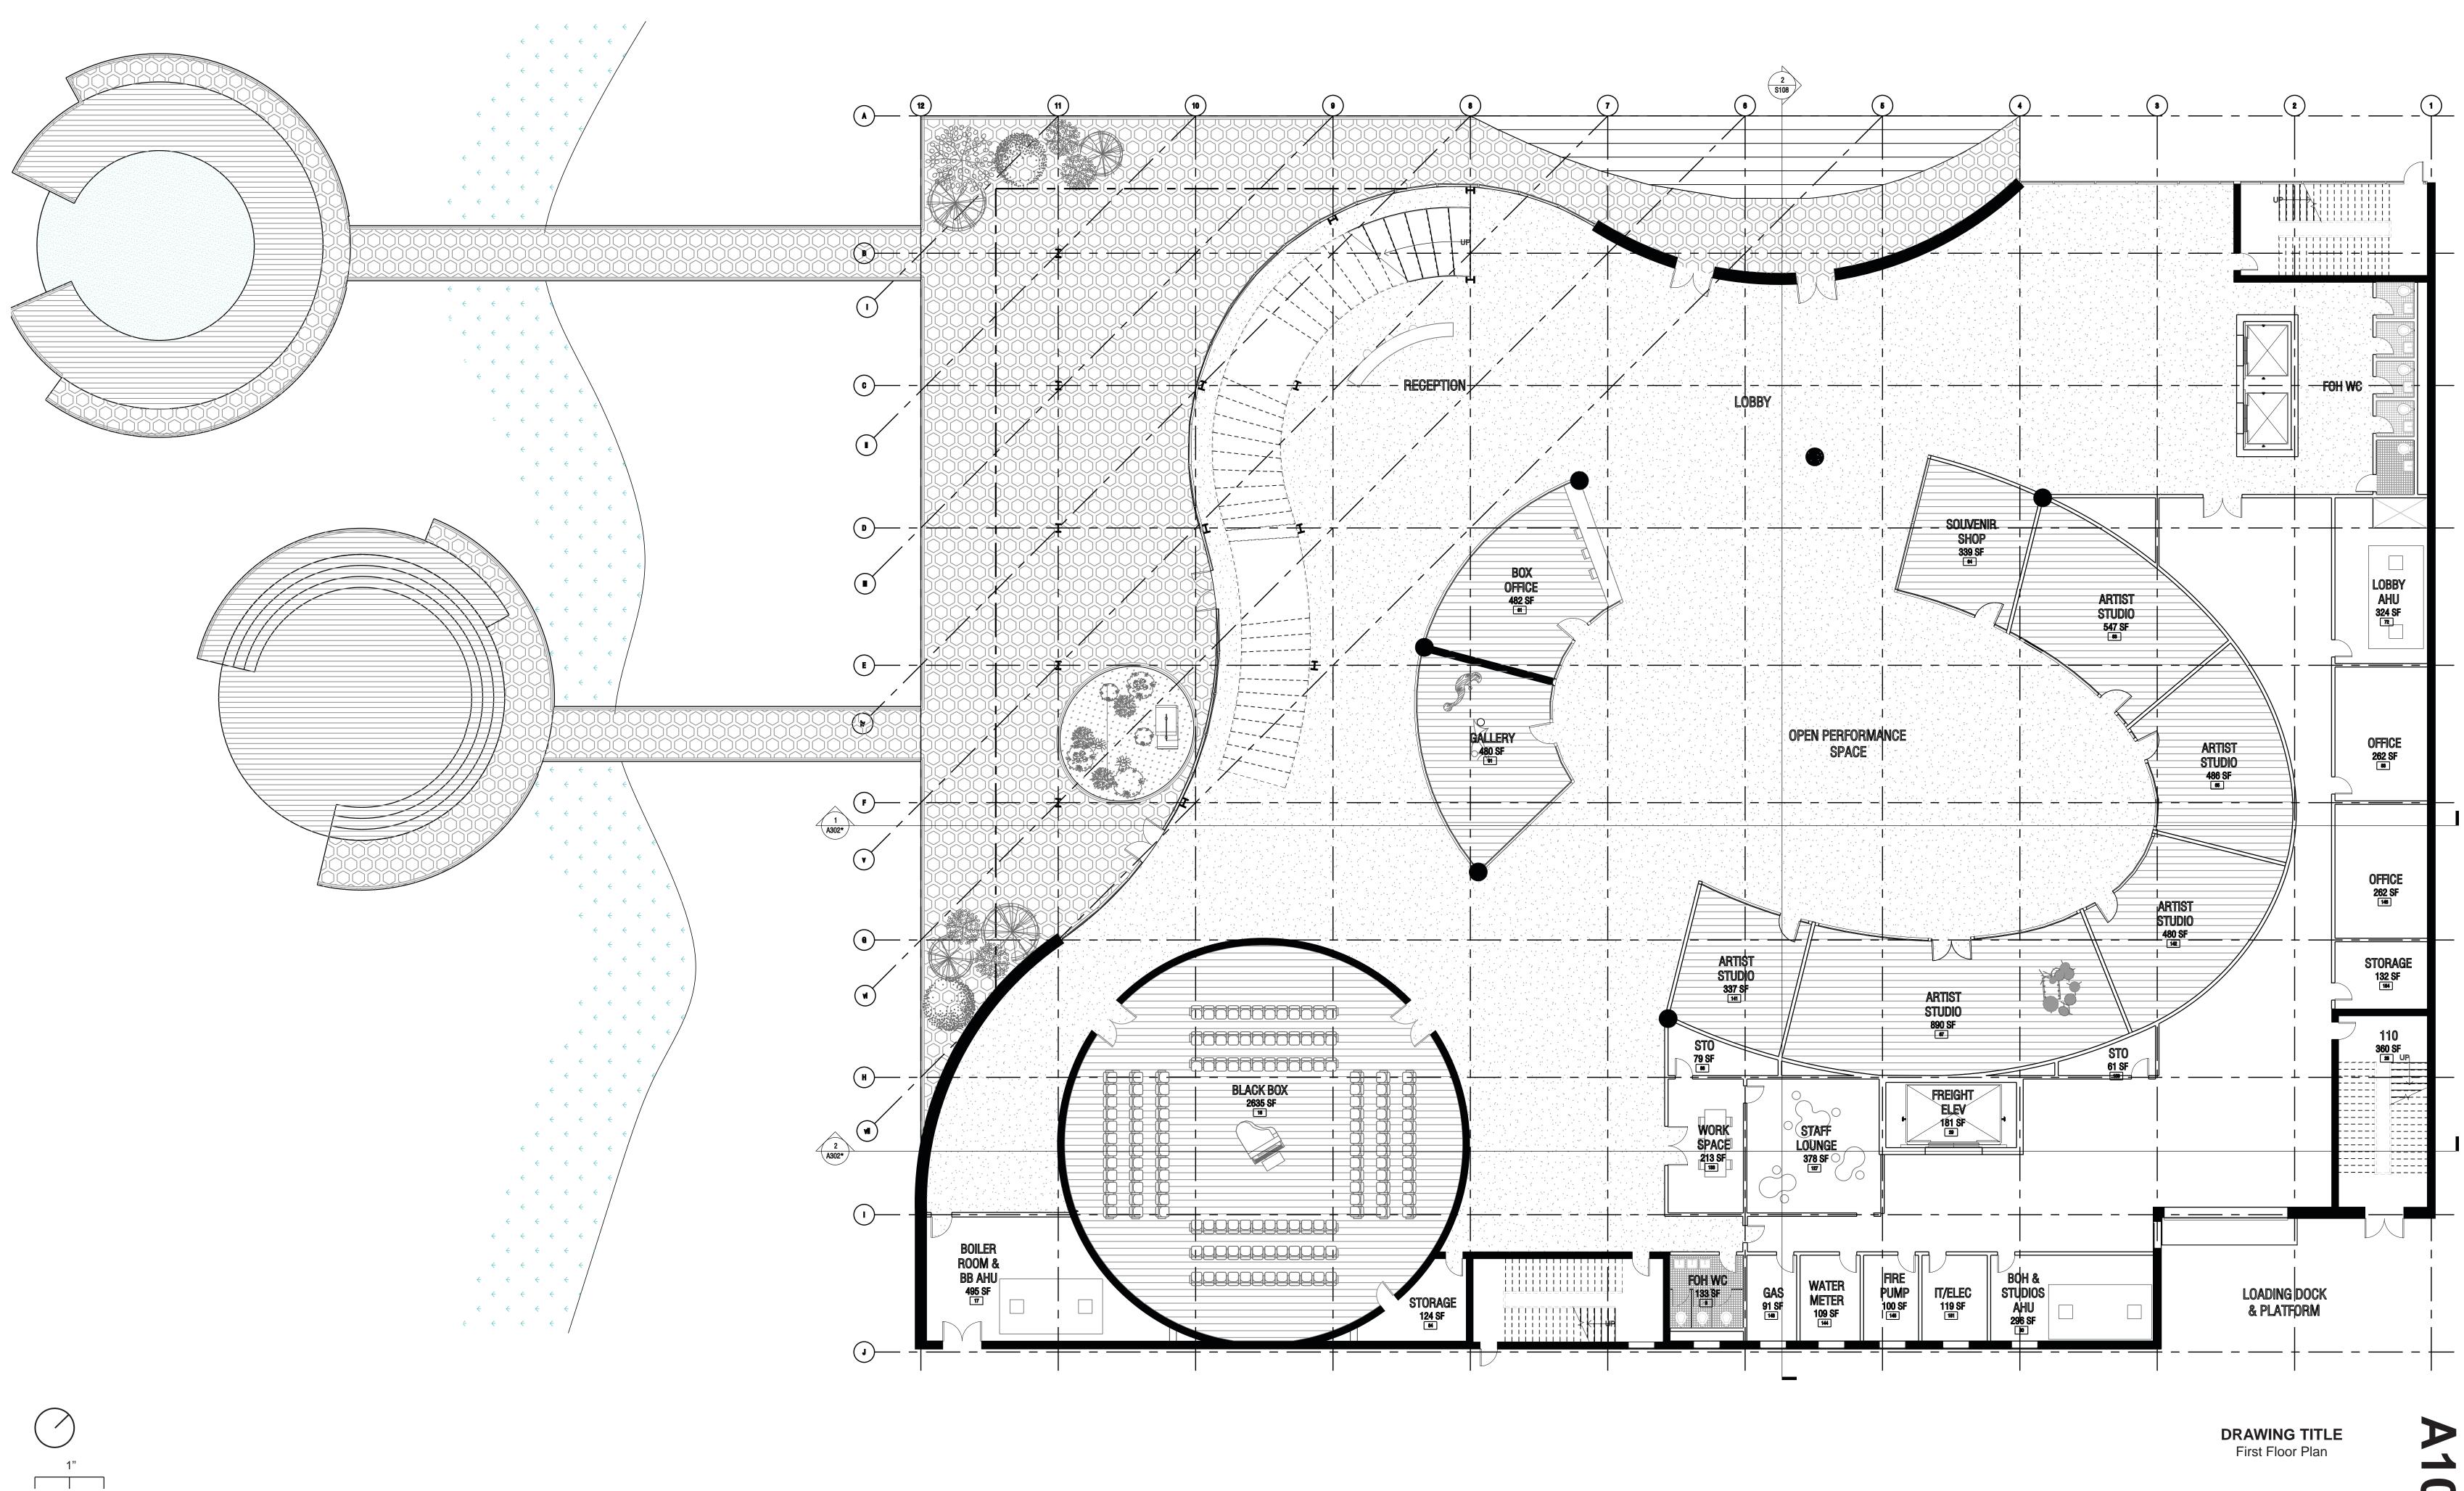

0' 8' 16'

01


DRAWING SCALE 1/8" : 1'-0"

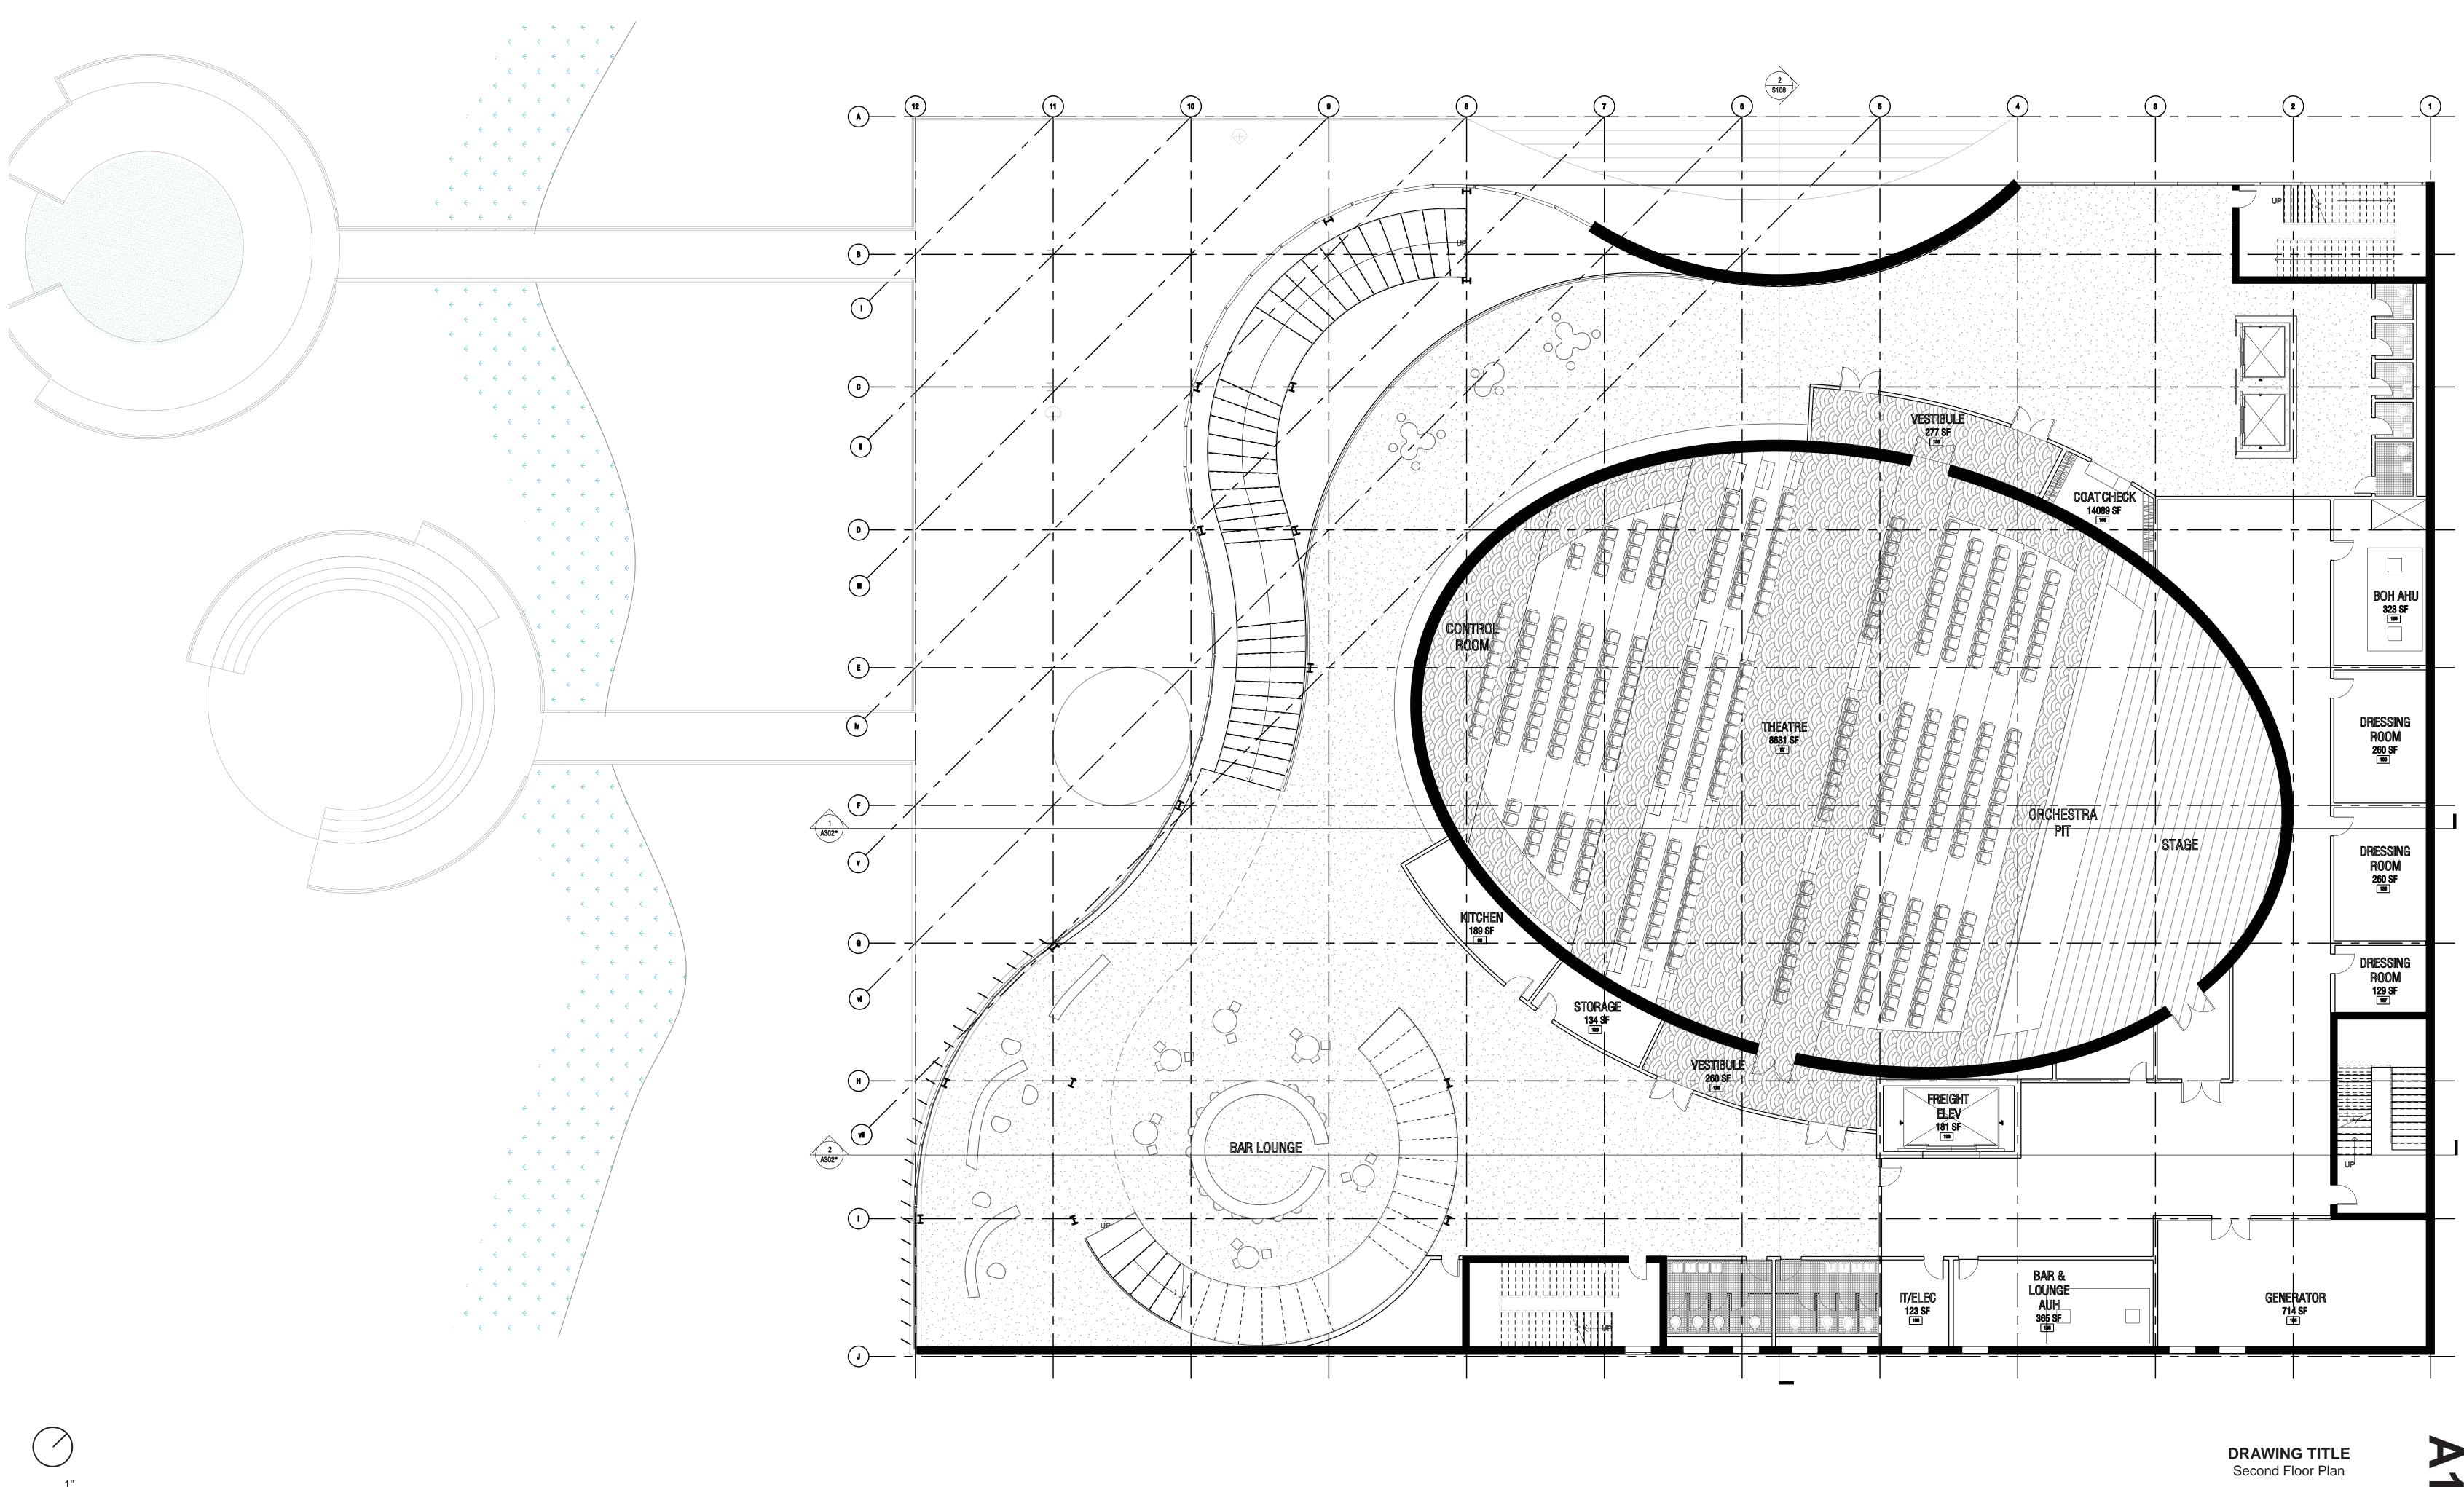

0' 8' 16'


 \triangleright 02

DRAWING SCALE 1/8": 1'-0"

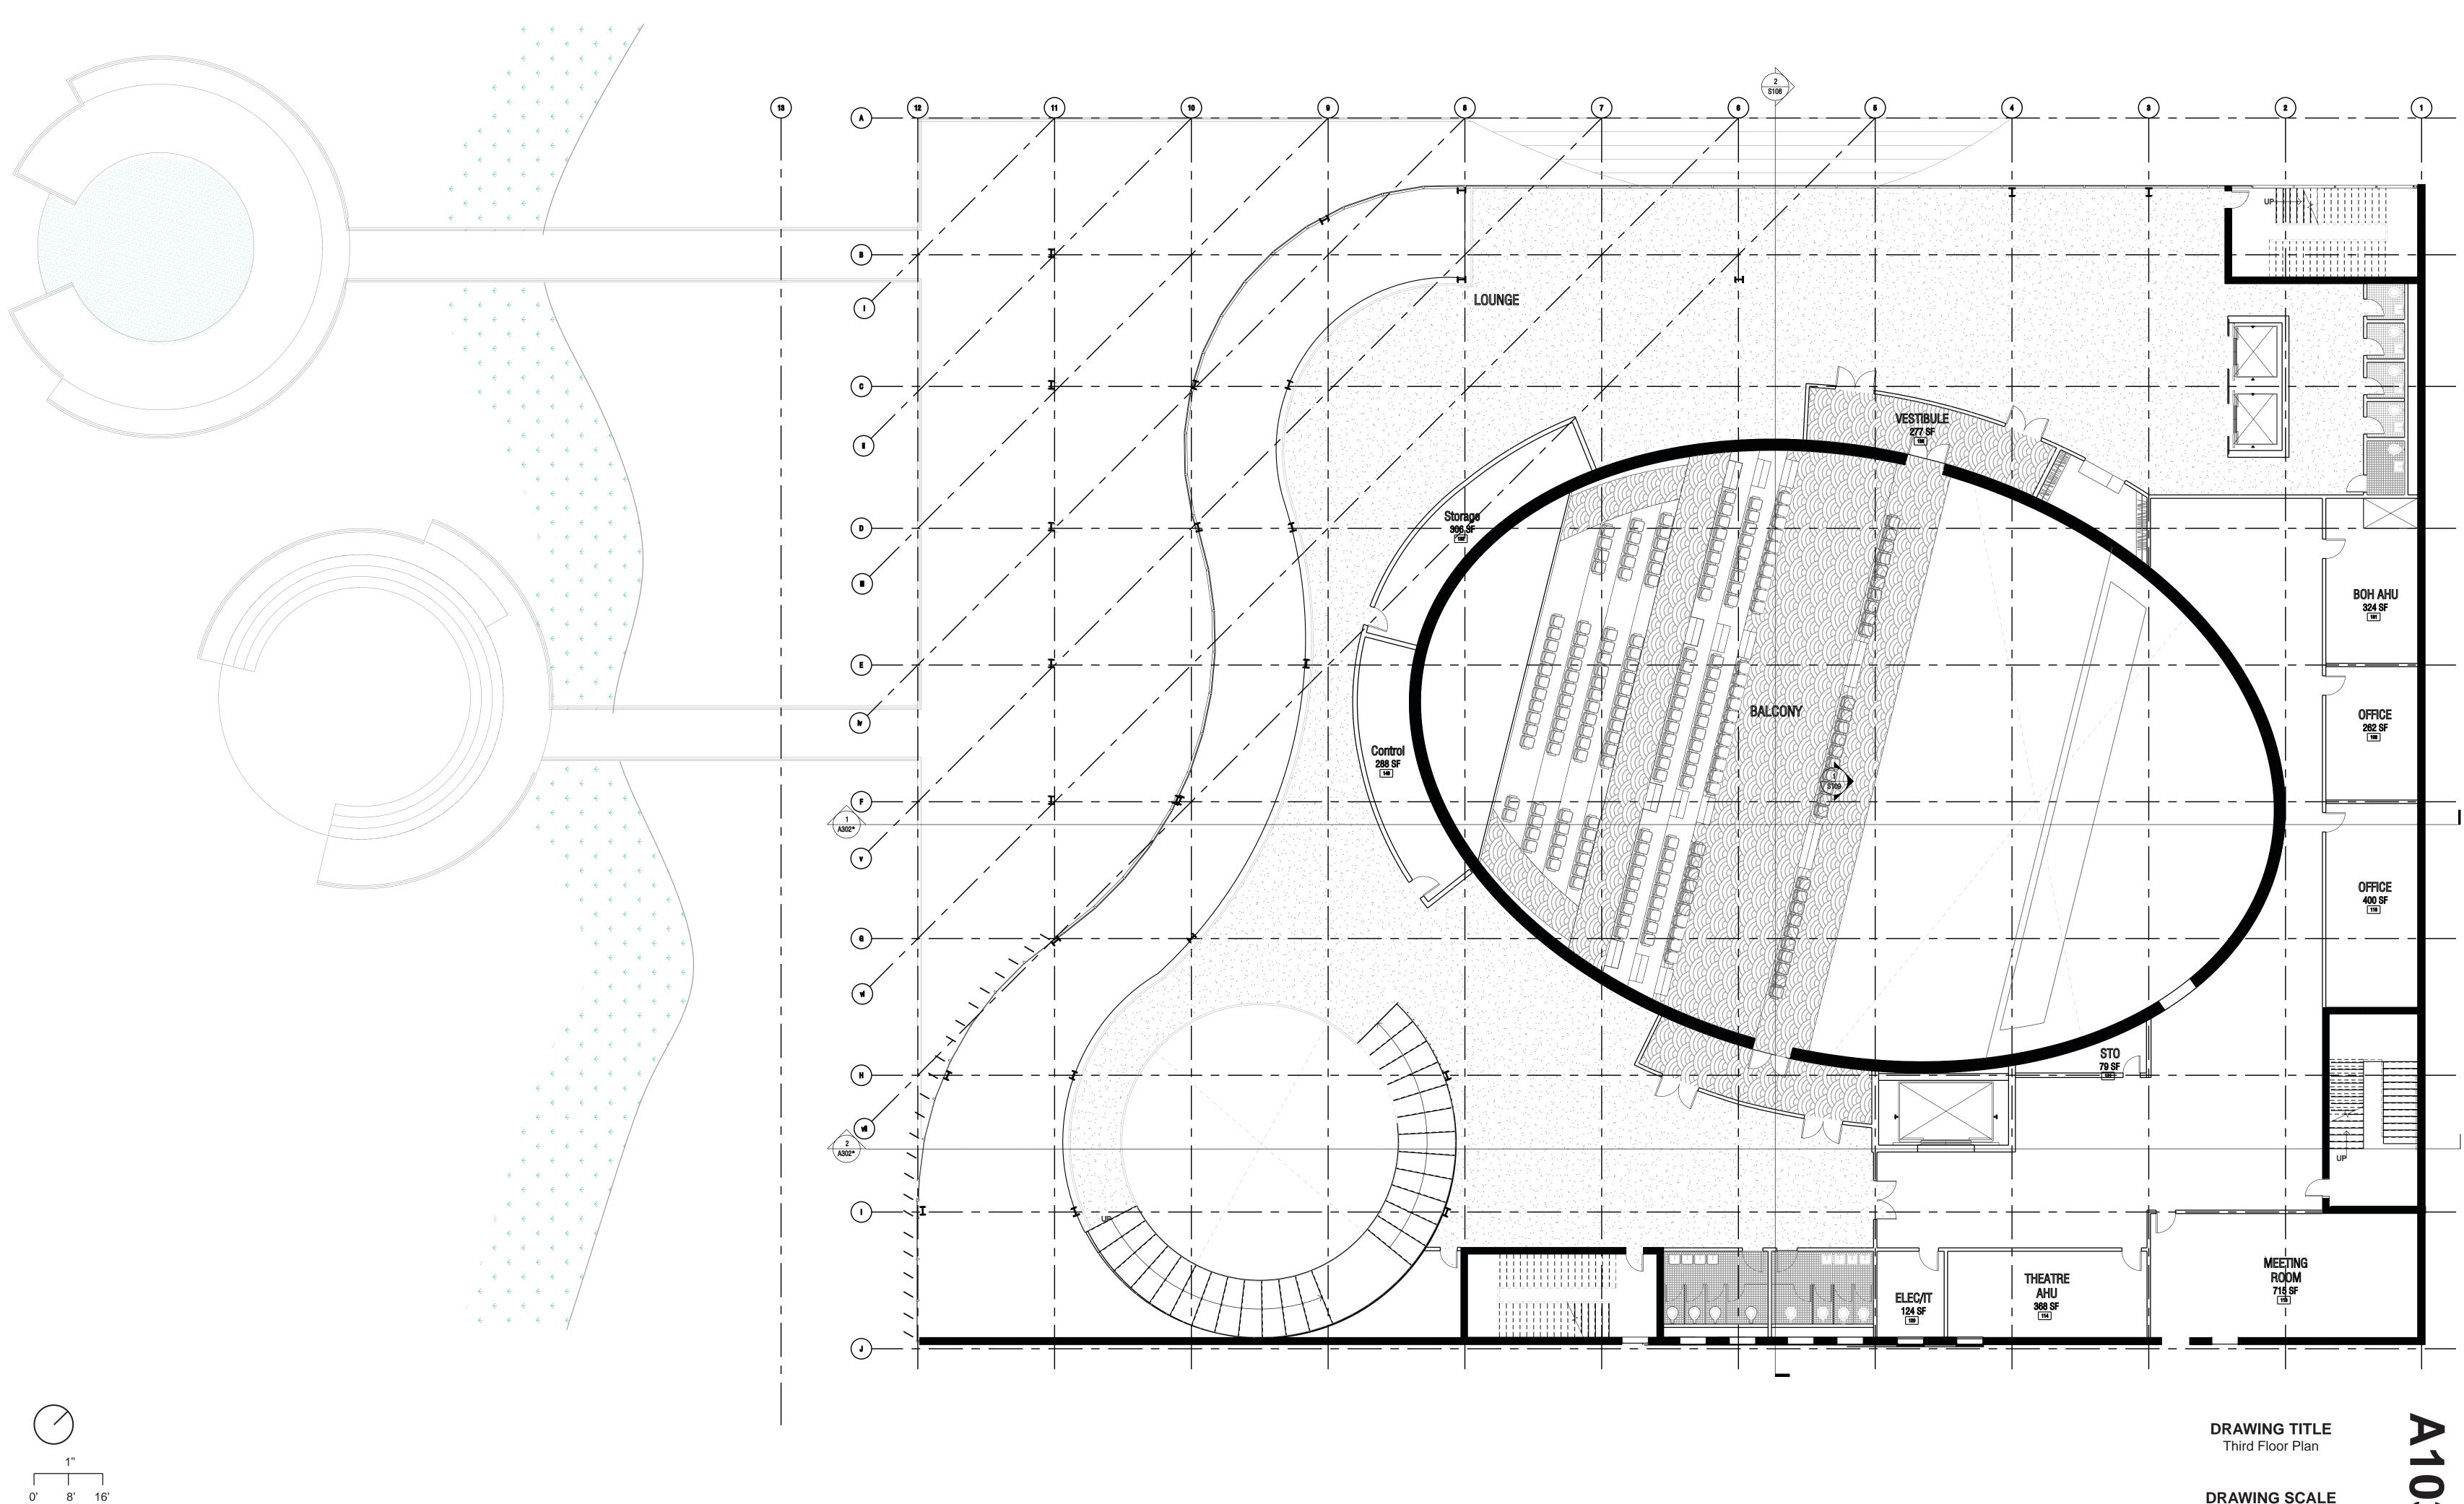

03

DRAWING SCALE 1/8": 1'-0"

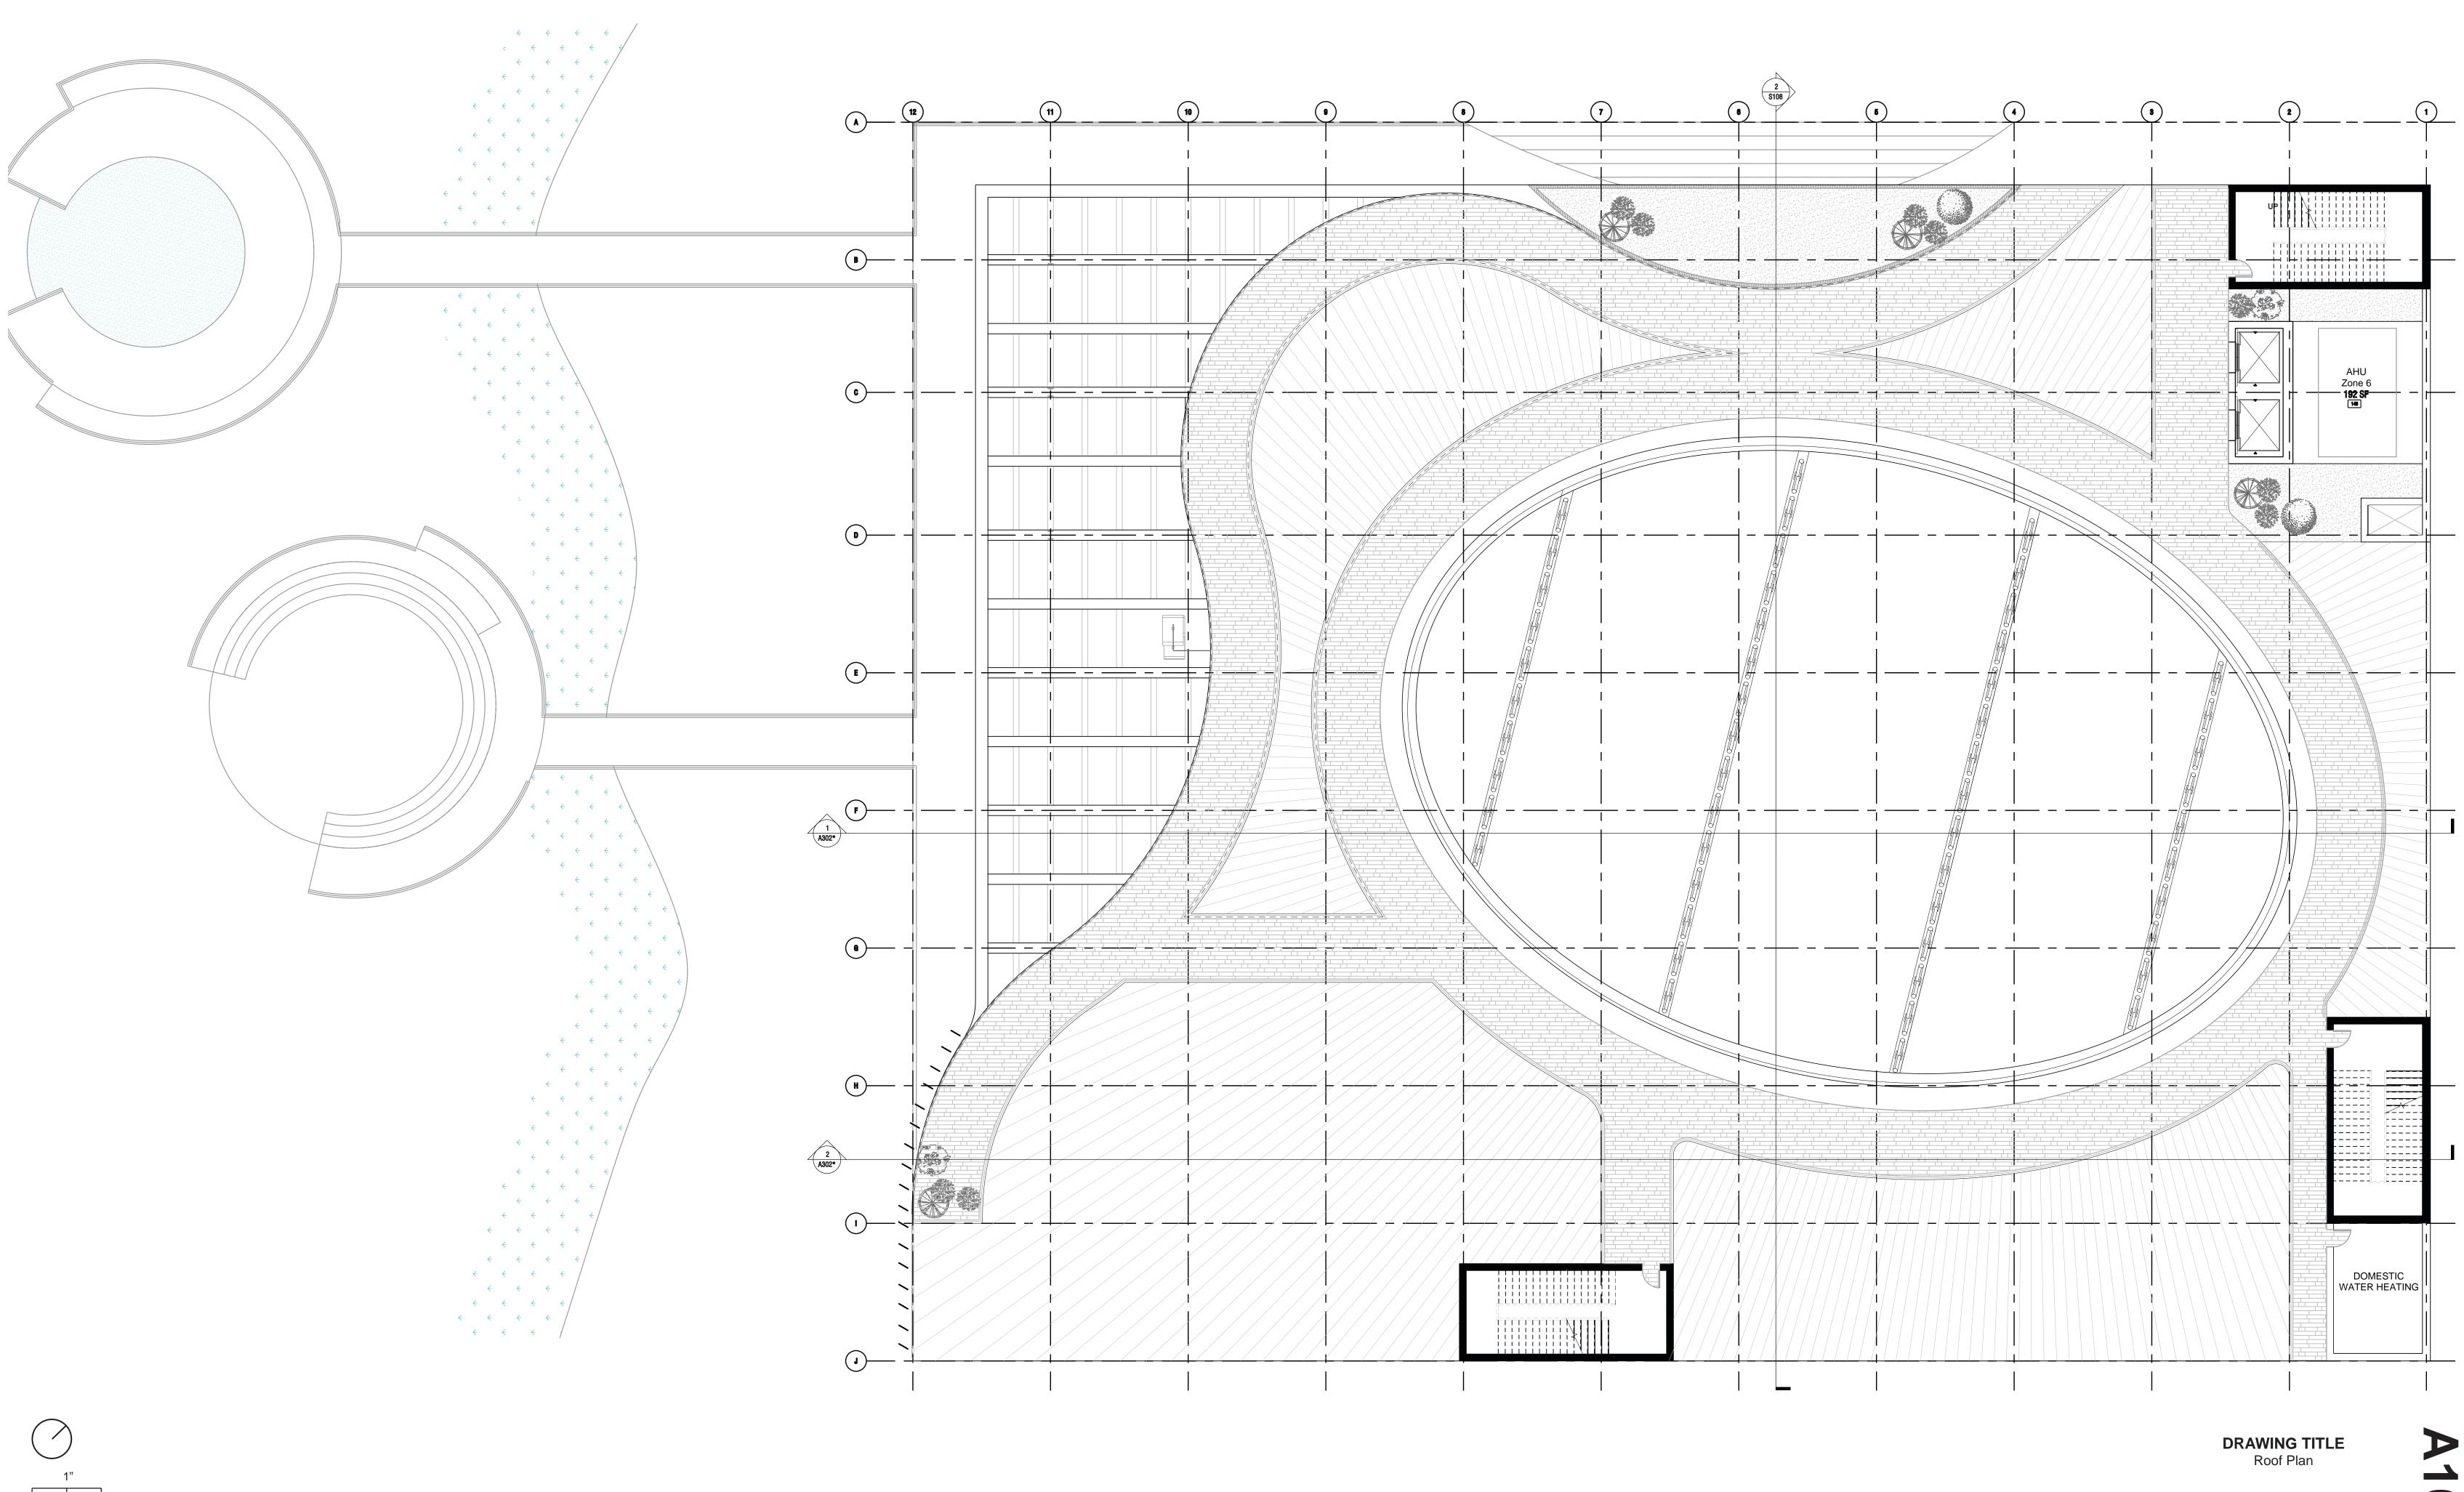



0' 8' 16'

04


DRAWING SCALE 1/8":1'-0"

LEVEL 1 - MOSS MATS & BIRD BEST INSTALLATION 1/2" = 1'-0"

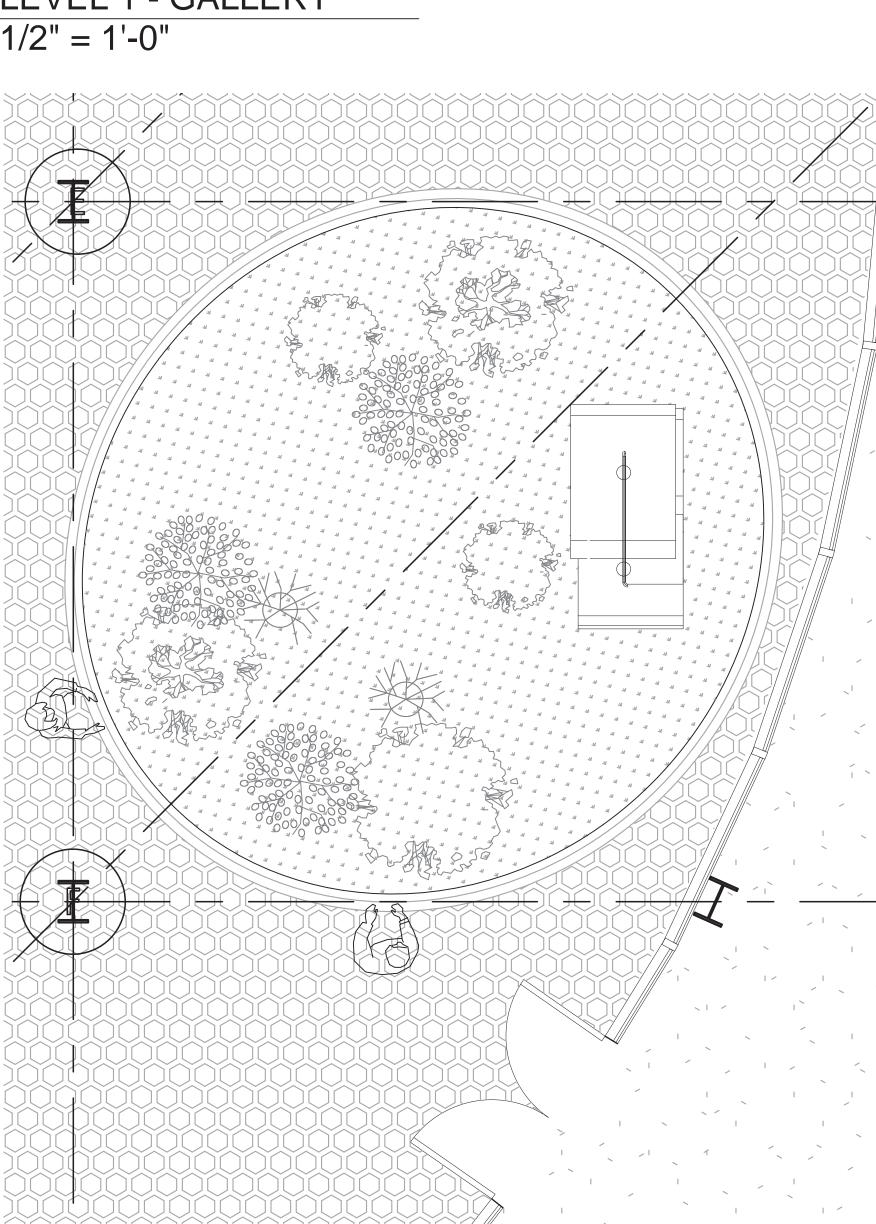

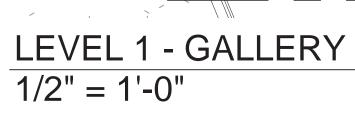



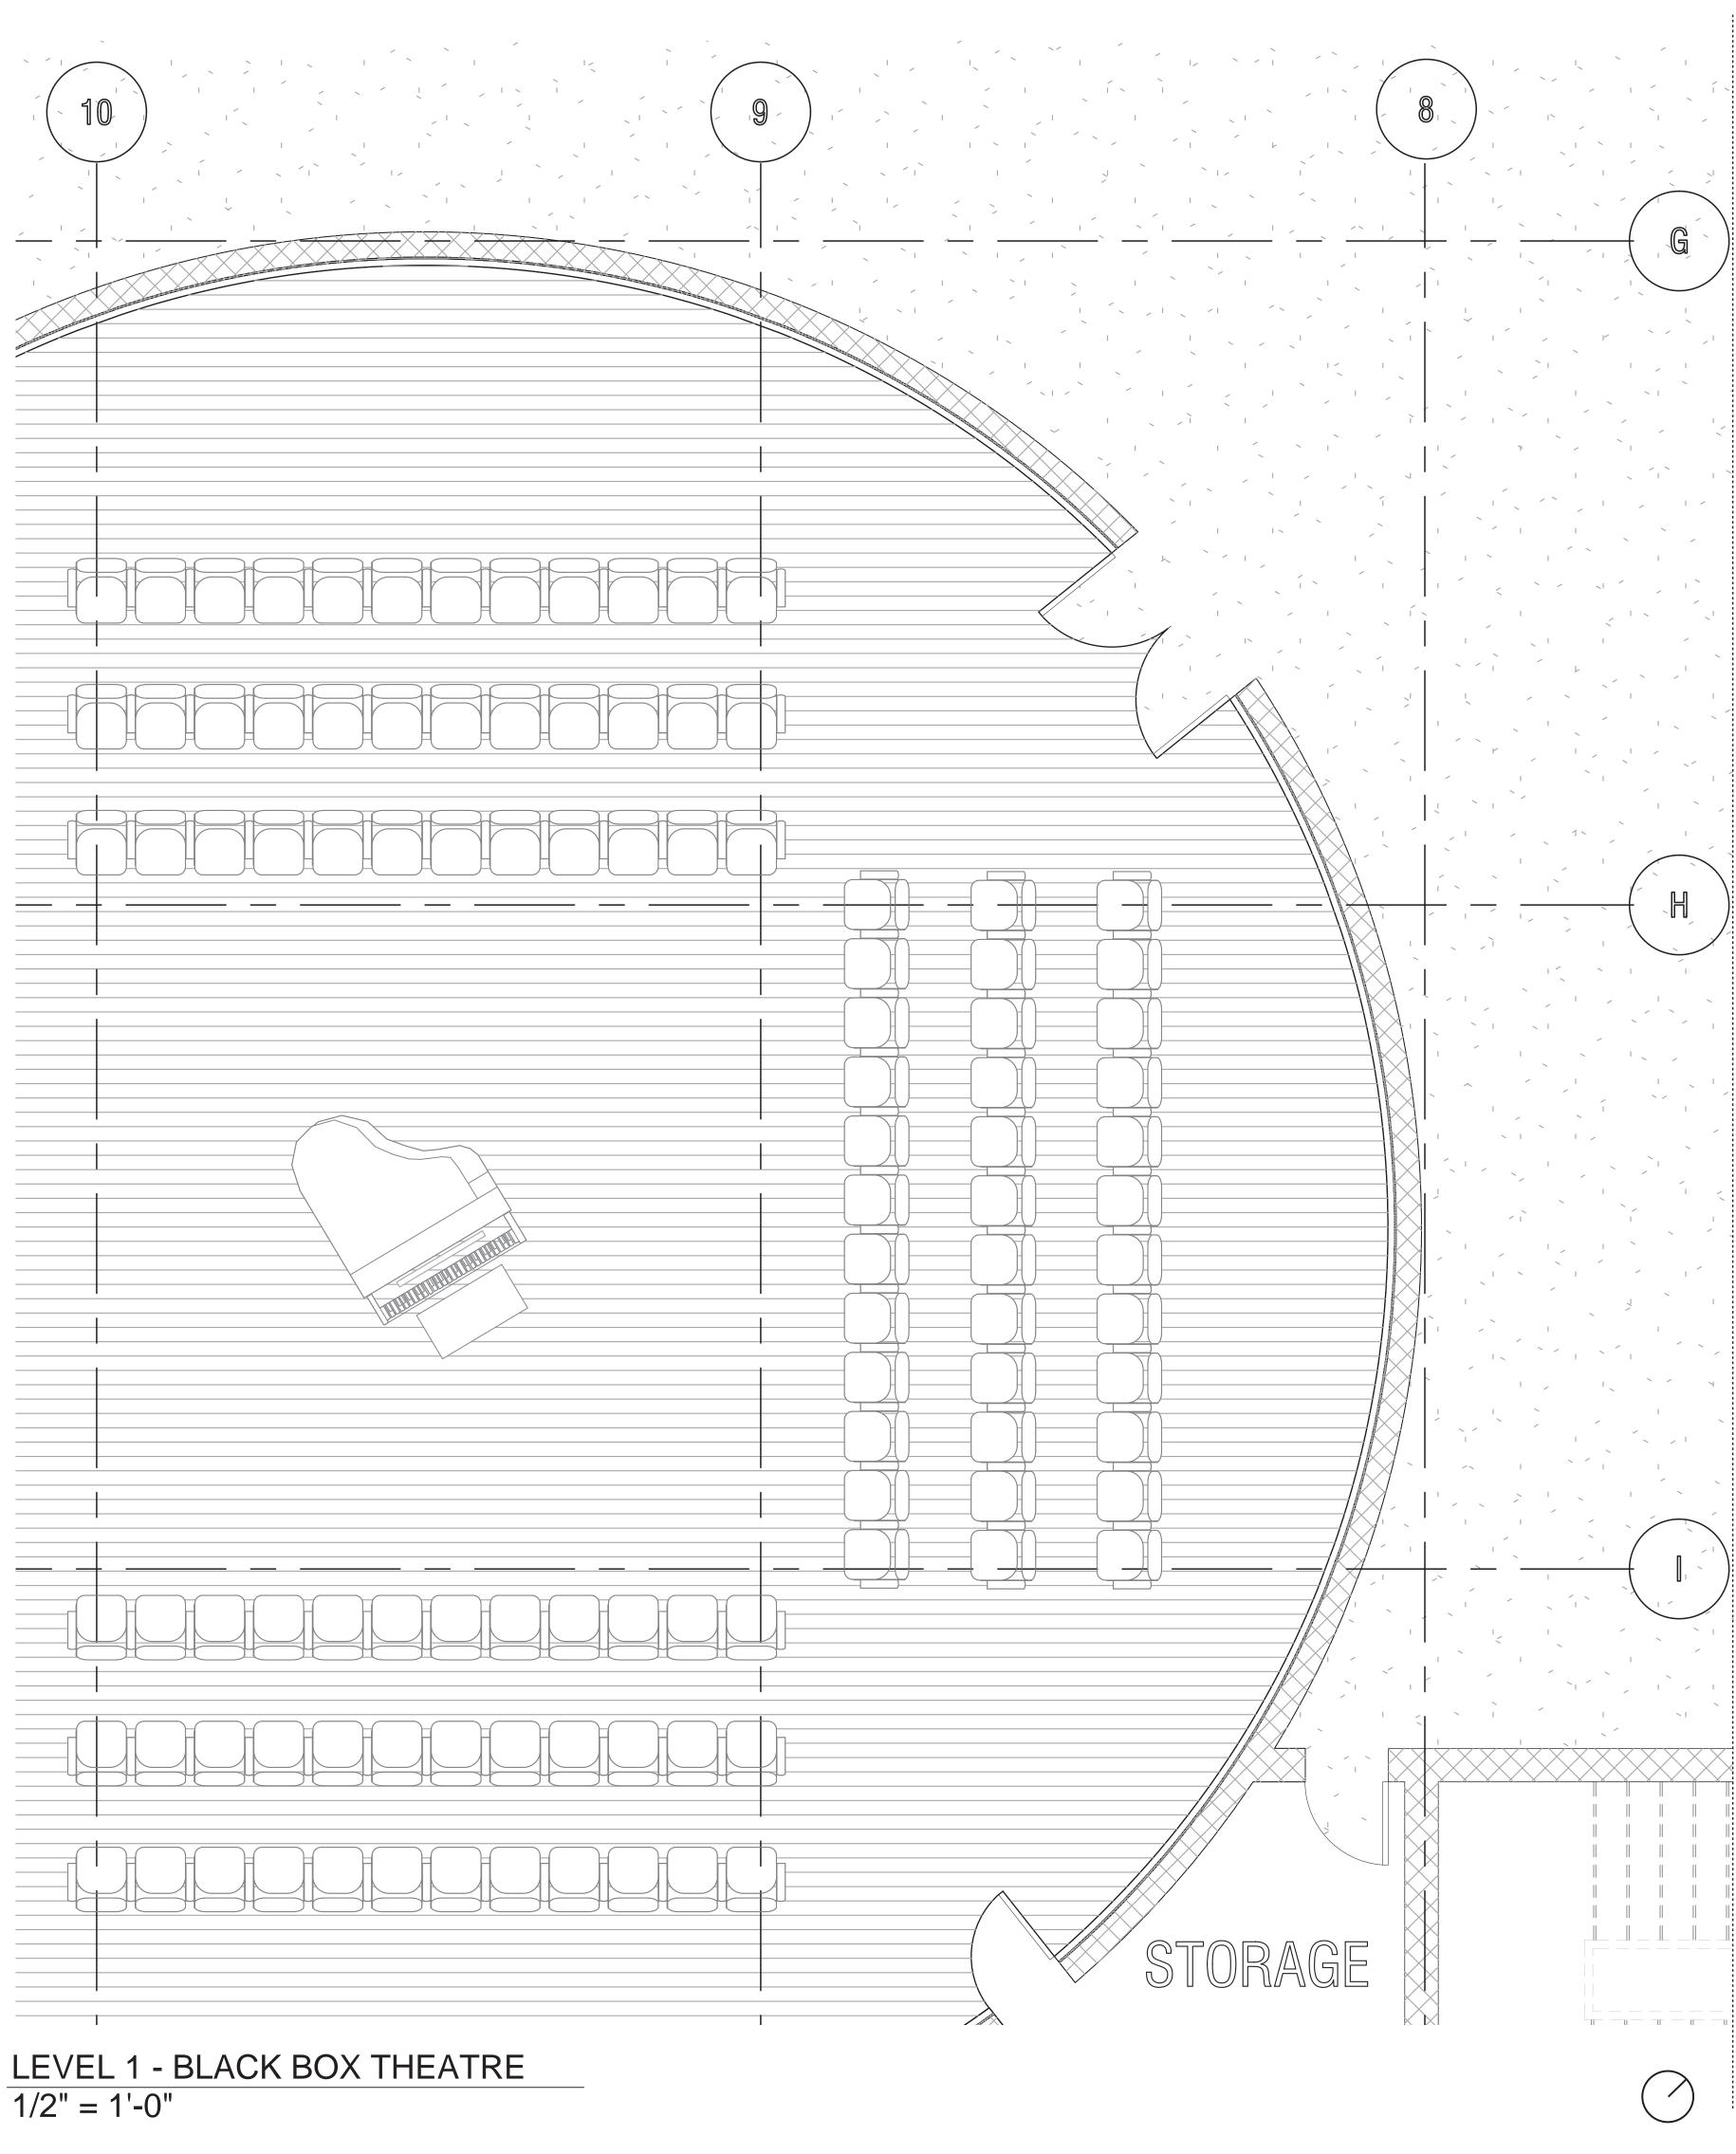



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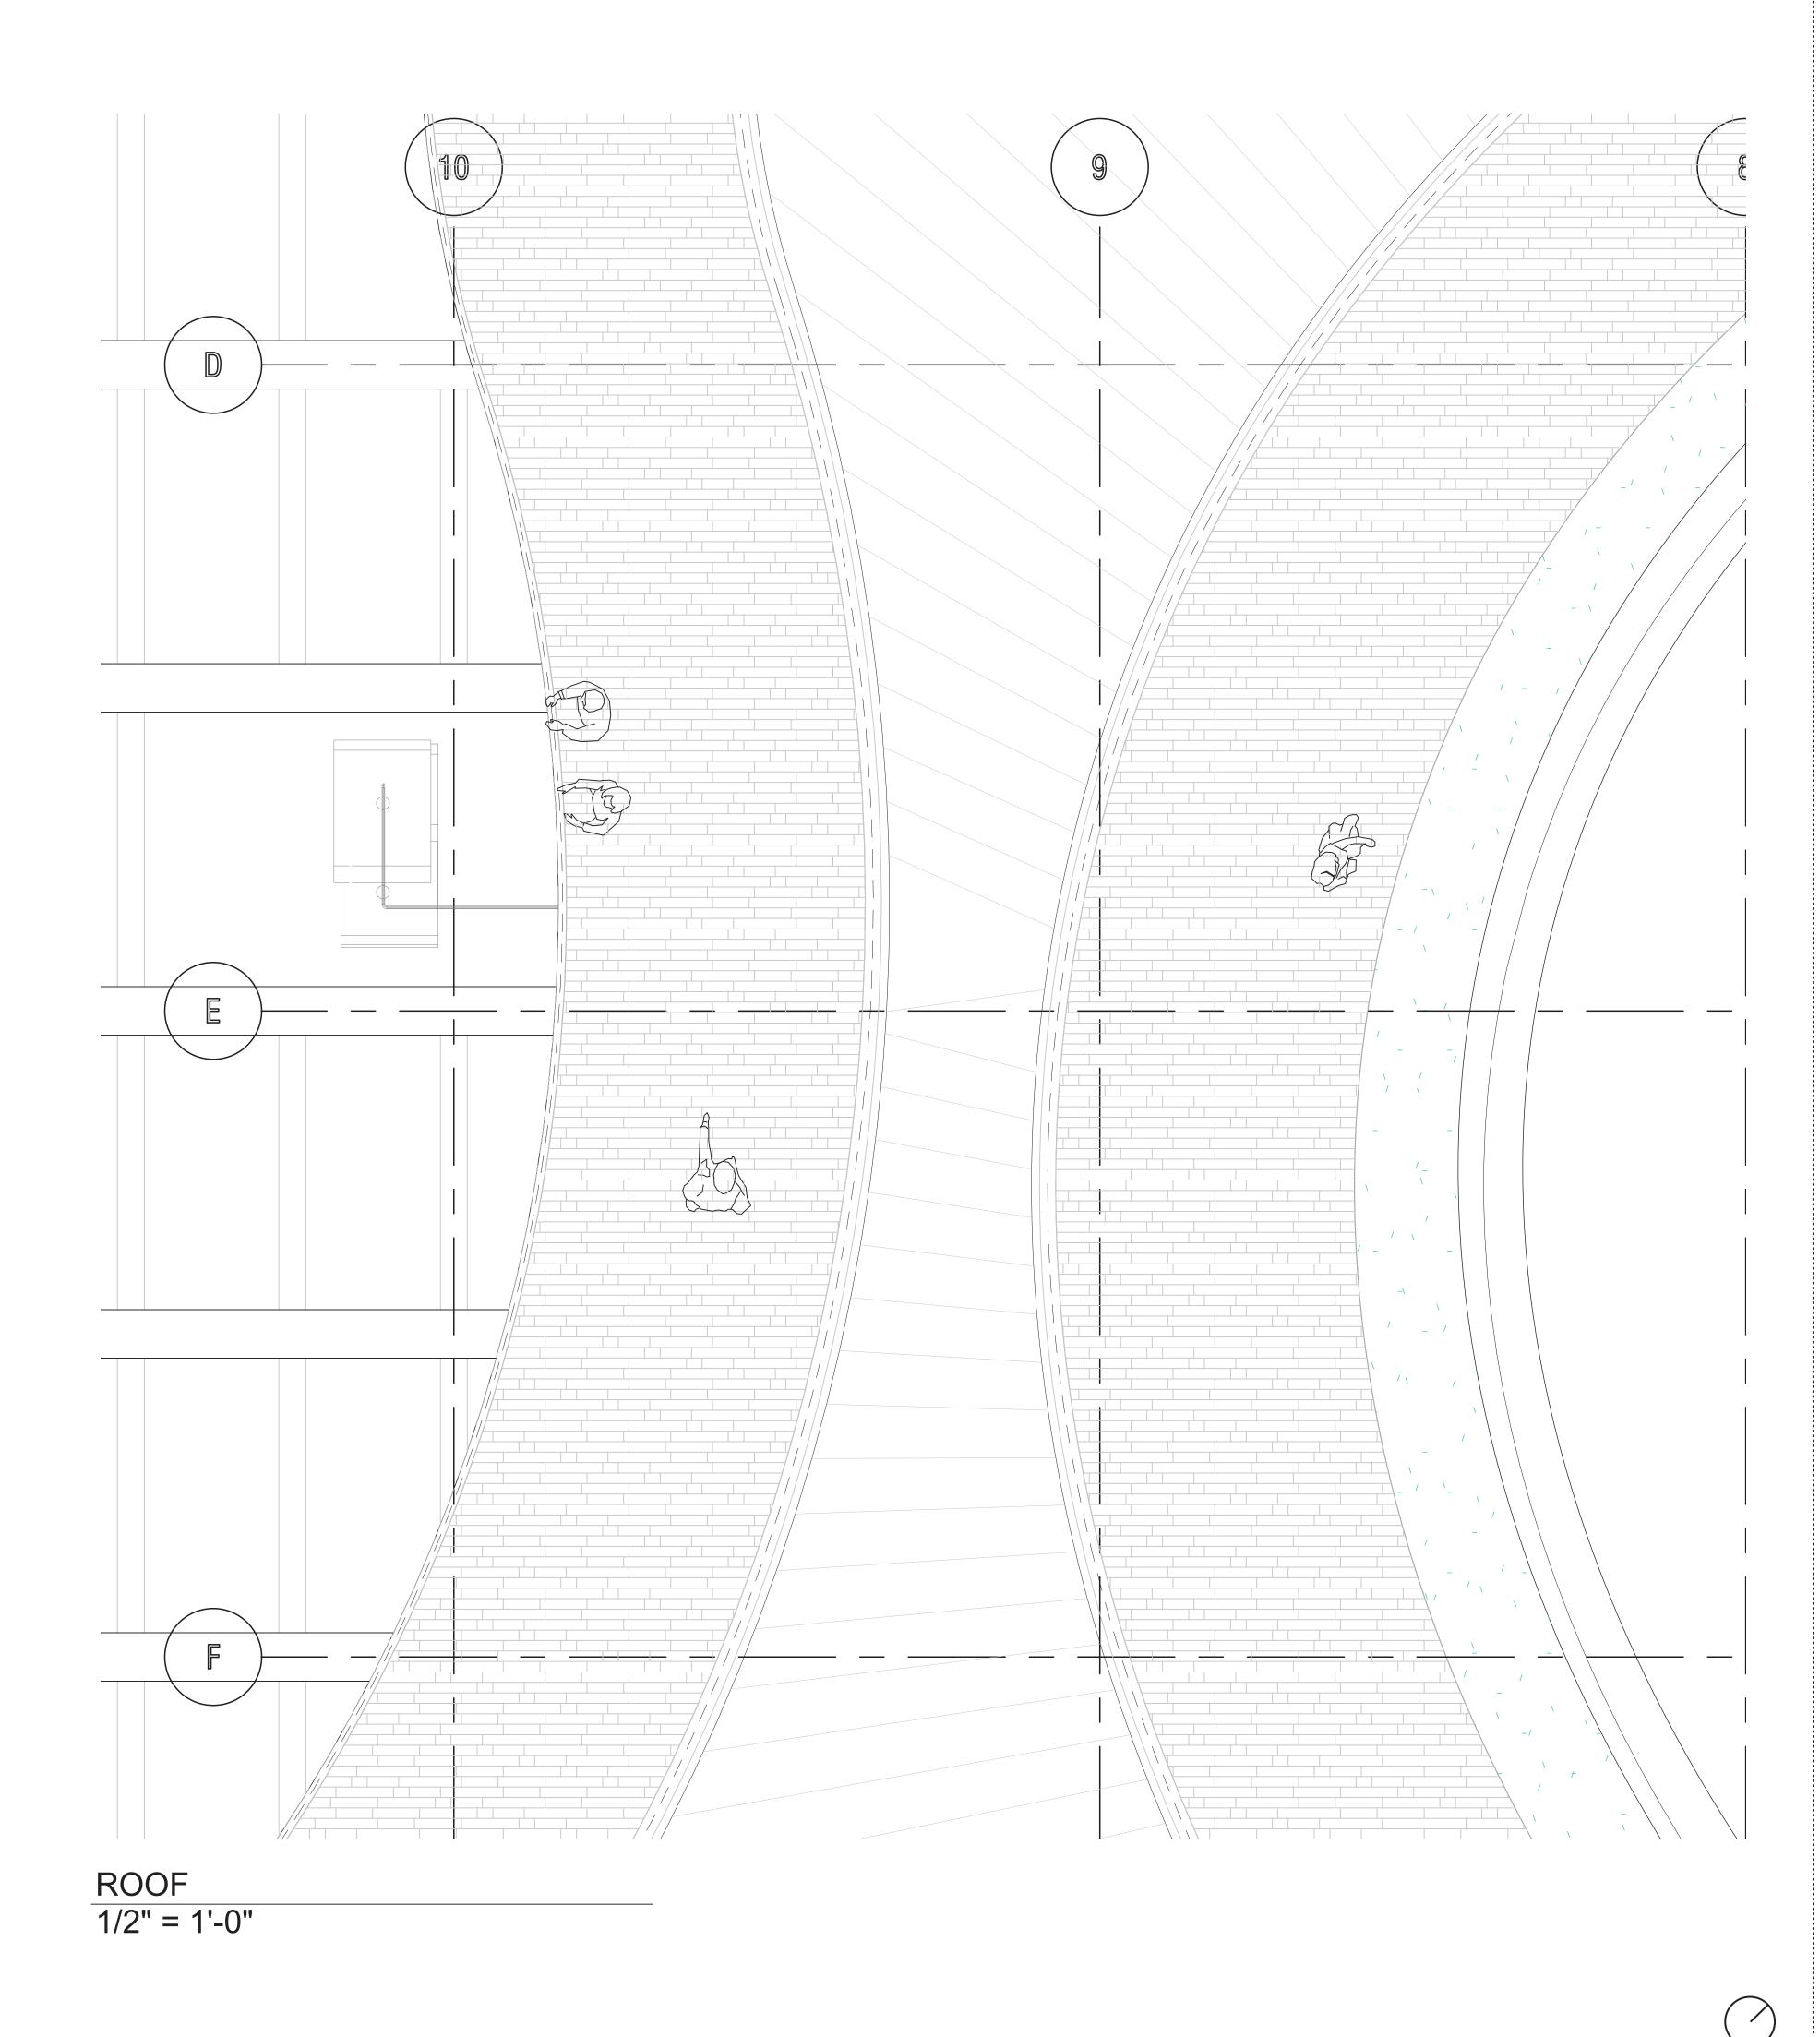
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DRAWING TITLE Floor Plan, Scaled

DRAWING SCALE 1/4":1'-0"

05





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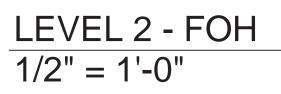
PROJECT


Greenpoint Theater 18 Greenpoint Ave. Brooklyn, NY 11222


DRAWING TITLE Floor Plan, Scaled

DRAWING SCALE 1/4":1'-0"

 \triangleright **06**



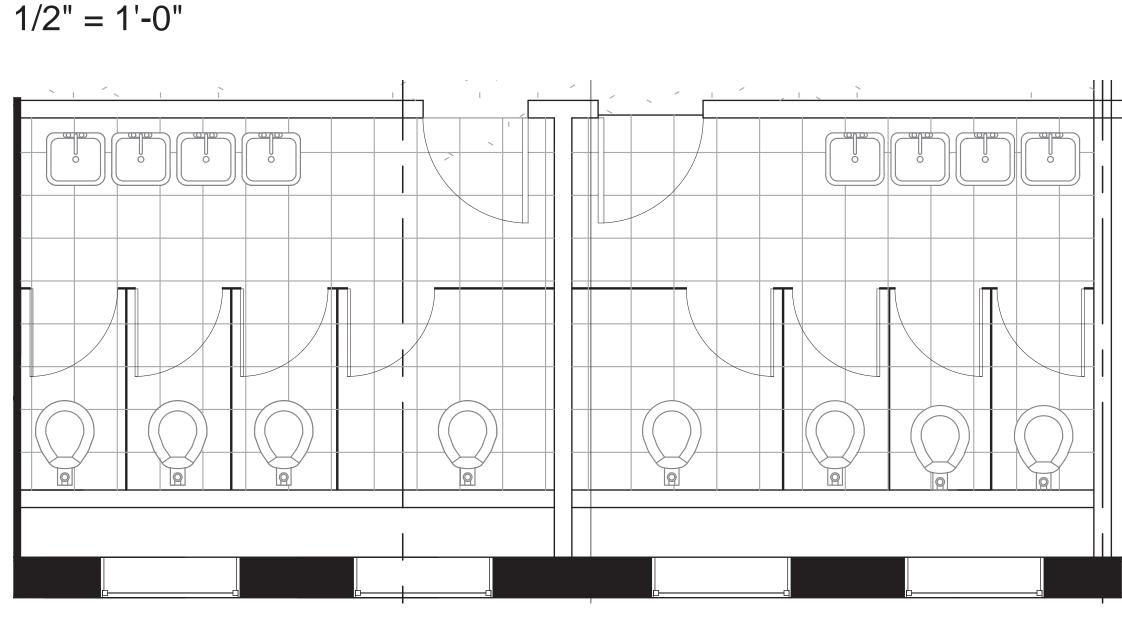

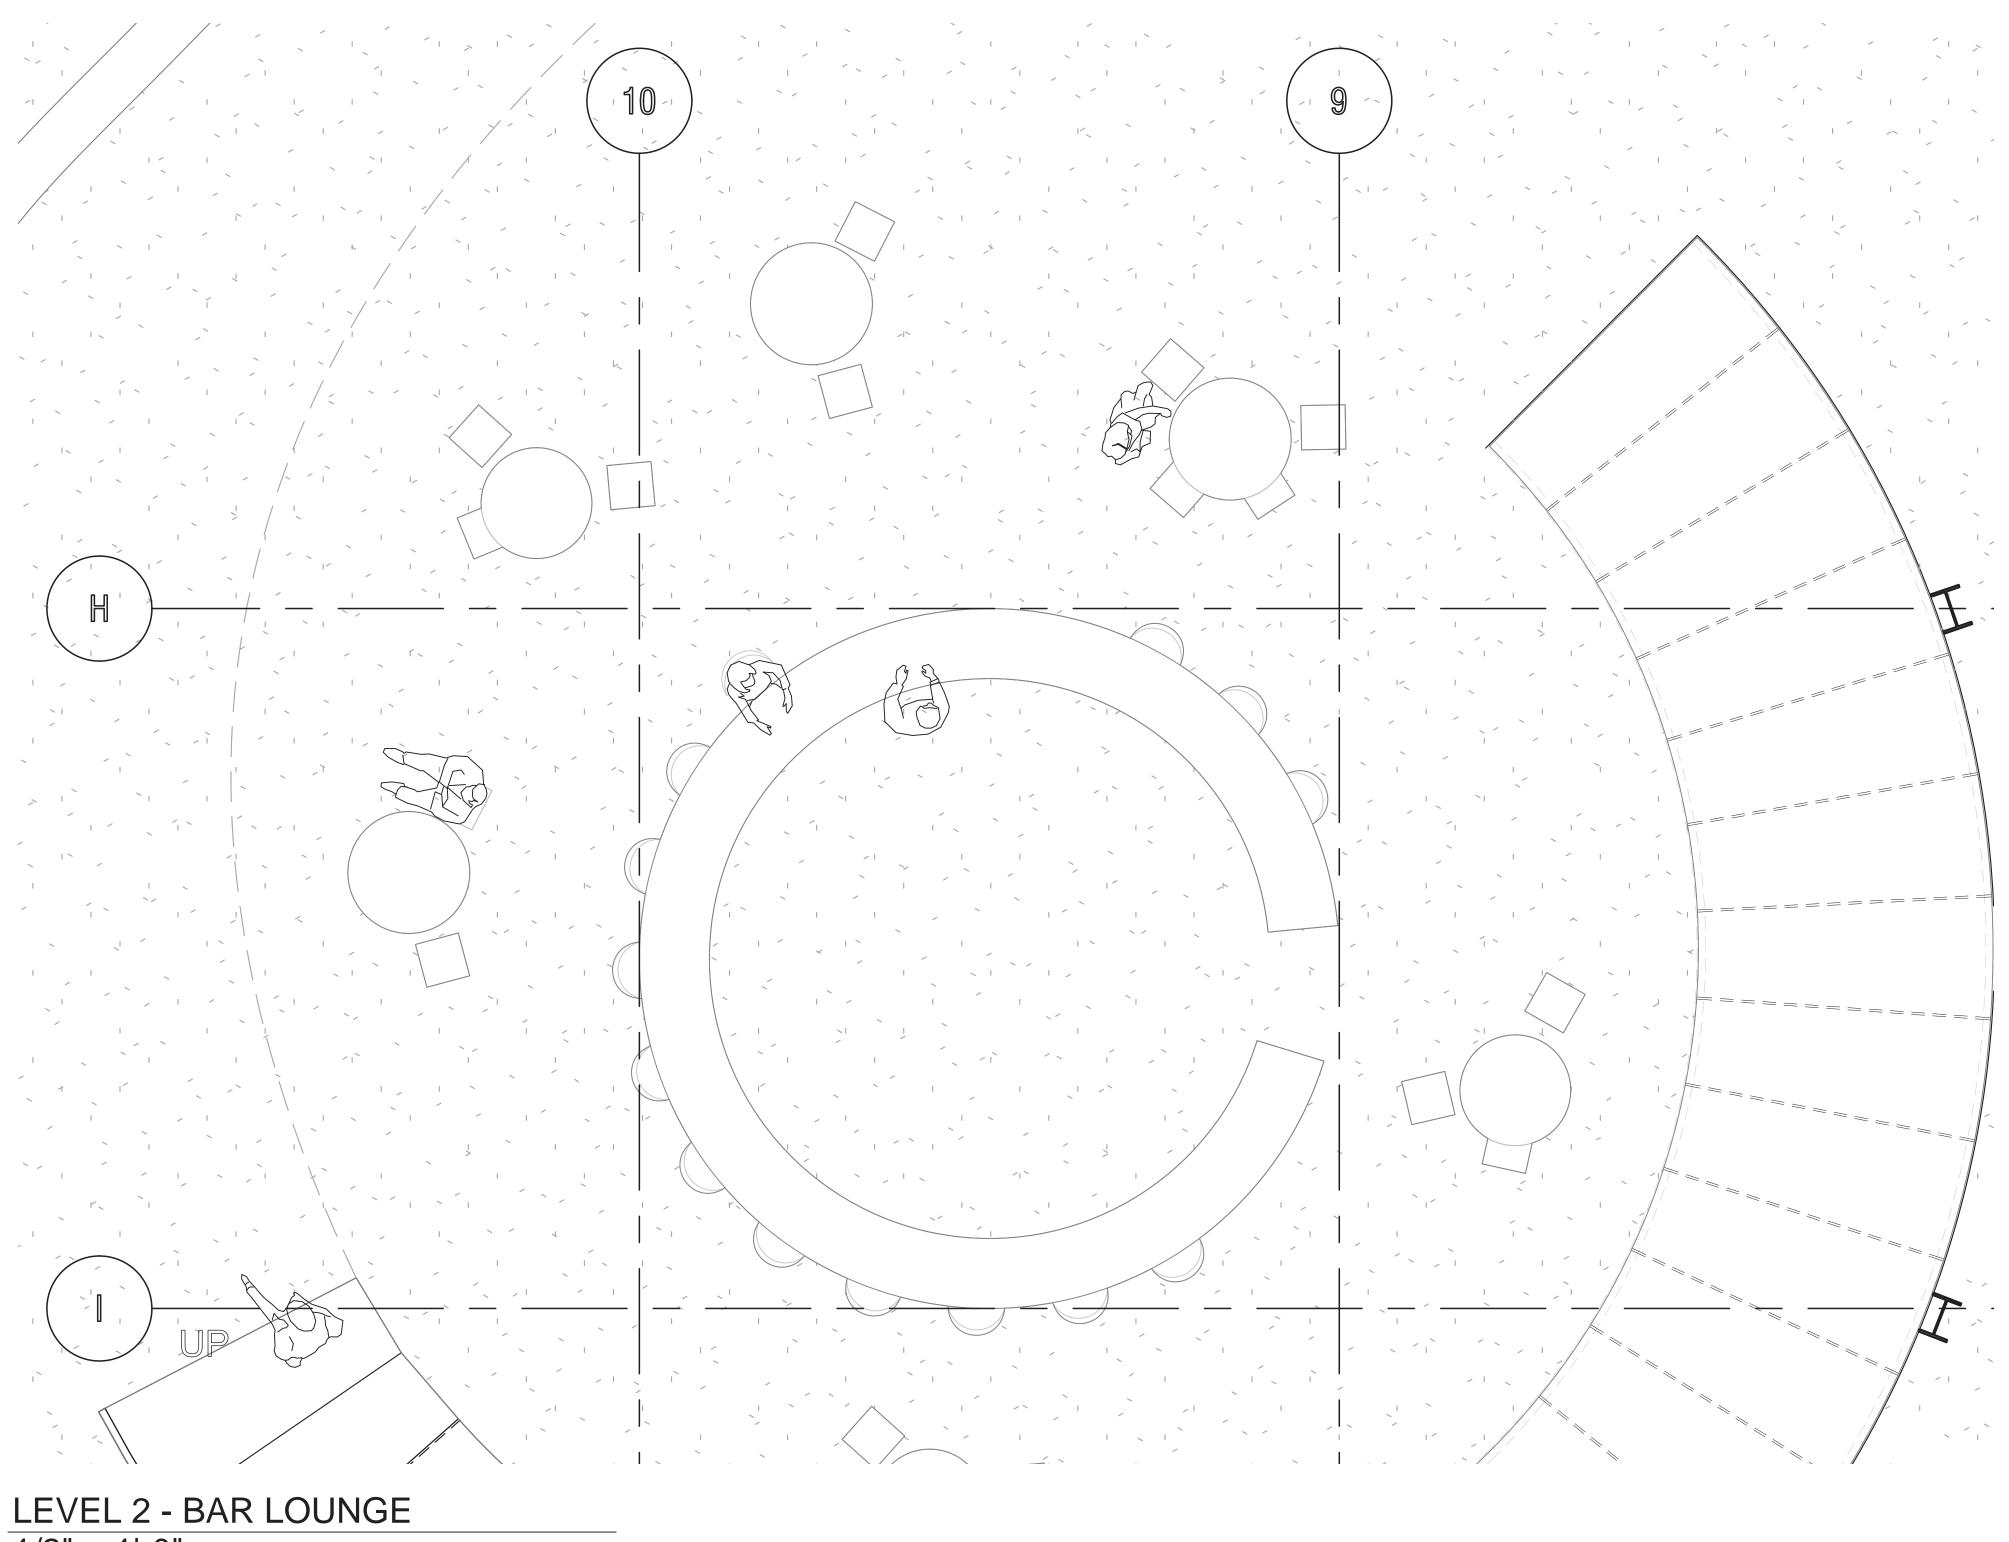



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DRAWING TITLE Floor Plan, Scaled


DRAWING SCALE 1/4": 1'-0"

A107





(2) NORTH ELEVATION, 1' - 0" : 1/16"

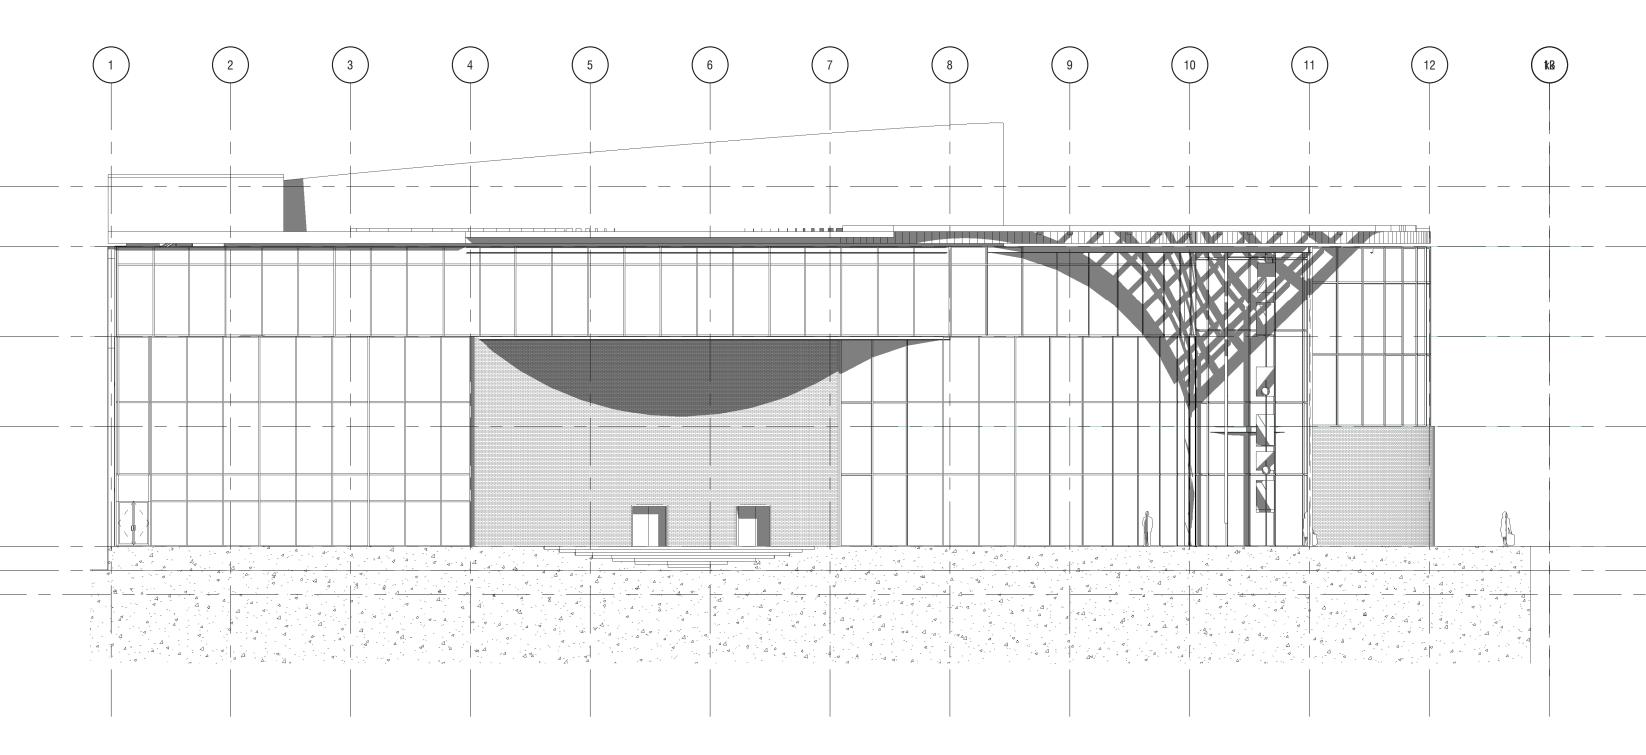



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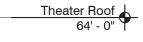
> PROJECT Greenpoint Theater 18 Greenpoint Ave. Brooklyn, NY 11222

DRAWING TITLE Building Elevations, N/S

DRAWING SCALE 1/16" : 1'-0"

ISSUE DATE December 13, 2019

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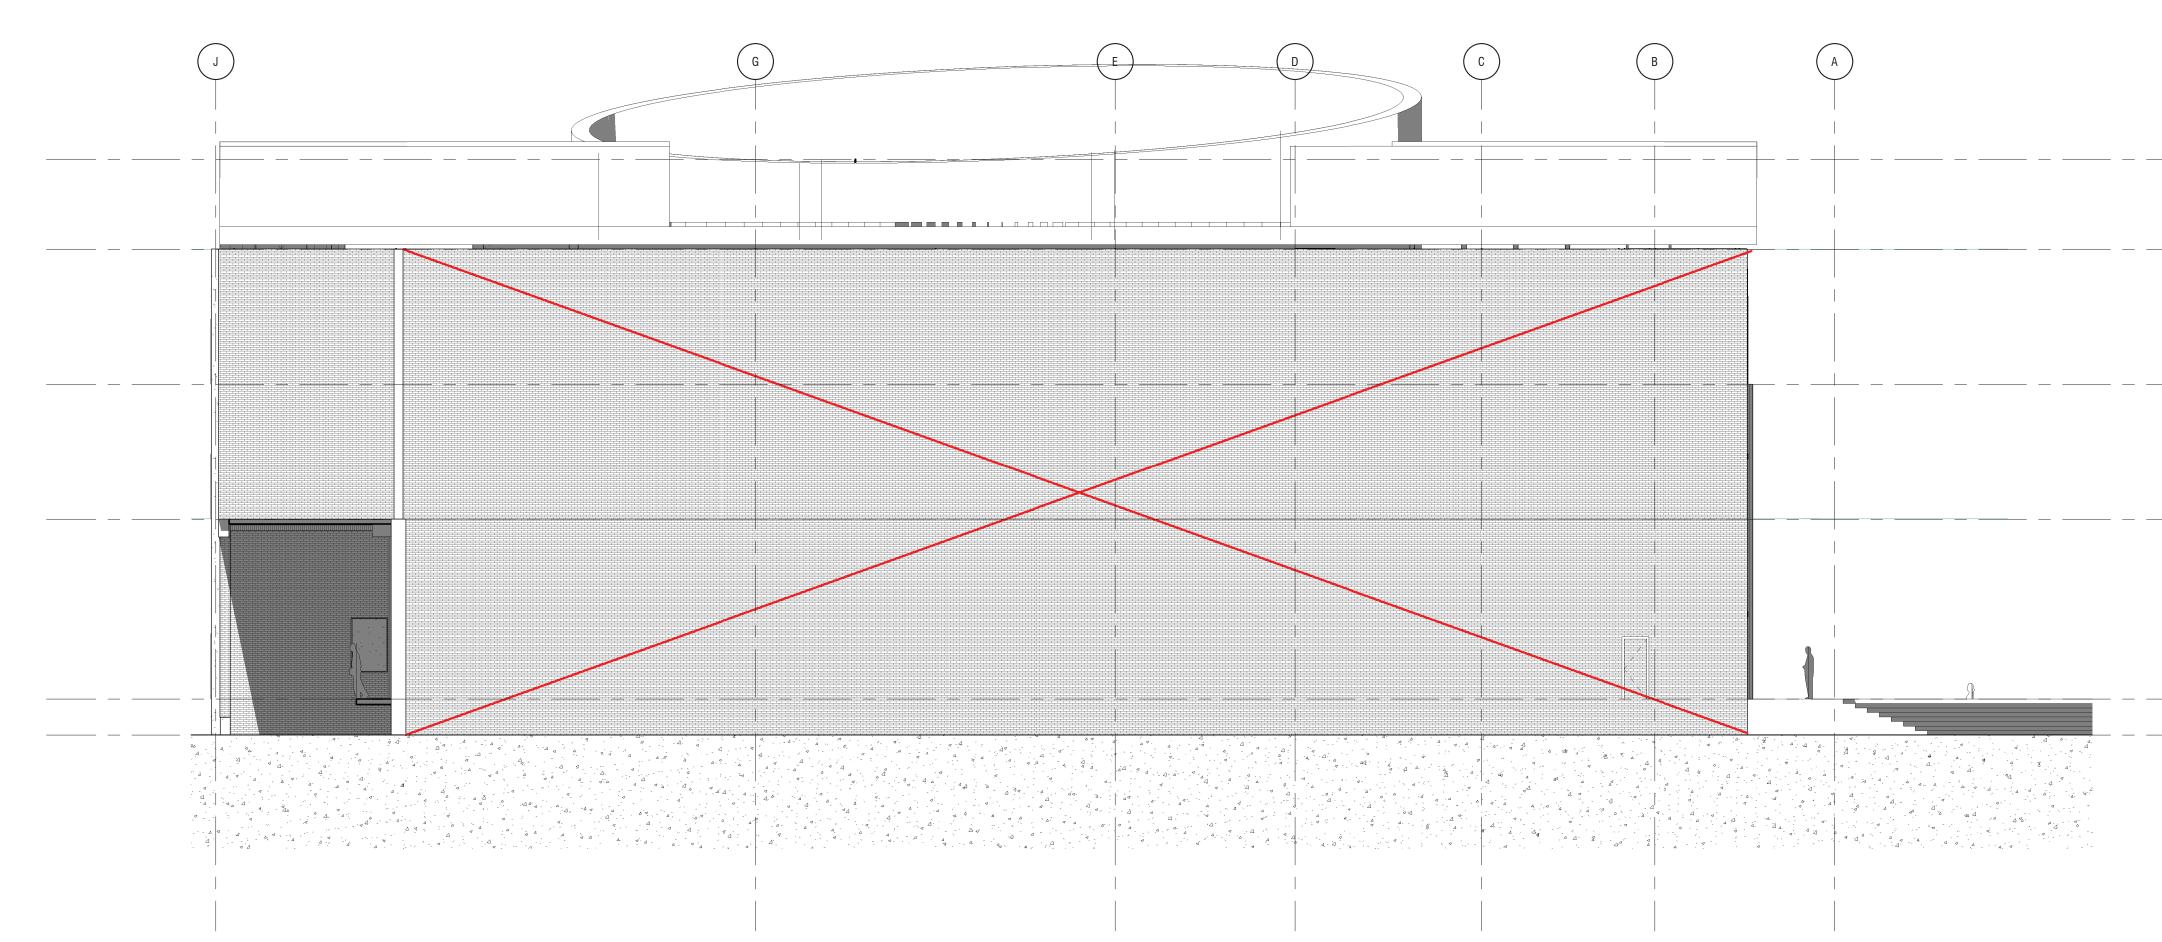


Roof 54' - 0"




Second Floor 24' - 0"

First Floor 4' - 0" 0 0' - 0" Water Level -4' - 0"



(2) EAST ELEVATION, 1' - 0" : 3/32"

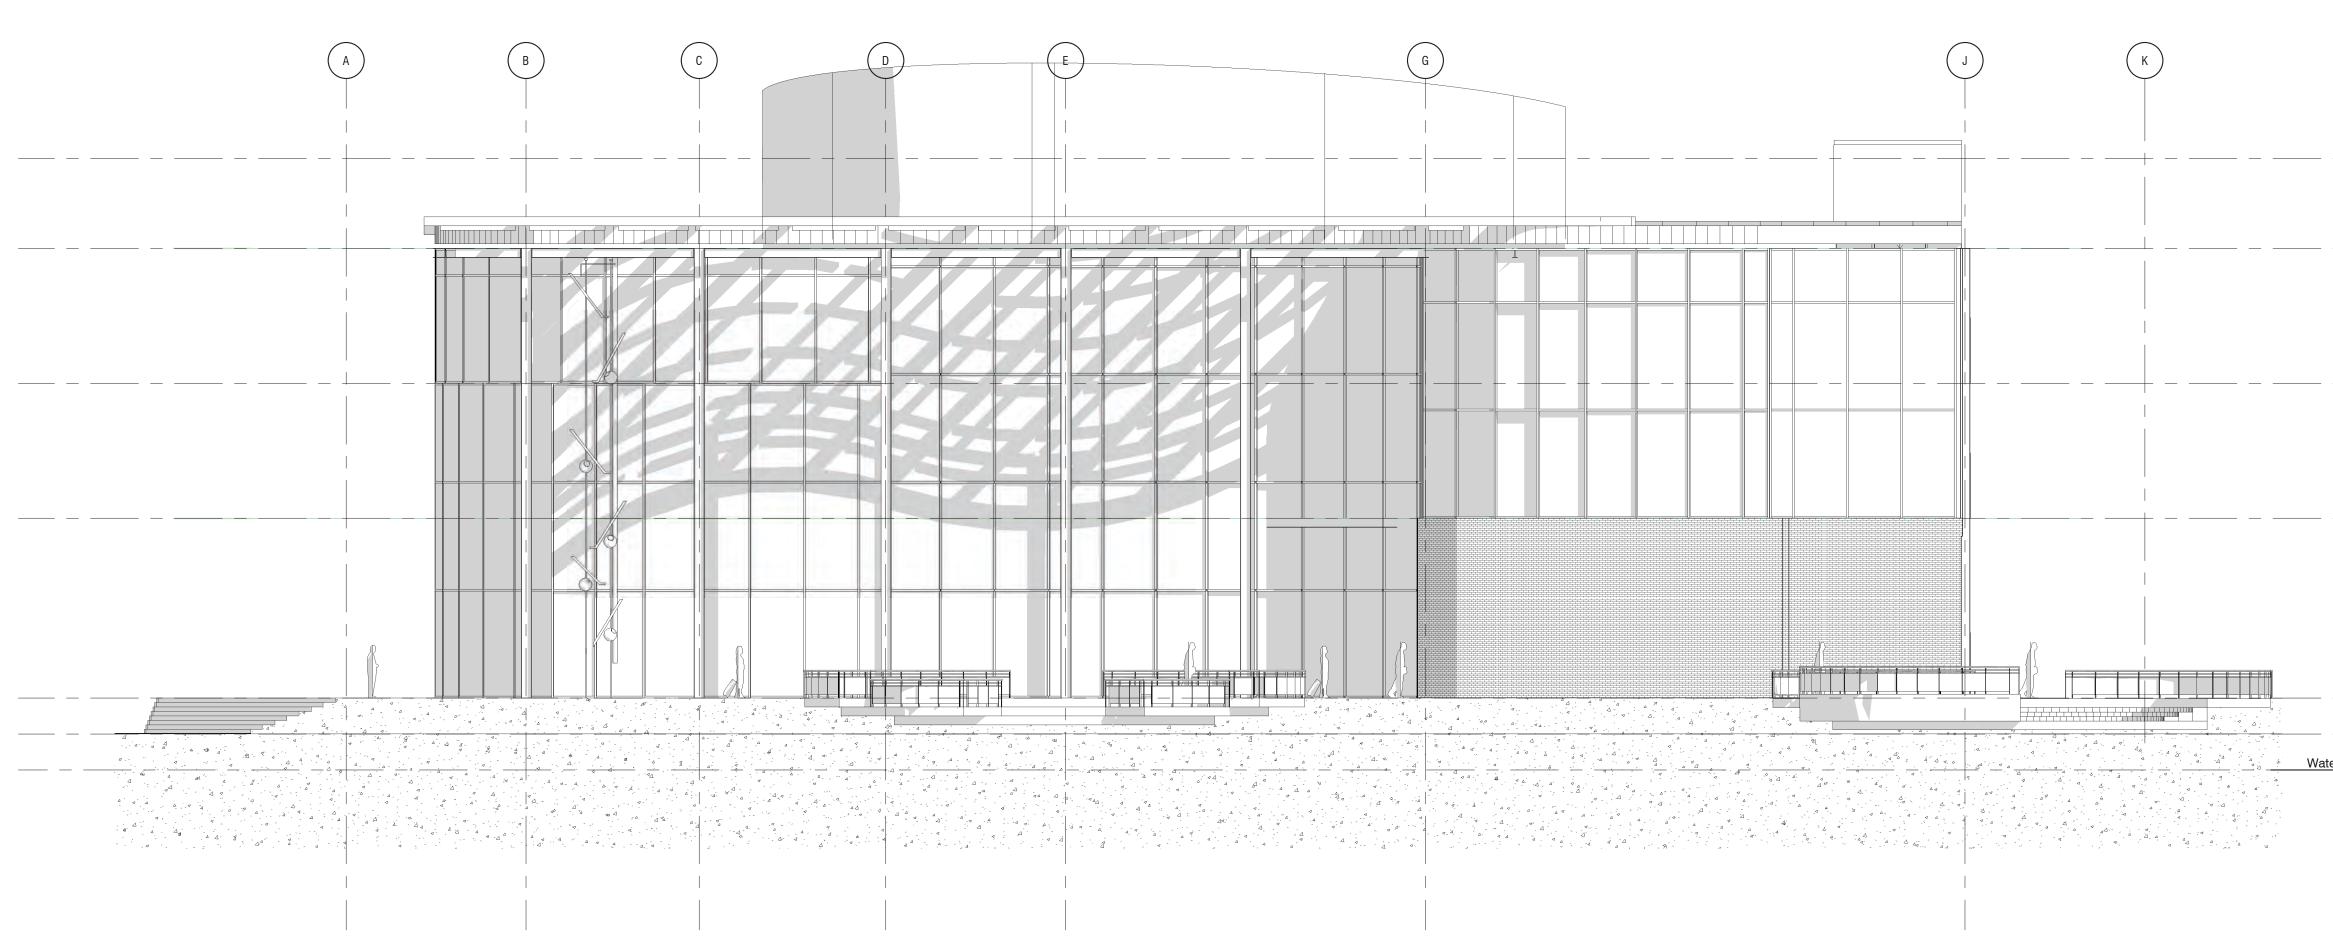


(1) WEST ELEVATION, 1' - 0" : 3/32"

Theater Roof 64' - 0"	THE CEILING-TO-FLOOR
	DESIGN GROUP
Roof 54' - 0"	DAVID MUSA - LUIS MIGUEL PIZANO - TIANYU YANG - REEM YASSIN
	ADDRESS Columbia University
<u>Third Floor</u> 39' - 0"	Graduate School of Architecture, Planning and Preservation
	1172 Amsterdam Ave New York, NY 10027
Second Floor	·····, ···
24' - 0"	
	PROJECT TEAM
	ARCHITECTURE TECHNICAL CONSULTING JOSEPH HAND
	Shop Architects 233 Broadway 11th Floor
4' - 0" 0' - 0"	New York, NY 10279
	STRUCTURAL AMY HARRINGTON PE
	Silman 32 Old Slip
	New York, NY 10005
	MECHANICAL & SUSTAINABILITY JONCE WALKER LEED AP CSBA
	Thornton Tomasetti, Inc. 51 Madison Ave New York, NY 10010
	New York, NY 10010 ENCLOSURE
	KATHERINE CHAN Walter P Moore
	180 Maiden Ln #803 New York, NY 10038
<u>Theater Roof</u> 64' - 0"	
64' - 0" ▼	
	100%
	CONSTRUCTION
	DOCUMENTS
<u>Third Floor</u> 39' - 0"	
	PRELIMINARY, NOT FOR CONSTRUCTION
<u>Second Floor</u> 24' - 0"	
	Drawings and specifications, as instruments of professional service, are and shall remain the Property of the designers. These documents are not to be used, in whole or in part, for
	any other projects or purposes, or by any other parties than those properly authorized by contract, without the specific written authorization of its owners.
First Floor	
4' - 0" • 	PROJECT
Vater Level	Greenpoint Theater 18 Greenpoint Ave.
	Brooklyn, NY 11222
	DRAWING TITLE
	Building Elevations, E/W

DRAWING SCALE 3/32" : 1'-0"

A202

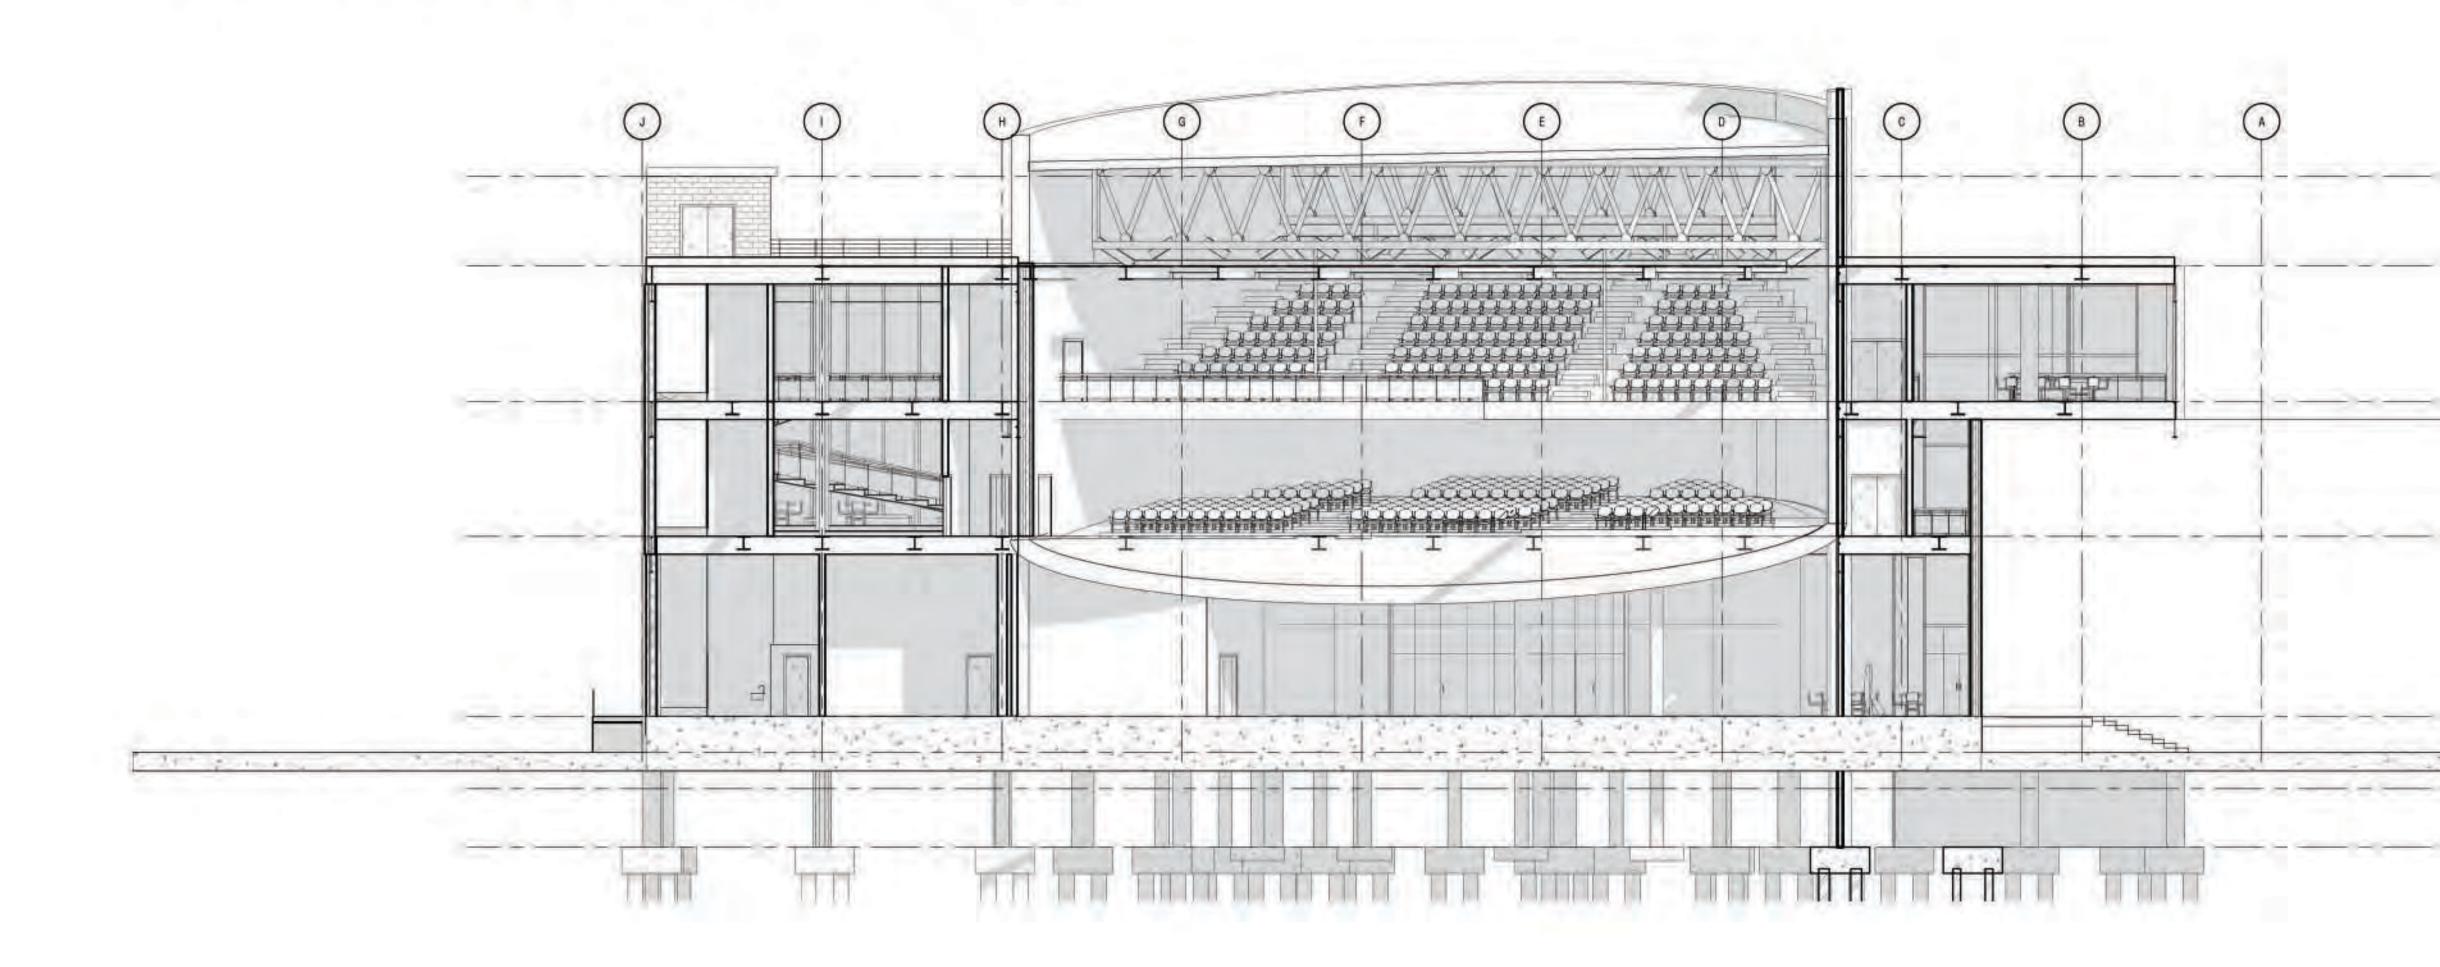

1"

0' 16' 32'

TRANSVERSE BUILDING SECTION Cut Through Front-of-House, Theater & Back-of-House



THE **CEILING-TO-FLOOR** DESIGN GROUP

DAVID MUSA - LUIS MIGUEL PIZANO - TIANYU YANG - REEM YASSIN

ADDRESS

Columbia University Graduate School of Architecture, Planning and Preservation 1172 Amsterdam Ave New York, NY 10027

PROJECT TEAM

ARCHITECTURE TECHNICAL CONSULTING

JOSEPH HAND Shop Architects 233 Broadway 11th Floor New York, NY 10279

STRUCTURAL AMY HARRINGTON PE Silman 32 Old Slip New York, NY 10005

MECHANICAL & SUSTAINABILITY

JONCE WALKER LEED AP CSBA Thornton Tomasetti, Inc. 51 Madison Ave New York, NY 10010

ENCLOSURE KATHERINE CHAN

Walter P Moore 180 Maiden Ln #803 New York, NY 10038

100% CONSTRUCTION DOCUMENTS

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> PROJECT Greenpoint Theater 18 Greenpoint Ave. Brooklyn, NY 11222

DRAWING TITLE **Building Sections, N-S**

DRAWING SCALE 1/16":1'-0"

ISSUE DATE

December 13, 2019

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Theater Roof


Root \$


Third Floor

Second Floor

First Floor 0'-0"**9** Water Level

Ground Level

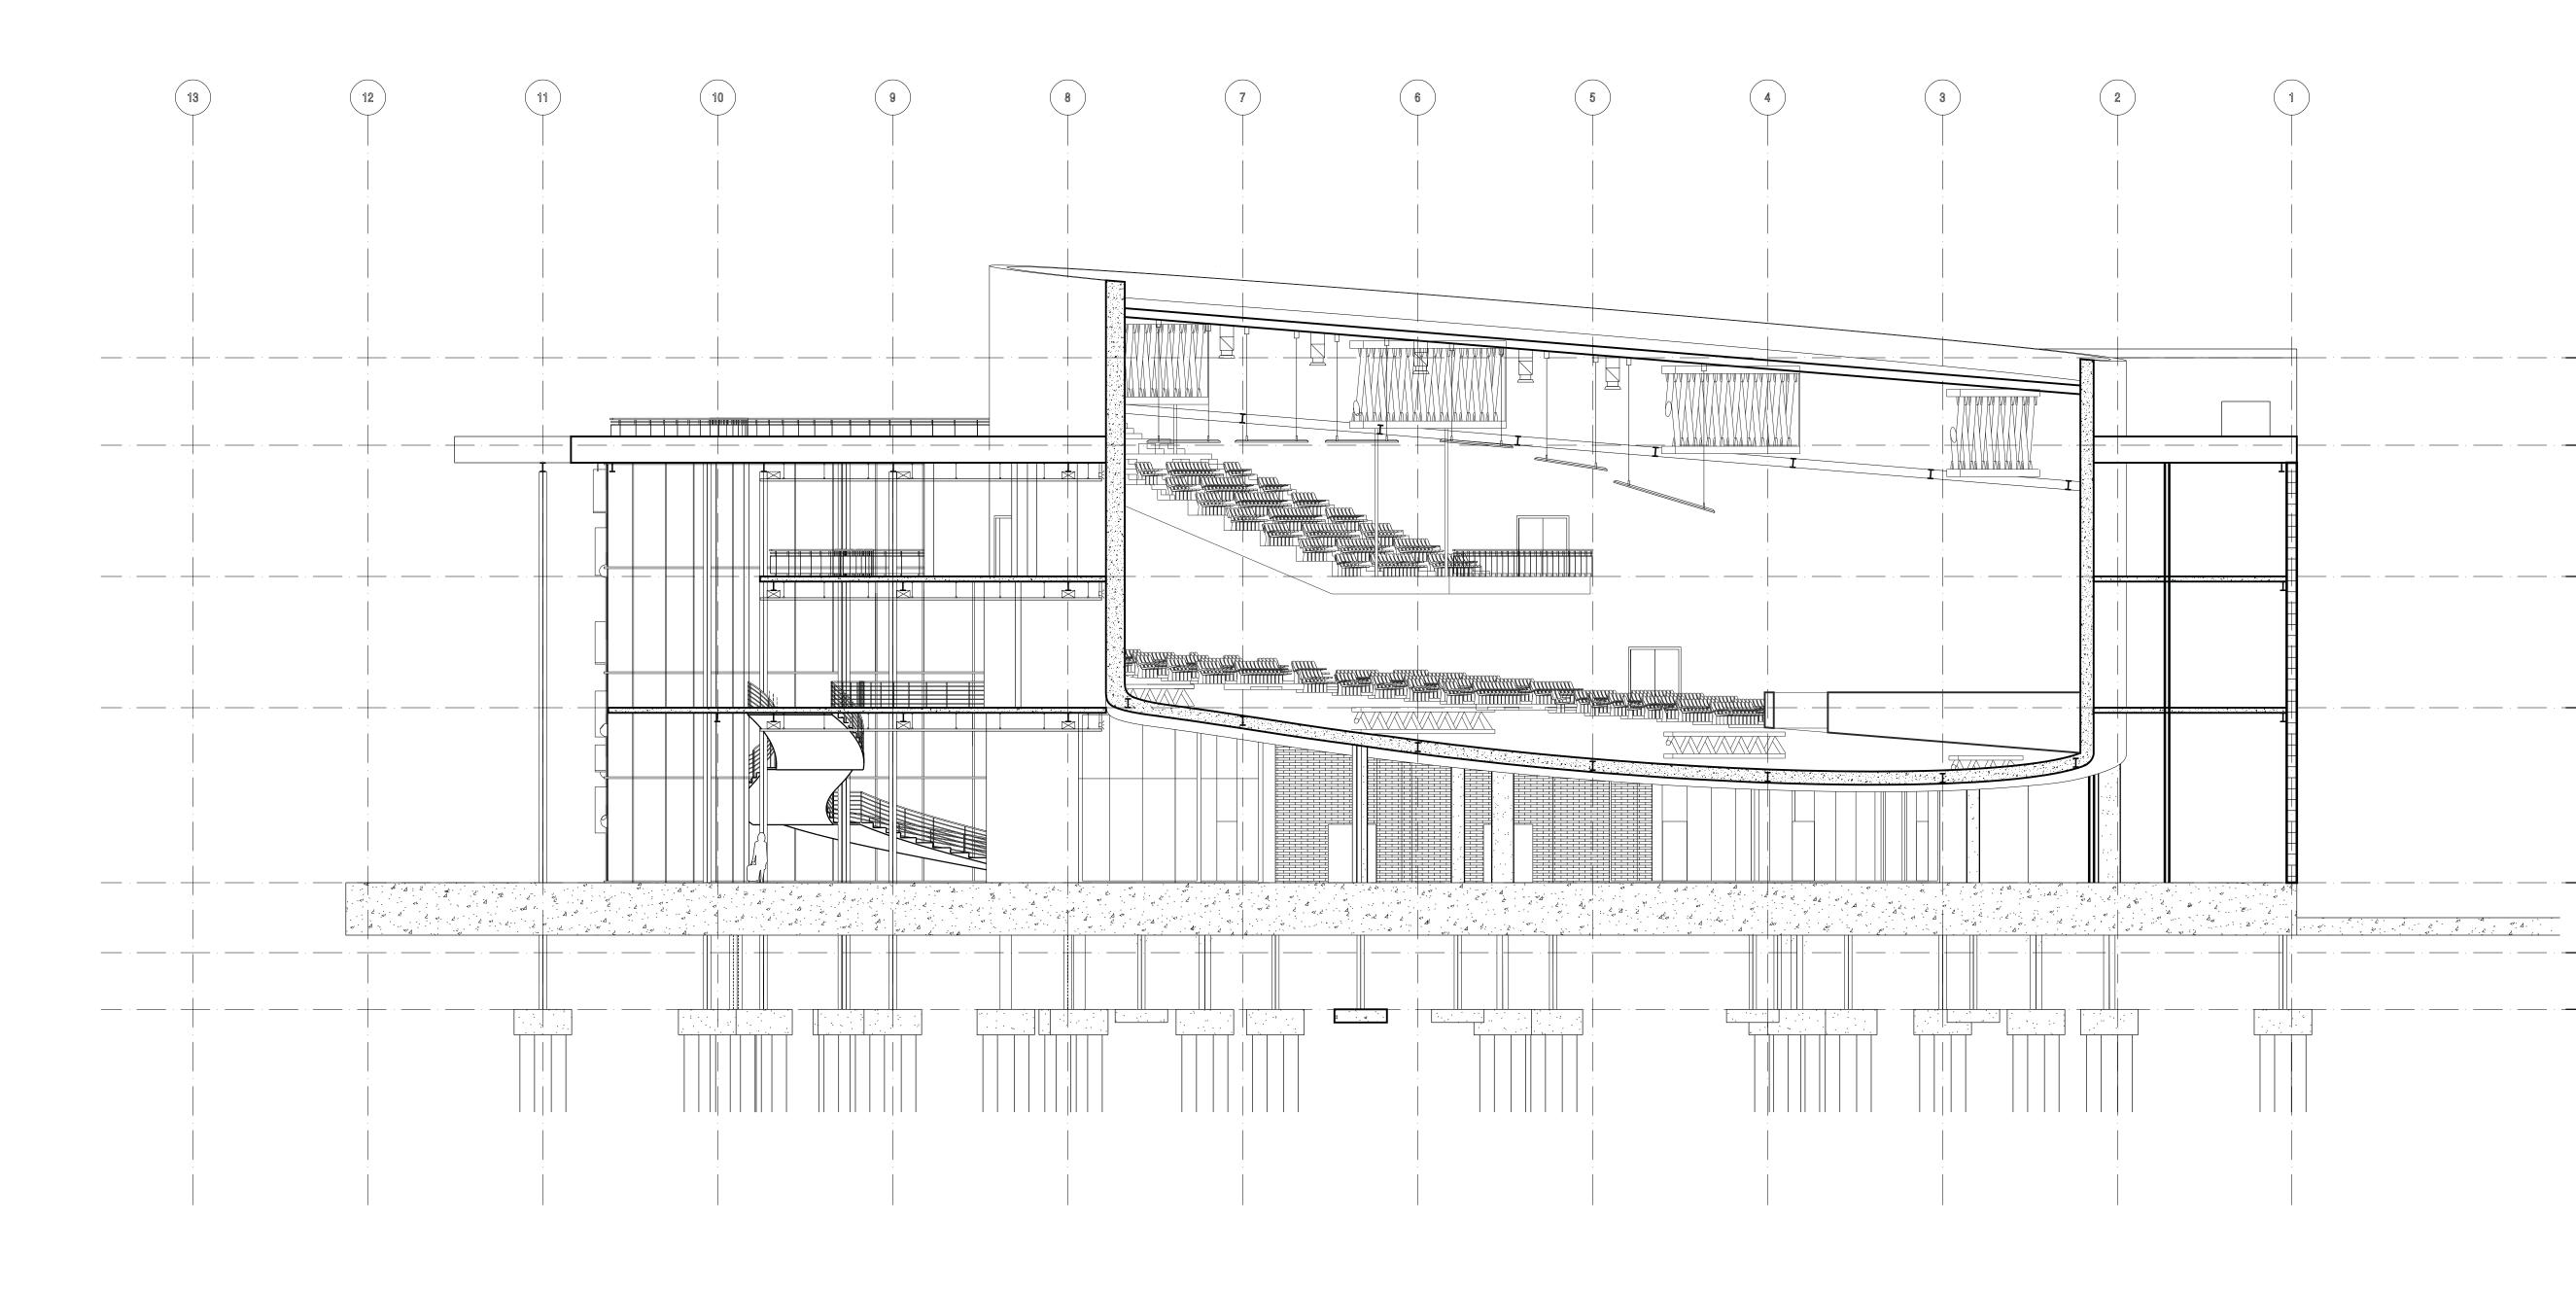

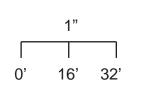

LONGITUDINAL BUILDING SECTION Cut Through Bar, Theater & Back of House



THE CEILING-TO-FLOOR DESIGN GROUP

DAVID MUSA - LUIS MIGUEL PIZANO - TIANYU YANG - REEM YASSIN

ADDRESS

Columbia University Graduate School of Architecture, Planning and Preservation 1172 Amsterdam Ave New York, NY 10027

PROJECT TEAM

ARCHITECTURE TECHNICAL CONSULTING

JOSEPH HAND Shop Architects 233 Broadway 11th Floor New York, NY 10279

STRUCTURAL AMY HARRINGTON PE Silman 32 Old Slip New York, NY 10005

MECHANICAL & SUSTAINABILITY JONCE WALKER LEED AP CSBA

Thornton Tomasetti, Inc. 51 Madison Ave New York, NY 10010

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Walter P Moore 180 Maiden Ln #803 New York, NY 10038

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> **PROJECT** Greenpoint Theater 18 Greenpoint Ave. Brooklyn, NY 11222

DRAWING TITLE Building Sections, E-W

DRAWING SCALE 1/16" : 1'-0"

ISSUE DATE

December 13, 2019

A302

Theater Roof 64' - 0"


> Roof 54' - 0"


Third Floor 39' - 0"

Second Floor 24' - 0"

First Floor 4' - 0"

Ground Level

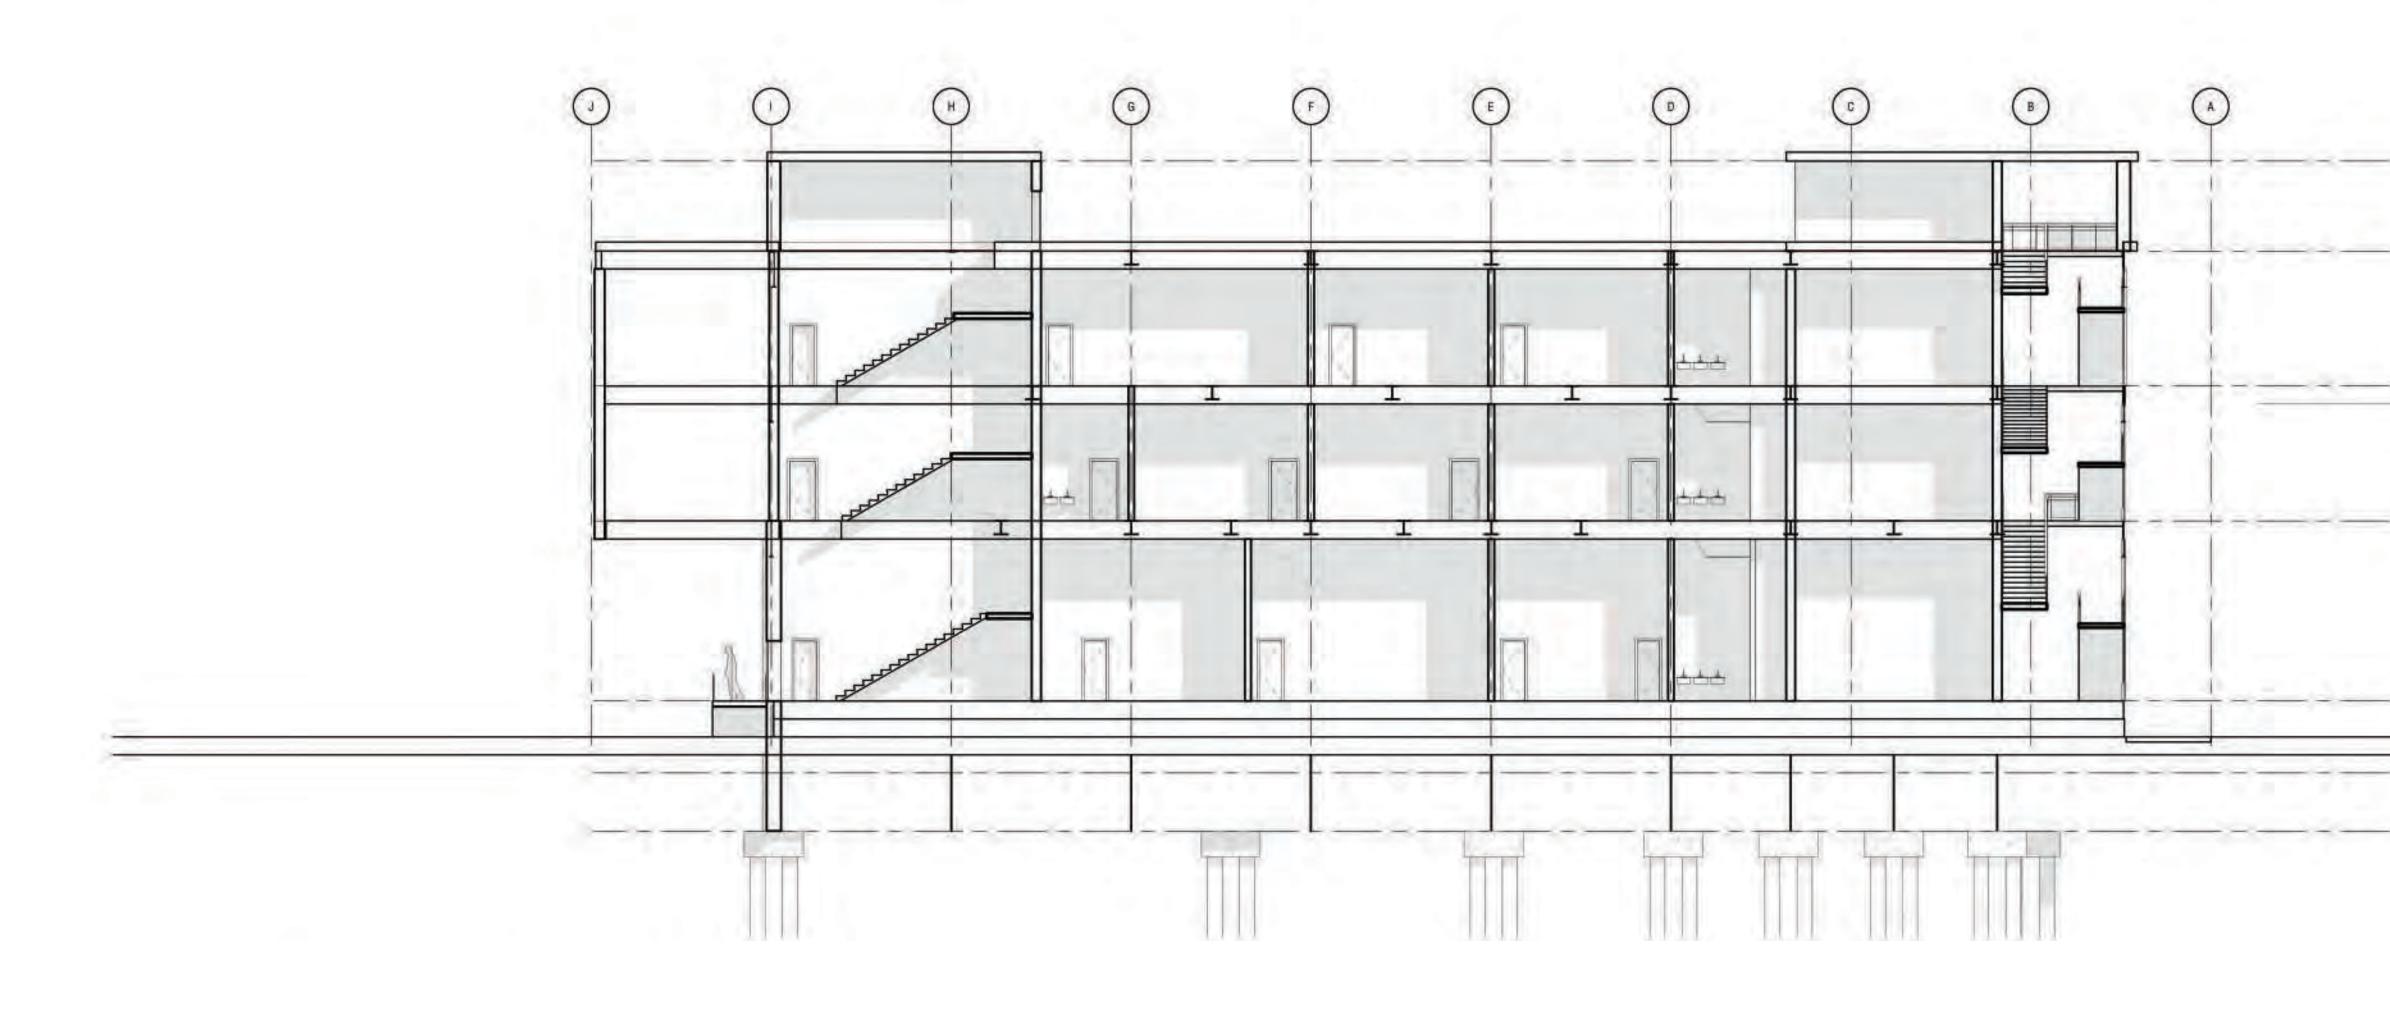

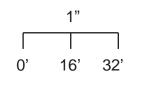

TRANSVERSE BUILDING SECTION Cut Through Back of House



THE CEILING-TO-FLOOR DESIGN GROUP

DAVID MUSA - LUIS MIGUEL PIZANO - TIANYU YANG - REEM YASSIN

ADDRESS

Columbia University Graduate School of Architecture, Planning and Preservation 1172 Amsterdam Ave New York, NY 10027

PROJECT TEAM

ARCHITECTURE TECHNICAL CONSULTING

JOSEPH HAND Shop Architects 233 Broadway 11th Floor New York, NY 10279

STRUCTURAL AMY HARRINGTON PE Silman 32 Old Slip New York, NY 10005

MECHANICAL & SUSTAINABILITY

JONCE WALKER LEED AP CSBA Thornton Tomasetti, Inc. 51 Madison Ave New York, NY 10010

KATHERINE CHAN Walter P Moore 180 Maiden Ln #803 New York, NY 10038

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> **PROJECT** Greenpoint Theater 18 Greenpoint Ave. Brooklyn, NY 11222


DRAWING TITLE Building Sections, E-W

DRAWING SCALE 1/16" : 1'-0"

ISSUE DATE

December 13, 2019

A303

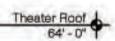


Roof +


Third Floor

Second Floor


First Floor 4'- 0" 0'- 0" Water Level -4'- 0"

Ground Level

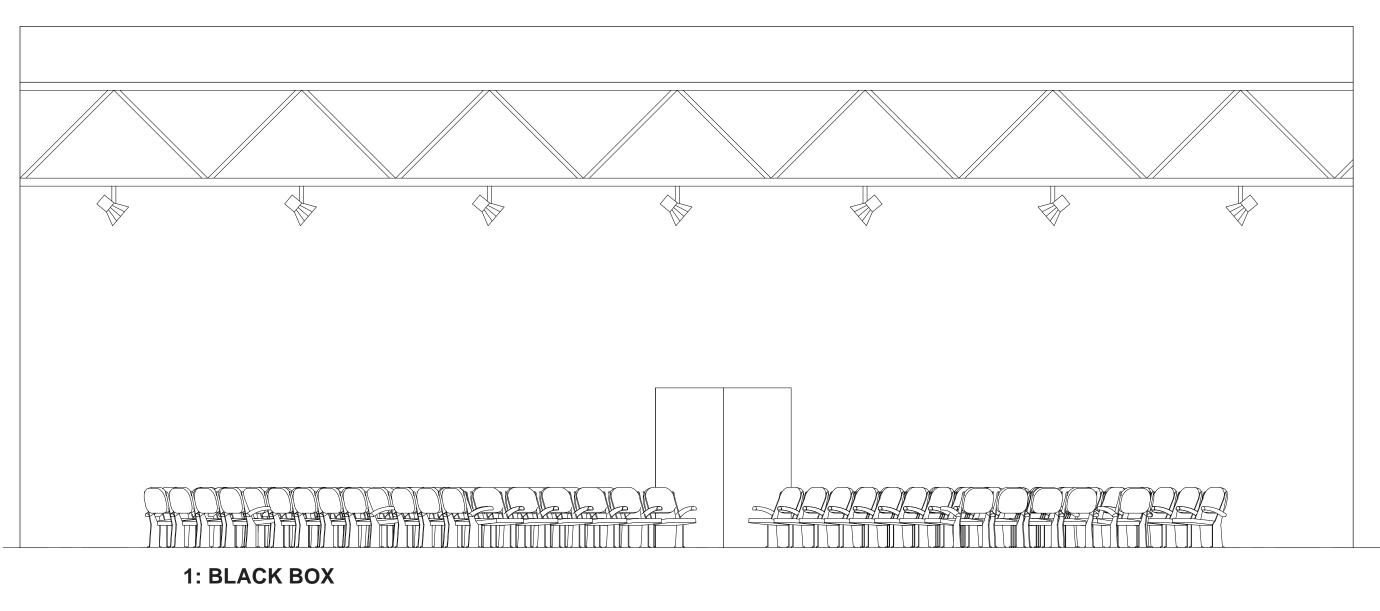

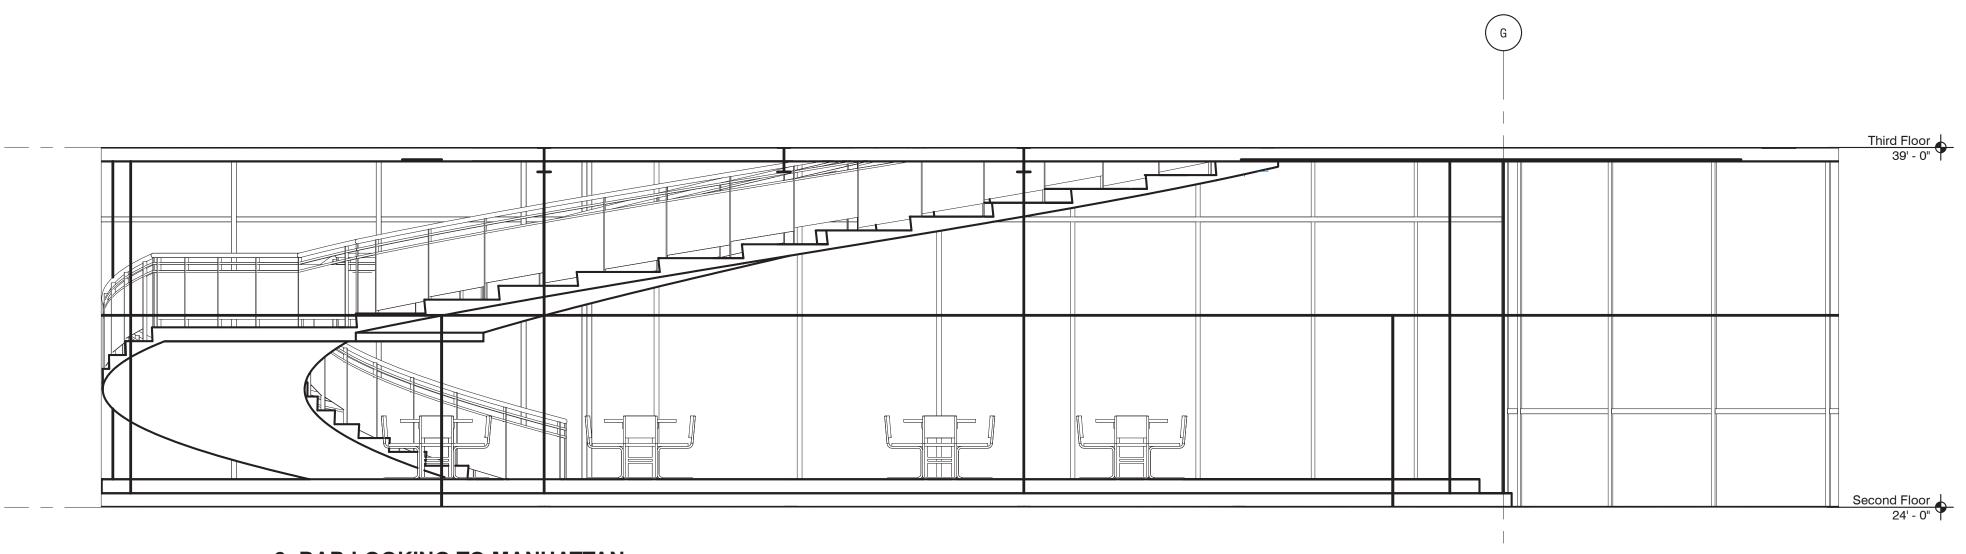

2: BAR LOOKING TO MANHATTAN

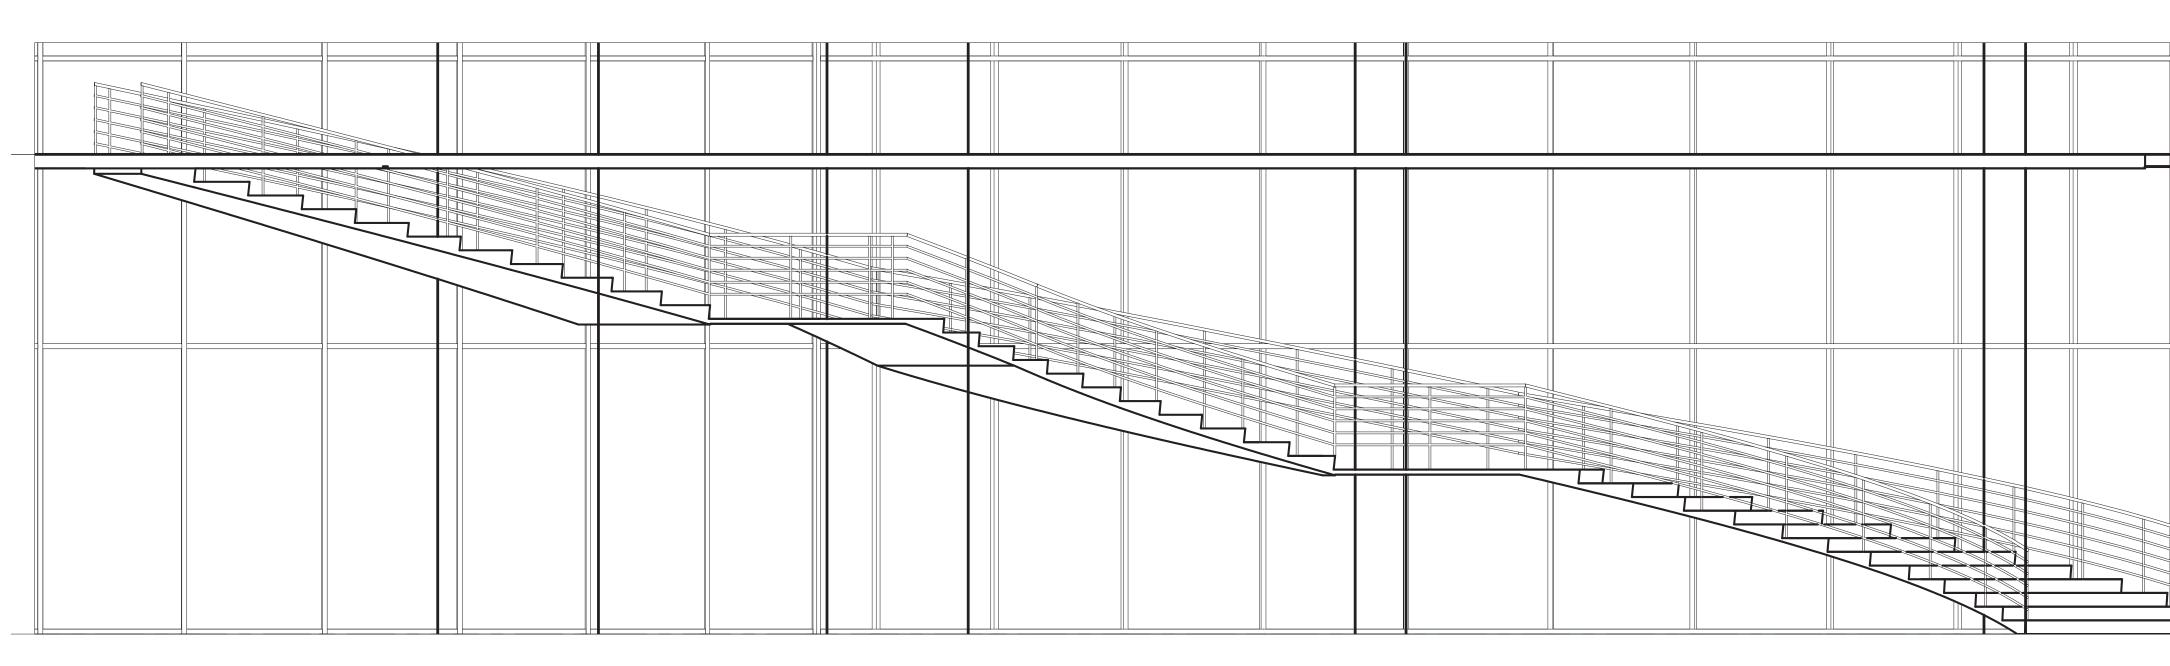

3: STAIR LOOKING TO MANHATTAN





THE CEILING-TO-FLOOR DESIGN GROUP

DAVID MUSA - LUIS MIGUEL PIZANO - TIANYU YANG - REEM YASSIN

ADDRESS

Columbia University Graduate School of Architecture, Planning and Preservation 1172 Amsterdam Ave New York, NY 10027

PROJECT TEAM

ARCHITECTURE TECHNICAL CONSULTING

JOSEPH HAND Shop Architects 233 Broadway 11th Floor New York, NY 10279

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New York, NY 10005

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> **PROJECT** Greenpoint Theater 18 Greenpoint Ave. Brooklyn, NY 11222

DRAWING TITLE

Interior Elevations

DRAWING SCALE 1/4": 1'-0"

A401

ISSUE DATE December 13, 2019

Second Vielotô 24' - 0"

> First Floor 4' - 0"



<u>First Floor</u> Room Number	Room Name	Ceiling Height	Net Floor Area	Floor Finish	Wall Finish	
1-0	Entrance Lobby	15'-0"	1,880 sq. ft.	Pol. Concrete	-	
1-1	Open Performance Space	15'-0"	2,500 sq. ft.	Pol. Concrete	-	
1-2	Reception	15'-0"	800 sq. ft.	Pol. Concrete	Curtain Wall & Gyp.	
1-3	Box Office	12'-0"	480 sq. ft.	Pol. Concrete	Curtain Wall & Gyp.	
1-4	Gallery	16'-0"	480 sq. ft.	Pol. Concrete	Curtain Wall & Gyp.	
1-5	Souvenir Shop	16'-0"	340 sq. ft.	Pol. Concrete	Curtain Wall & Gyp.	
1-6	Artist's Studio 1	16'-0"	550 sq. ft.	Pol. Concrete	Curtain Wall & Gyp.	
1-7	Artist's Studio 2	16'-0"	490 sq. ft.	Pol. Concrete	Curtain Wall & Gyp.	
1-8	Artist's Studio 3	16'-0"	480 sq. ft.	Pol. Concrete	Curtain Wall & Gyp.	
1-9	Artist's Studio 4	16'-0"	890 sq. ft.	Pol. Concrete	Curtain Wall & Gyp.	
1-10	Artist's Studio 5	16'-0"	340 sq. ft.	Pol. Concrete	Curtain Wall & Gyp.	
1-11	Boiler Room & BB AHU Room	12'-0"	495 sq. ft.	Pol. Concrete	Gyp. Bd. & CMU Wa	
1-12	Black Box	16'-0"	2,700 sq. ft.	Wood Bd.	Gyp. Bd. & CMU Wa	
1-13	Storage Room	12'-0"	125 sq. ft.	Pol. Concrete	CMU Wall	
1-14	Storage Room	12'-0"	80 sq. ft.	Pol. Concrete	CMU Wall	
1-15	Work Space	16'-0" 16'-0"	215 sq. ft.	Wood Bd. Wood Bd.	Gyp. Bd. & CMU Wa	
1-16 1-17	Staff Lounge & Kitchen 1FL FOH WC 1	10-0"	380 sq. ft. 135 sq. ft.	Pol. Concrete	Gyp. Bd. & CMU Wa CMU Wall	
1-17	Gas / Heat Room	12'-0"	90 sq. ft.	Pol. Concrete	CMU Wall	
1-18	Water Meter Room	12'-0"	110 sq. ft.	Pol. Concrete	CMU Wall	
1-20	Fire Pump Room	12'-0"	100 sq. ft.	Pol. Concrete	CMU Wall	
1-21	IT / Electrical Room	12'-0"	120 sq. ft.	Pol. Concrete	CMU Wall	
1-22	BOH & Studios AHU Room	12'-0"	300 sq. ft.	Pol. Concrete	CMU Wall	
1-23	WFL FOH WC 2	12'-0"	400 sq. ft.	Pol. Concrete	CMU Wall	
1-24	Lobby AHU Room	12'-0"	330 sq. ft.	Pol. Concrete	CMU Wall	
1-25	Admin Office 1	12'-0"	265 sq. ft.	Wood Bd.	Gyp. Bd. & CMU Wa	
1-26	Admin Office 2	12'-0"	265 sq. ft.	Wood Bd.	Gyp. Bd. & CMU Wa	
1-27	Storage Room	12'-0"	135 sq. ft.	Pol. Concrete	CMU Wall	
	0		·			
Second Floor						
Room Number	Room Name	Ceiling Height	Net Floor Area	Floor Finish	Wall Finish	
1-1	Theater			Wood Bd. & Carpet	Refurbished Fabric	
1-2	Control Room	45'-0"	8,700 sq. ft.	Wood Bd. & Carpet	Refurbished Fabric	
1-3	Orchestra Pit			Wood Bd. & Carpet	Refurbished Fabric	
1-4	Stage			Wood Bd. & Carpet	Refurbished Fabric	
1-5	Vestibule 1	12'-0"	280 sq. ft.	Wood Bd. & Carpet	Refurbished Fabric	
1-6	Coat Check	12'-0"	100 sq. ft.	Pol. Concrete	CMU Wall	
1-7	Vestibule 2	12'-0" 12'-0"	260 sq. ft.	Wood Bd. & Carpet	Refurbished Fabric	
1-8 1-9	Storage Room	12'-0" 12'-0"	135 sq. ft.	Pol. Concrete Wood Bd.	CMU Wall	
	Kitchen	12'-0"	190 sq. ft. 2,600 sq. ft.	Pol. Concrete	Gyp. Bd. & CMU Wa Glazing & CMU Wal	
1 1()	Parloungo		•	Pol. Concrete	CMU Wall	
1-10 1_11	Bar Lounge	12'_0"				
1-11	2FL FOH WC 1	12'-0" 12'-0"	250 sq. ft. 125 sq. ft			
1-11 1-12	2FL FOH WC 1 IT / Electrical Room	12'-0"	125 sq. ft.	Pol. Concrete	CMU Wall	
1-11 1-12 1-13	2FL FOH WC 1 IT / Electrical Room Bar Lounge AHU Room	12'-0" 12'-0"	125 sq. ft. 365 sq. ft.	Pol. Concrete Pol. Concrete	CMU Wall CMU Wall	
1-11 1-12 1-13 1-14	2FL FOH WC 1 IT / Electrical Room Bar Lounge AHU Room Generator	12'-0" 12'-0" 12'-0"	125 sq. ft. 365 sq. ft. 715 sq. ft.	Pol. Concrete Pol. Concrete Pol. Concrete	CMU Wall CMU Wall CMU Wall	
1-11 1-12 1-13 1-14 1-15	2FL FOH WC 1 IT / Electrical Room Bar Lounge AHU Room Generator 2FL FOH WC 2	12'-0" 12'-0" 12'-0" 12'-0"	125 sq. ft. 365 sq. ft. 715 sq. ft. 400 sq. ft.	Pol. Concrete Pol. Concrete Pol. Concrete Pol. Concrete	CMU Wall CMU Wall CMU Wall CMU Wall	
1-11 1-12 1-13 1-14 1-15 1-16	2FL FOH WC 1 IT / Electrical Room Bar Lounge AHU Room Generator 2FL FOH WC 2 BOH AHU Room	12'-0" 12'-0" 12'-0" 12'-0" 12'-0"	125 sq. ft. 365 sq. ft. 715 sq. ft. 400 sq. ft. 325 sq. ft.	Pol. Concrete Pol. Concrete Pol. Concrete Pol. Concrete Pol. Concrete	CMU Wall CMU Wall CMU Wall CMU Wall CMU Wall	
1-11 1-12 1-13 1-14 1-15 1-16 1-17	2FL FOH WC 1 IT / Electrical Room Bar Lounge AHU Room Generator 2FL FOH WC 2 BOH AHU Room Dressing Room 1	12'-0" 12'-0" 12'-0" 12'-0" 12'-0" 12'-0"	125 sq. ft. 365 sq. ft. 715 sq. ft. 400 sq. ft. 325 sq. ft. 260 sq. ft.	Pol. Concrete Pol. Concrete Pol. Concrete Pol. Concrete Pol. Concrete Pol. Concrete	CMU Wall CMU Wall CMU Wall CMU Wall CMU Wall CMU Wall	
1-11 1-12 1-13 1-14 1-15 1-16 1-17 1-18	2FL FOH WC 1 IT / Electrical Room Bar Lounge AHU Room Generator 2FL FOH WC 2 BOH AHU Room Dressing Room 1 Dressing Room 2	12'-0" 12'-0" 12'-0" 12'-0" 12'-0" 12'-0" 12'-0"	125 sq. ft. 365 sq. ft. 715 sq. ft. 400 sq. ft. 325 sq. ft. 260 sq. ft. 260 sq. ft.	Pol. Concrete Pol. Concrete Pol. Concrete Pol. Concrete Pol. Concrete Pol. Concrete Pol. Concrete	CMU Wall CMU Wall CMU Wall CMU Wall CMU Wall CMU Wall CMU Wall	
1-11 1-12 1-13 1-14 1-15 1-16 1-17	2FL FOH WC 1 IT / Electrical Room Bar Lounge AHU Room Generator 2FL FOH WC 2 BOH AHU Room Dressing Room 1	12'-0" 12'-0" 12'-0" 12'-0" 12'-0" 12'-0"	125 sq. ft. 365 sq. ft. 715 sq. ft. 400 sq. ft. 325 sq. ft. 260 sq. ft.	Pol. Concrete Pol. Concrete Pol. Concrete Pol. Concrete Pol. Concrete Pol. Concrete	CMU Wall CMU Wall CMU Wall CMU Wall CMU Wall CMU Wall	
1-11 1-12 1-13 1-14 1-15 1-16 1-17 1-18	2FL FOH WC 1 IT / Electrical Room Bar Lounge AHU Room Generator 2FL FOH WC 2 BOH AHU Room Dressing Room 1 Dressing Room 2	12'-0" 12'-0" 12'-0" 12'-0" 12'-0" 12'-0" 12'-0"	125 sq. ft. 365 sq. ft. 715 sq. ft. 400 sq. ft. 325 sq. ft. 260 sq. ft. 260 sq. ft.	Pol. Concrete Pol. Concrete Pol. Concrete Pol. Concrete Pol. Concrete Pol. Concrete Pol. Concrete Pol. Concrete	CMU Wall CMU Wall CMU Wall CMU Wall CMU Wall CMU Wall CMU Wall CMU Wall	
1-11 1-12 1-13 1-14 1-15 1-16 1-17 1-18 1-19 Third Floor Room Number	2FL FOH WC 1 IT / Electrical Room Bar Lounge AHU Room Generator 2FL FOH WC 2 BOH AHU Room Dressing Room 1 Dressing Room 2 Dressing Room 3	12'-0" 12'-0" 12'-0" 12'-0" 12'-0" 12'-0" 12'-0" Ceiling Height	125 sq. ft. 365 sq. ft. 715 sq. ft. 400 sq. ft. 325 sq. ft. 260 sq. ft. 260 sq. ft.	Pol. Concrete Pol. Concrete Pol. Concrete Pol. Concrete Pol. Concrete Pol. Concrete Pol. Concrete Pol. Concrete	CMU Wall CMU Wall CMU Wall CMU Wall CMU Wall CMU Wall CMU Wall CMU Wall	
1-11 1-12 1-13 1-14 1-15 1-16 1-17 1-18 1-19 Third Floor Room Number 1-1	2FL FOH WC 1 IT / Electrical Room Bar Lounge AHU Room Generator 2FL FOH WC 2 BOH AHU Room Dressing Room 1 Dressing Room 2 Dressing Room 3 Room Name Balcony	12'-0" 12'-0" 12'-0" 12'-0" 12'-0" 12'-0" 12'-0" Ceiling Height 45'-0"	125 sq. ft. 365 sq. ft. 715 sq. ft. 400 sq. ft. 325 sq. ft. 260 sq. ft. 260 sq. ft. 130 sq. ft. Net Floor Area 8,700 sq. ft.	Pol. Concrete Pol. Concrete Pol. Concrete Pol. Concrete Pol. Concrete Pol. Concrete Pol. Concrete Pol. Concrete Pol. Concrete	CMU Wall CMU Wall CMU Wall CMU Wall CMU Wall CMU Wall CMU Wall CMU Wall Wall Finish Refurbished Fabric I	
1-11 1-12 1-13 1-14 1-15 1-16 1-17 1-18 1-19 Third Floor Room Number 1-1 1-1	2FL FOH WC 1 IT / Electrical Room Bar Lounge AHU Room Generator 2FL FOH WC 2 BOH AHU Room Dressing Room 1 Dressing Room 2 Dressing Room 3 Room Name Balcony Vestibule 1	12'-0" 12'-0" 12'-0" 12'-0" 12'-0" 12'-0" 12'-0" 12'-0" 12'-0" 12'-0"	125 sq. ft. 365 sq. ft. 715 sq. ft. 400 sq. ft. 325 sq. ft. 260 sq. ft. 260 sq. ft. 130 sq. ft. Net Floor Area 8,700 sq. ft. 280 sq. ft.	Pol. Concrete Pol. Concrete Pol. Concrete Pol. Concrete Pol. Concrete Pol. Concrete Pol. Concrete Pol. Concrete Pol. Concrete State of the state of	CMU Wall CMU Wall CMU Wall CMU Wall CMU Wall CMU Wall CMU Wall CMU Wall Wall Finish Refurbished Fabric I Refurbished Fabric I	
1-11 1-12 1-13 1-14 1-15 1-16 1-17 1-18 1-19 Third Floor Room Number 1-1 1-2 1-3	2FL FOH WC 1 IT / Electrical Room Bar Lounge AHU Room Generator 2FL FOH WC 2 BOH AHU Room Dressing Room 1 Dressing Room 2 Dressing Room 3 Room Name Balcony Vestibule 1 Vestibule 2	12'-0" 12'-0" 12'-0" 12'-0" 12'-0" 12'-0" 12'-0" 12'-0" 12'-0" 12'-0" 12'-0"	125 sq. ft. 365 sq. ft. 715 sq. ft. 400 sq. ft. 325 sq. ft. 260 sq. ft. 260 sq. ft. 130 sq. ft. Net Floor Area 8,700 sq. ft. 280 sq. ft. 281 sq. ft.	Pol. Concrete Pol. Concrete Pol. Concrete Pol. Concrete Pol. Concrete Pol. Concrete Pol. Concrete Pol. Concrete Pol. Concrete Vol. Concrete Vood Bd. & Carpet Wood Bd. & Carpet Wood Bd. & Carpet	CMU Wall CMU Wall CMU Wall CMU Wall CMU Wall CMU Wall CMU Wall CMU Wall Wall Finish Refurbished Fabric I Refurbished Fabric I Refurbished Fabric I	
1-11 1-12 1-13 1-14 1-15 1-16 1-17 1-18 1-19 Third Floor Room Number 1-1 1-2 1-3 1-4	2FL FOH WC 1 IT / Electrical Room Bar Lounge AHU Room Generator 2FL FOH WC 2 BOH AHU Room Dressing Room 1 Dressing Room 2 Dressing Room 3 Room Name Balcony Vestibule 1	12'-0" 12'-0" 12'-0" 12'-0" 12'-0" 12'-0" 12'-0" 12'-0" 12'-0" 12'-0" 12'-0" 12'-0"	125 sq. ft. 365 sq. ft. 715 sq. ft. 400 sq. ft. 325 sq. ft. 260 sq. ft. 260 sq. ft. 130 sq. ft. 130 sq. ft. 280 sq. ft. 280 sq. ft. 281 sq. ft. 290 sq. ft.	Pol. Concrete Pol. Concrete Pol. Concrete Pol. Concrete Pol. Concrete Pol. Concrete Pol. Concrete Pol. Concrete Pol. Concrete Vood Bd. & Carpet Wood Bd. & Carpet Wood Bd. & Carpet Pol. Concrete	CMU Wall CMU Wall CMU Wall CMU Wall CMU Wall CMU Wall CMU Wall CMU Wall Wall Finish Refurbished Fabric I Refurbished Fabric I Refurbished Fabric I Refurbished Fabric I	
1-11 1-12 1-13 1-14 1-15 1-16 1-17 1-18 1-17 1-18 1-19 Third Floor Room Number 1-1 1-2 1-3 1-4 1-5	2FL FOH WC 1 IT / Electrical Room Bar Lounge AHU Room Generator 2FL FOH WC 2 BOH AHU Room Dressing Room 1 Dressing Room 2 Dressing Room 3 Room Name Balcony Vestibule 1 Vestibule 1 Vestibule 2 Control Room Storage Room	12'-0" 12'-0" 12'-0" 12'-0" 12'-0" 12'-0" 12'-0" 12'-0" 12'-0" 12'-0" 12'-0" 12'-0" 12'-0"	125 sq. ft. 365 sq. ft. 715 sq. ft. 400 sq. ft. 325 sq. ft. 260 sq. ft. 260 sq. ft. 130 sq. ft. 130 sq. ft. 280 sq. ft. 281 sq. ft. 290 sq. ft. 370 sq. ft.	Pol. Concrete Pol. Concrete Pol. Concrete Pol. Concrete Pol. Concrete Pol. Concrete Pol. Concrete Pol. Concrete Pol. Concrete Vood Bd. & Carpet Wood Bd. & Carpet Vood Bd. & Carpet Pol. Concrete Pol. Concrete	CMU Wall CMU Wall CMU Wall CMU Wall CMU Wall CMU Wall CMU Wall CMU Wall Wall Finish Refurbished Fabric I Refurbished Fabric I Refurbished Fabric I CMU Wall CMU Wall	
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DAVID MUSA - LUIS MIGUEL PIZANO - TIANYU YANG - REEM YASSIN

ADDRESS

Columbia University Graduate School of Architecture, Planning and Preservation 1172 Amsterdam Ave New York, NY 10027

PROJECT TEAM

ARCHITECTURE TECHNICAL CONSULTING

JOSEPH HAND Shop Architects 233 Broadway 11th Floor New York, NY 10279

STRUCTURAL AMY HARRINGTON PE Silman 32 Old Slip New York, NY 10005

MECHANICAL & SUSTAINABILITY

JONCE WALKER LEED AP CSBA Thornton Tomasetti, Inc. 51 Madison Ave New York, NY 10010

ENCLOSURE

KATHERINE CHAN Walter P Moore 180 Maiden Ln #803 New York, NY 10038

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PROJECT

Greenpoint Theater 18 Greenpoint Ave. Brooklyn, NY 11222

DRAWING TITLE Finishes Schedule

DRAWING SCALE Various

A402

BENØHEIM

Low-E Thermal Performance Coating for Channel Glass



Application:

Interior, Exterior

Composition:

Glass: 40% post-consumer + 20% pre-consumer recycled glass with a thermal performance hard coating

Installation:

Approx. ¹/₄"-thick lightweight glass in channel form is relatively easy to install, especially with the smart design of Bendheim's channel glass wall systems. No specialized training is required. Any competent commercial glazier with curtainwall or storefront installation experience can handle the channel glass installation. Cranes are not required, as individual glass channels are lightweight. The channels can be glazed on site or pre-assembled at the glazier's shop using Bendheim's unique unitized channel glass systems.

Approx Dimensions:

Length = up to 23 ft. (7 m); glass is fabricated to specified length. Width = 9" (230 mm), 10.3" (260 mm), 13" (330 mm), or 19.5" (480 mm). Flange depth = 1.6" (41 mm) for interior use, 2.4" (60 mm) for exterior use. Thickness = 0.24" (6 mm) for interior use, 0.28" (7 mm) for exterior use. Maximum size depends on wind loads, glass safety option, and other factors. Custom sizes may be available, please inquire.

Approx Weight:

Ranges approx. 4-5 lbs/ft² (20-25 kg/m²) for a single layer of channel glass (single-glazed configuration)

Working on a project that requires customizing this product? Custom design is our specialty. Please contact your local Bendheim representative to discuss your project and vision.

Page 1

Phone: 800.221.7379 info@bendheim.com

◀9-19" (230-480 mm)



Bendheim Corporate 82 Totowa Road, Wayne, NJ 07470

Safety Options:

Tempered

Maintenance:

Bendheim glass is easy to maintain. We suggest cleaning with warm water and a lint free cloth (terry cloth). Conventional nonabrasive glass cleaners may also be used.

Performance Characteristics:

STC Rating = STC 34 to STC 38 | Note: STC 34 is based on test of Bendheim I-41 conventional interlocking double-glazed channel glass wall system with push-in gaskets. Wet-sealed I-60 channel glass system is projected to reach STC 38. Compare to STC 33 for a typical interior wall (1/2" drywall on each side, wood studs, no insulation) and STC 39 for a typical insulated interior wall (1/2" drywall on each side, wood studs + fiberglass insulation)

Testing:

Bendheim tempered safety channel glass is 100% heat soak tested (test is recommended for all exterior tempered glass applications), and Safety Glazing Council certified. It meets the requirements for ANSI Z97.1 & the Consumer Product Safety Commission CPSC 16FR, Part 1201 – Safety Standard for Architectural Glazing Materials. Heat soak testing minimizes the risk of spontaneous tempered glass breakage as a result of nickel sulfide inclusions.

Options & Customizations:

Glass Textures:

- 504 Rough Cast[™]
- Clarissismo[™]

Thermal Insulation Interlayers:

- Okapane (acrylic tubes)
- Wacotech TIMax (fiber glass)



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Page 2

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THE **CEILING-TO-FLOOR DESIGN GROUP**

DAVID MUSA - LUIS MIGUEL PIZANO - TIANYU YANG - REEM YASSIN

ADDRESS

Columbia University Graduate School of Architecture, Planning and Preservation 1172 Amsterdam Ave New York, NY 10027

PROJECT TEAM

ARCHITECTURE TECHNICAL CONSULTING

JOSEPH HAND Shop Architects 233 Broadway 11th Floor New York, NY 10279

STRUCTURAL AMY HARRINGTON PE Silman 32 Old Slip New York, NY 10005

MECHANICAL & SUSTAINABILITY

JONCE WALKER LEED AP CSBA Thornton Tomasetti, Inc. 51 Madison Ave New York, NY 10010

ENCLOSURE **KATHERINE CHAN**

Walter P Moore 180 Maiden Ln #803 New York, NY 10038


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PROJECT Greenpoint Theater

18 Greenpoint Ave. Brooklyn, NY 11222





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ADDRESS

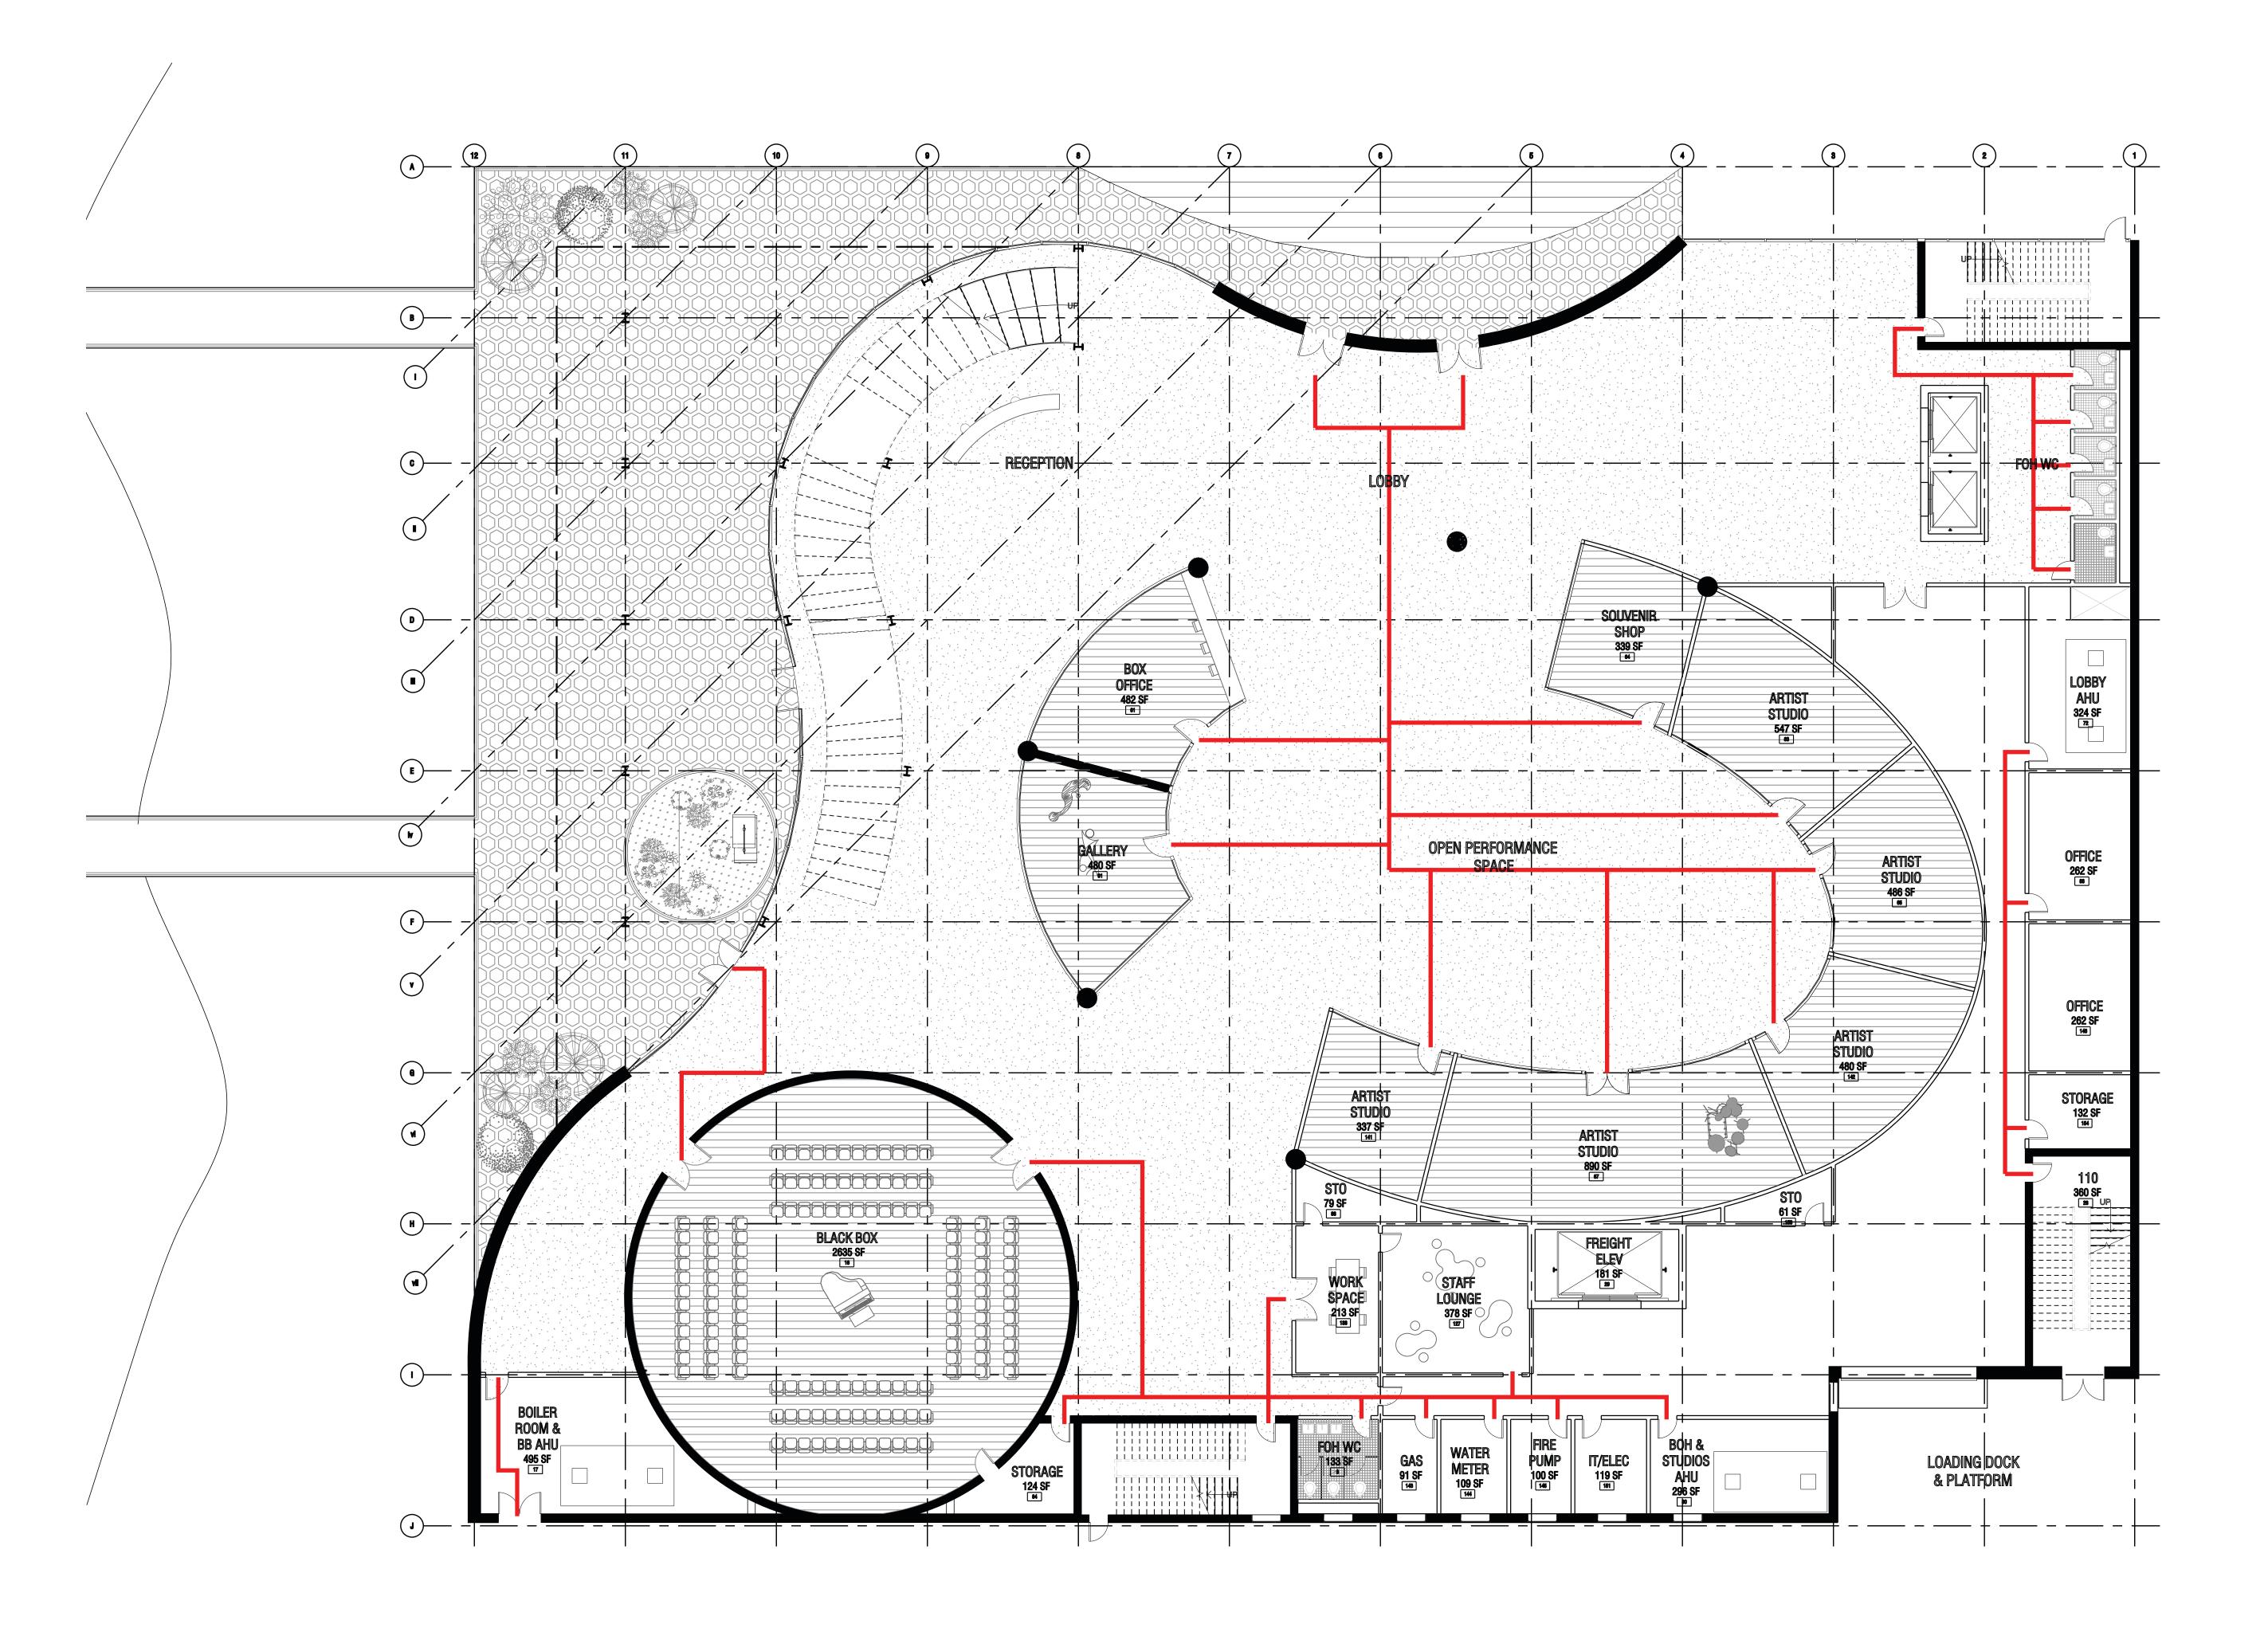Columbia University Graduate School of Architecture, Planning and Preservation 1172 Amsterdam Ave New York, NY 10027

PROJECT TEAM

ARCHITECTURE TECHNICAL CONSULTING

JOSEPH HAND Shop Architects 233 Broadway 11th Floor New York, NY 10279

STRUCTURAL AMY HARRINGTON PE Silman 32 Old Slip New York, NY 10005

MECHANICAL & SUSTAINABILITY

JONCE WALKER LEED AP CSBA Thornton Tomasetti, Inc. 51 Madison Ave New York, NY 10010

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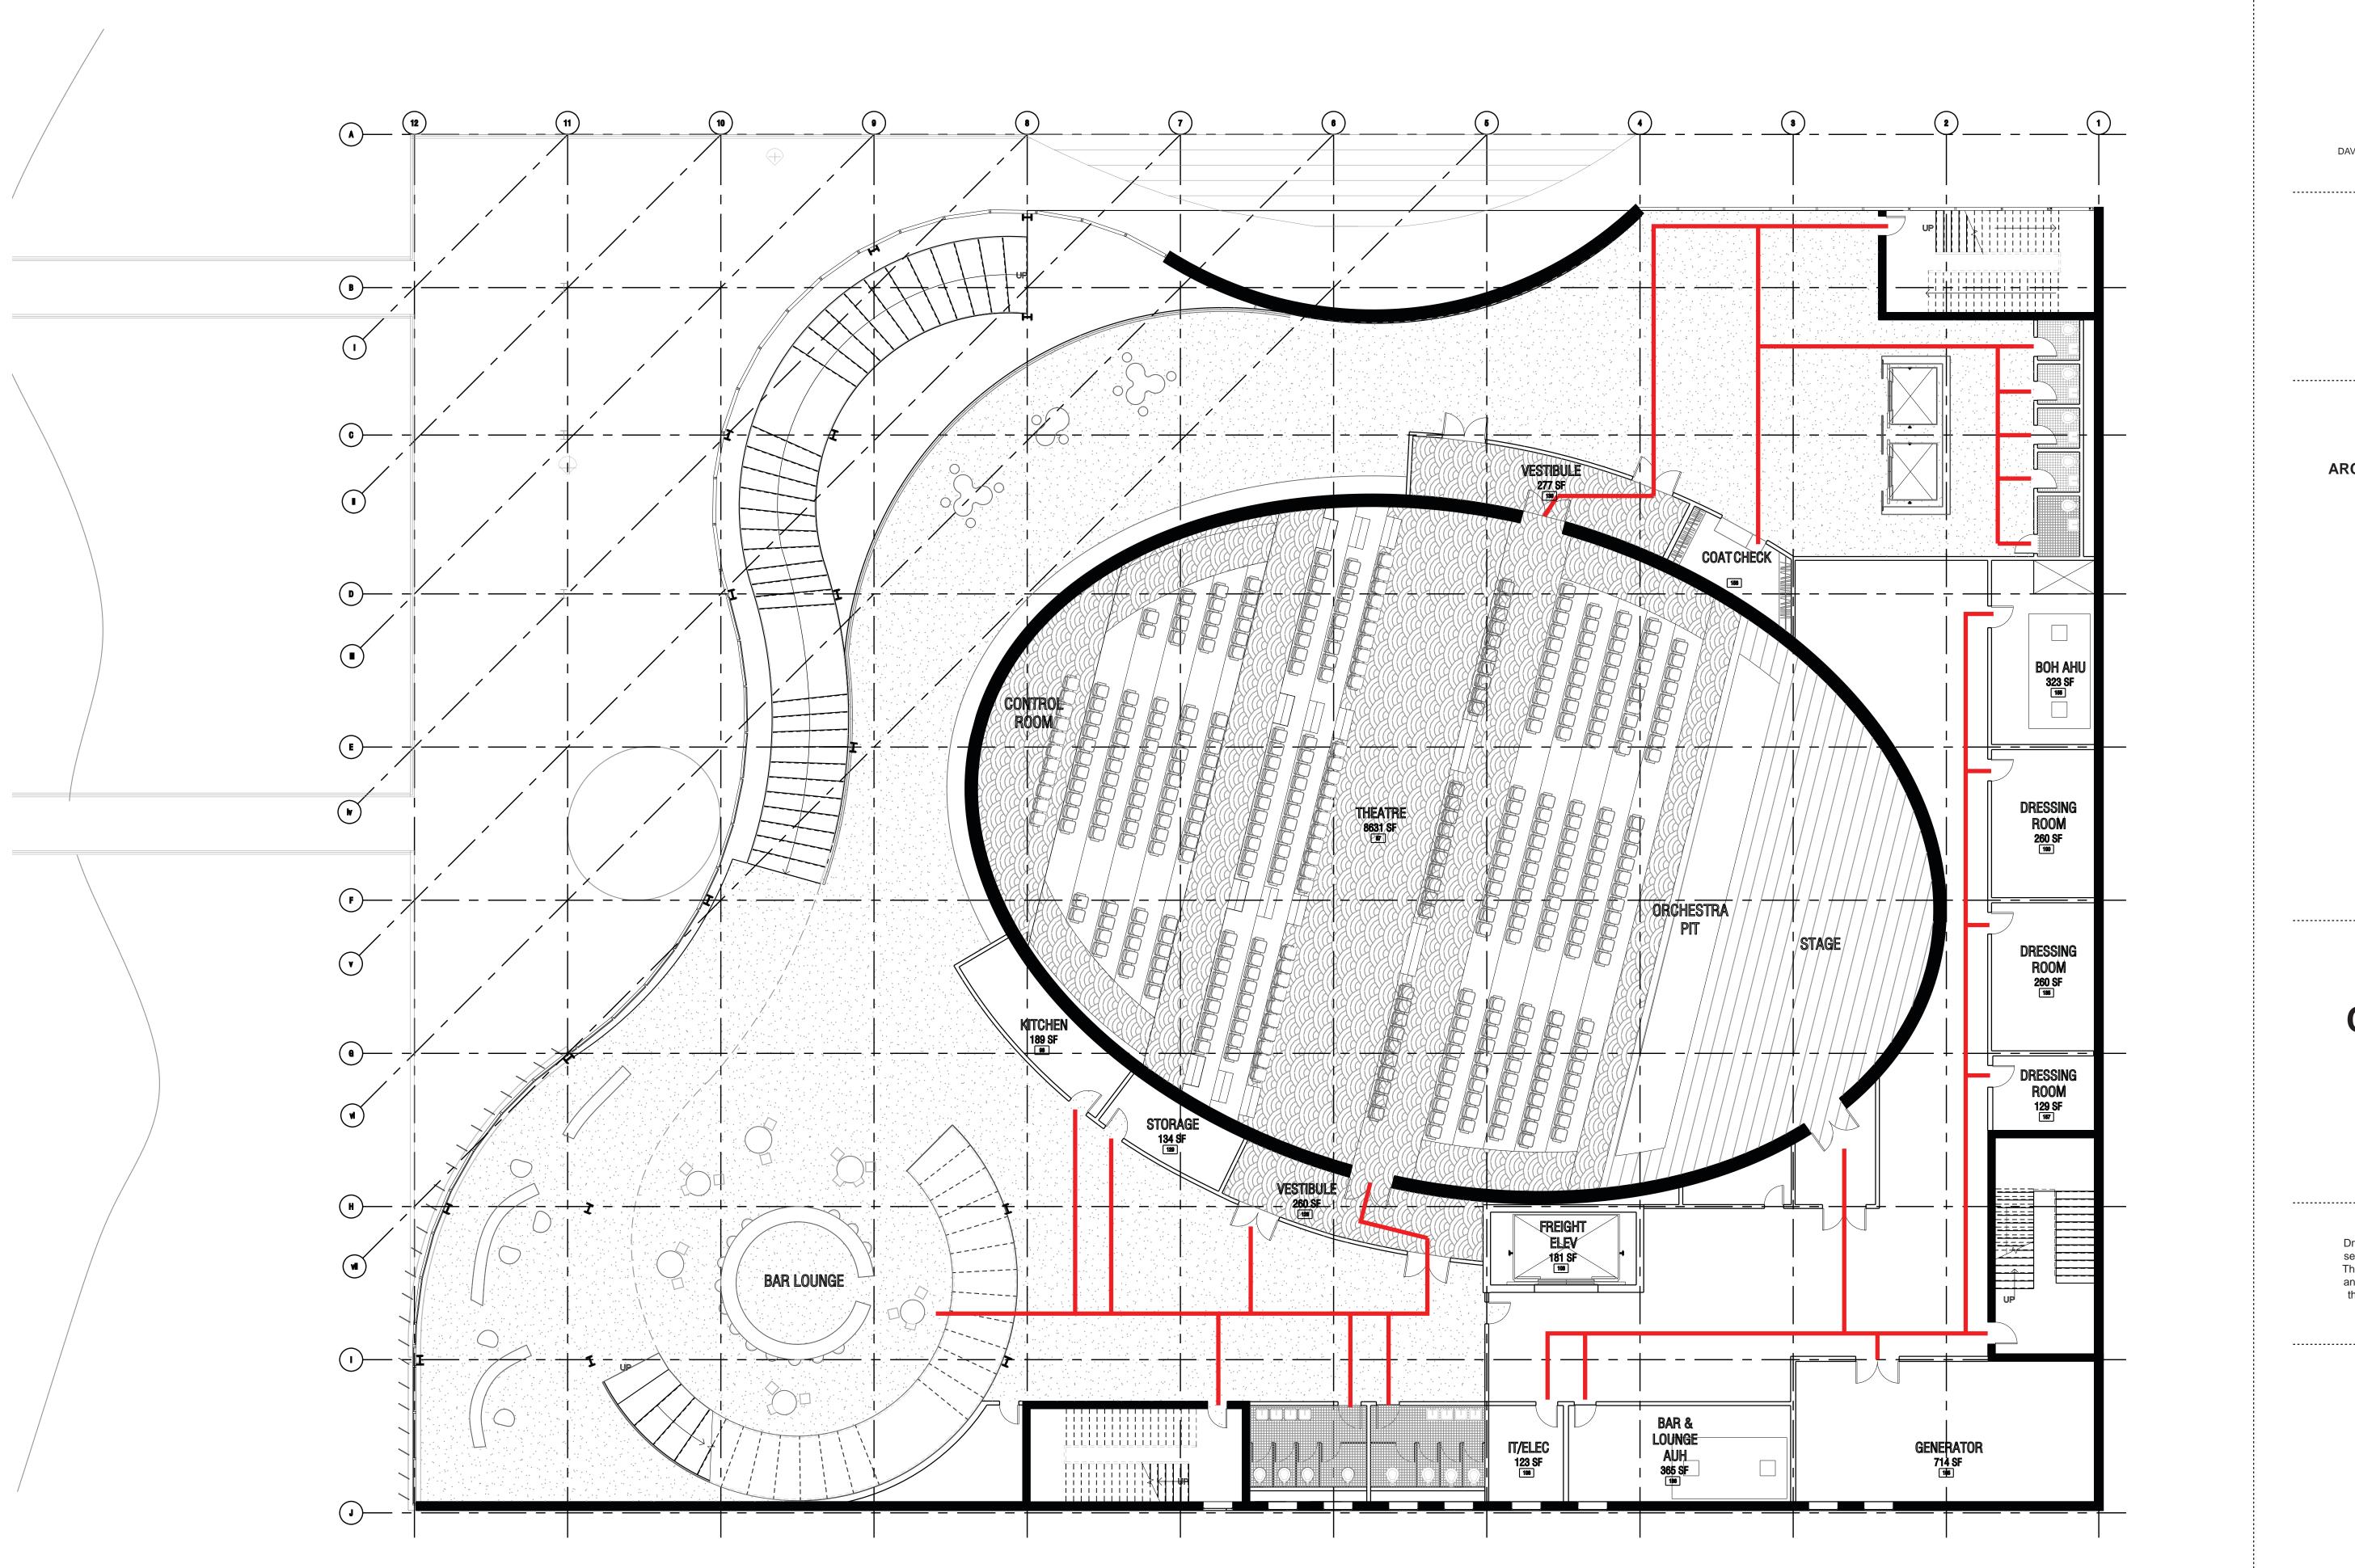
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> **PROJECT** Greenpoint Theater 18 Greenpoint Ave. Brooklyn, NY 11222

DRAWING TITLE First Floor Plan, Egress

DRAWING SCALE 1/8": 1'-0"

A501





DAVID MUSA - LUIS MIGUEL PIZANO - TIANYU YANG - REEM YASSIN

ADDRESS

Columbia University Graduate School of Architecture, Planning and Preservation 1172 Amsterdam Ave New York, NY 10027

PROJECT TEAM

ARCHITECTURE TECHNICAL CONSULTING

JOSEPH HAND Shop Architects 233 Broadway 11th Floor New York, NY 10279

STRUCTURAL AMY HARRINGTON PE Silman 32 Old Slip New York, NY 10005

MECHANICAL & SUSTAINABILITY JONCE WALKER LEED AP CSBA

Thornton Tomasetti, Inc. 51 Madison Ave New York, NY 10010

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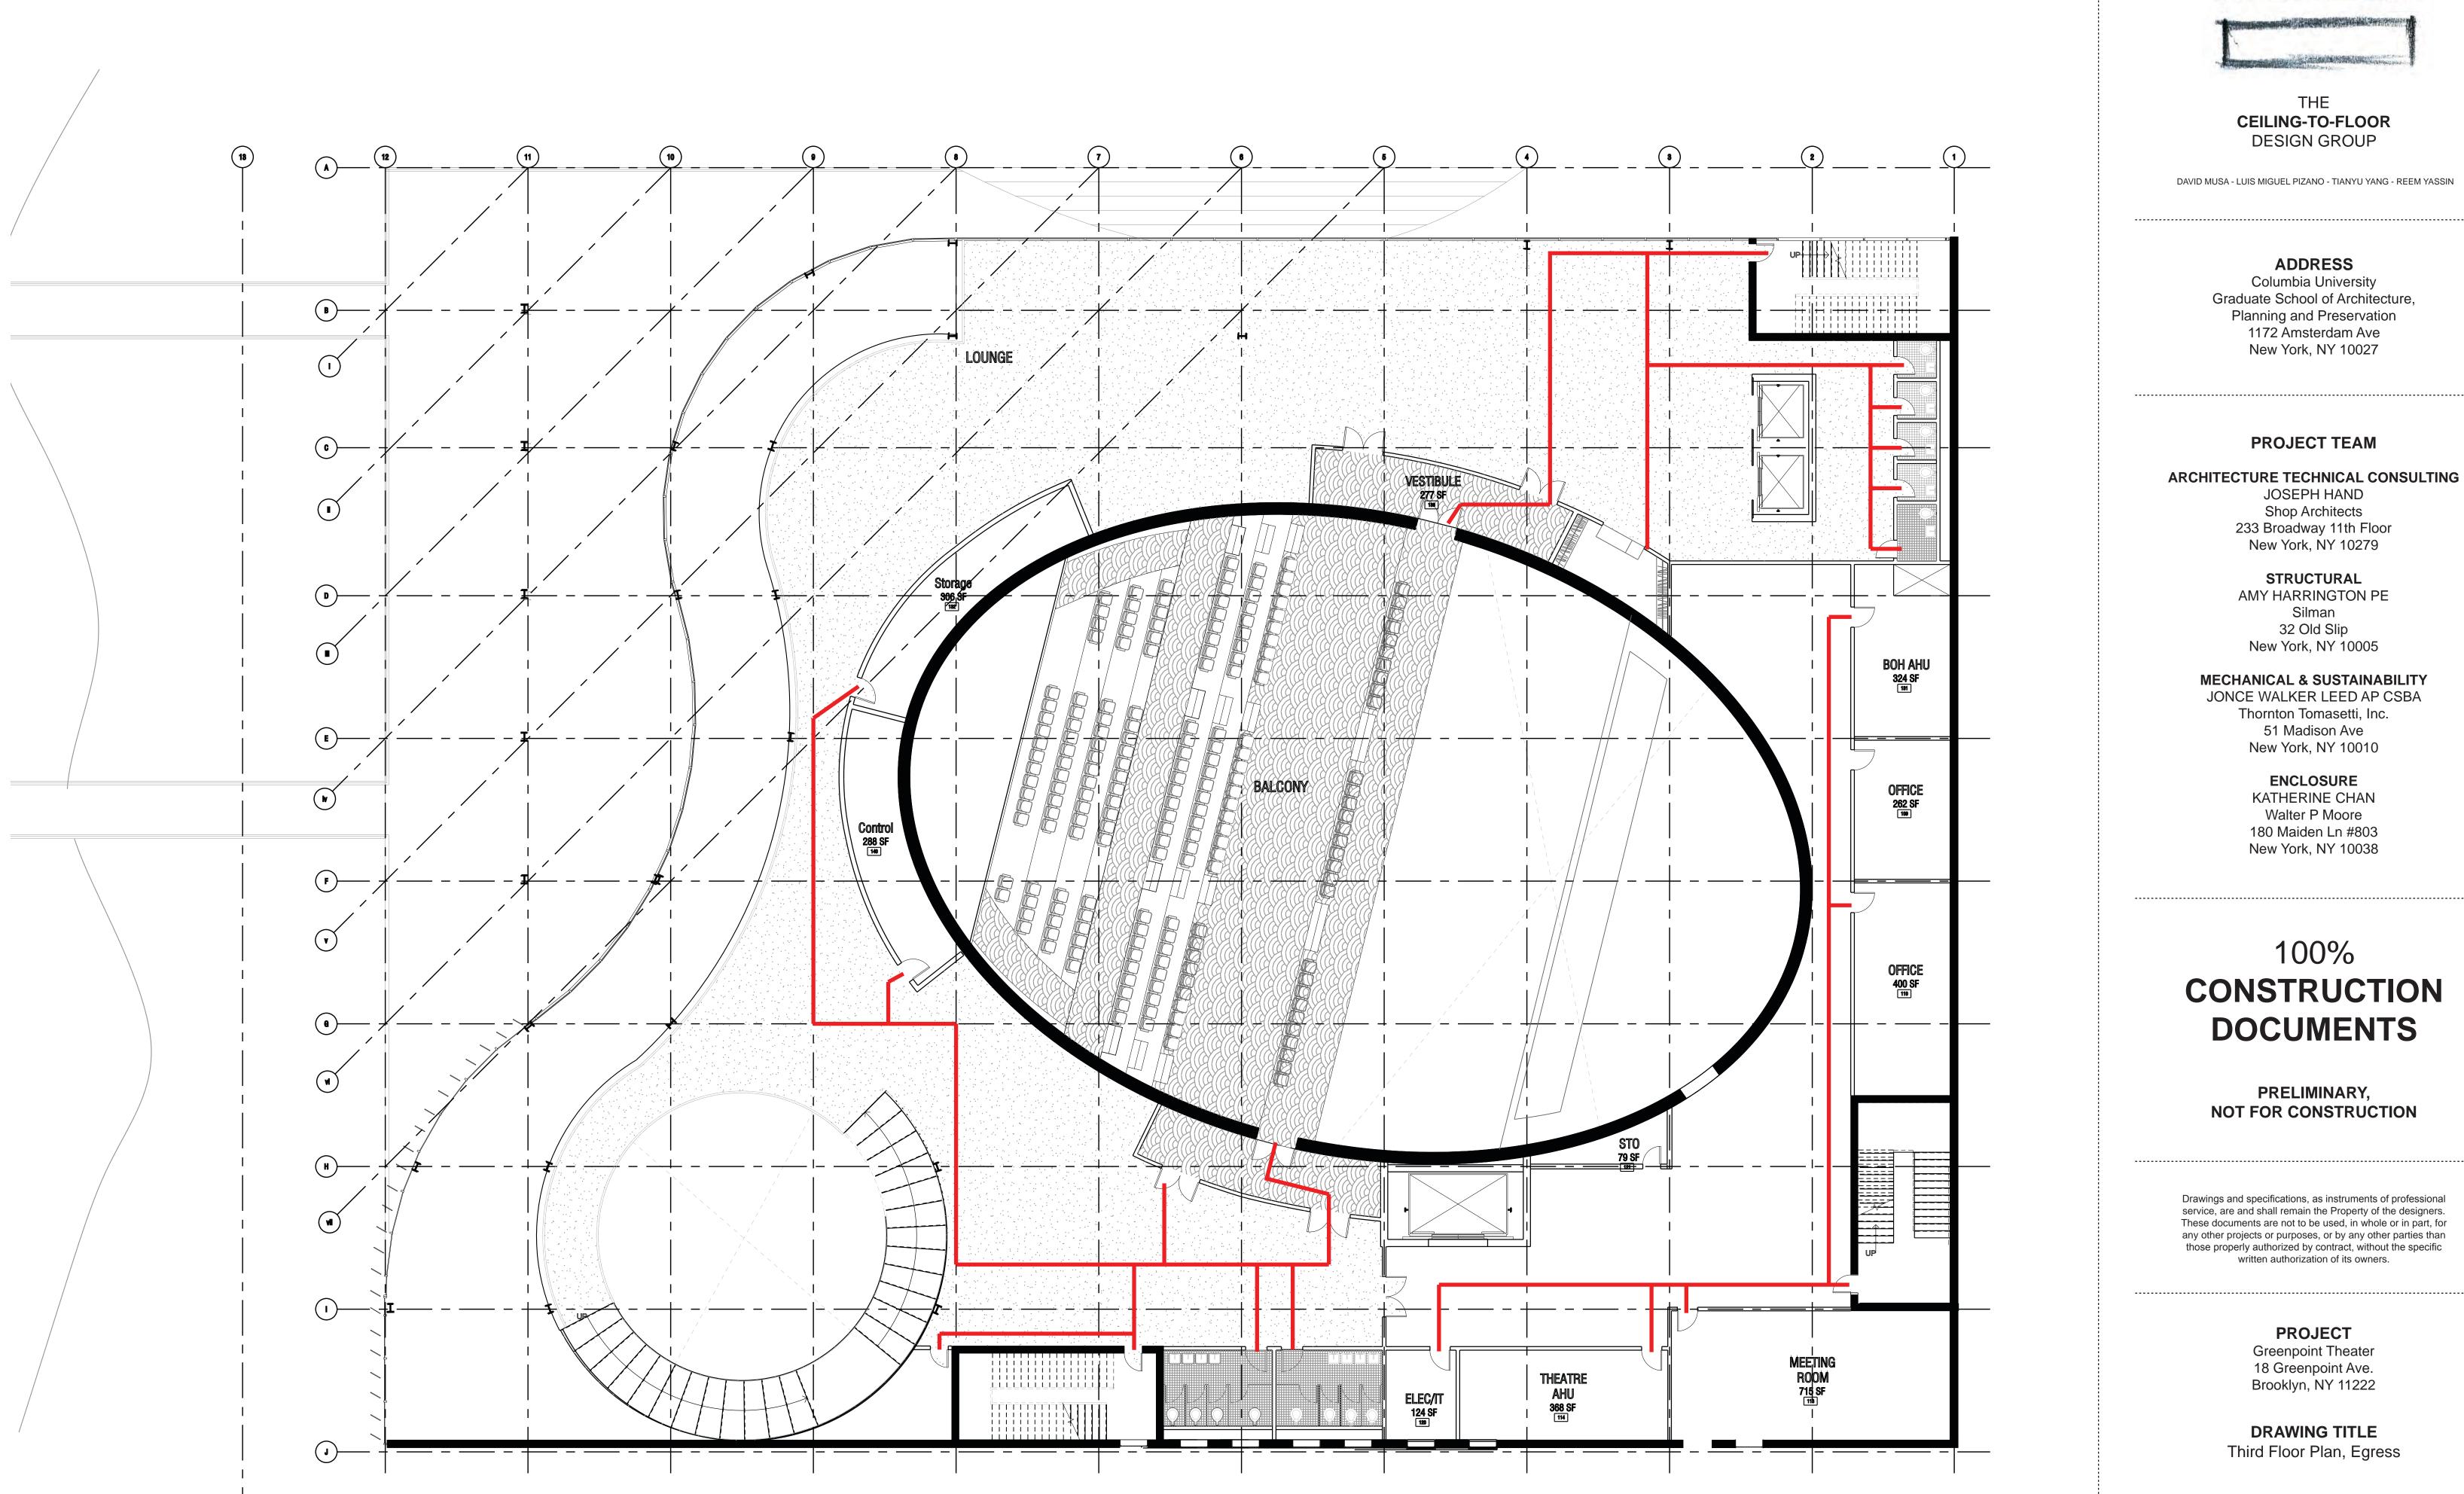
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> **PROJECT** Greenpoint Theater 18 Greenpoint Ave. Brooklyn, NY 11222

DRAWING TITLE Second Floor Plan, Egress

> **DRAWING SCALE** 1/8": 1'-0"


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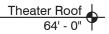


DRAWING SCALE 1/8": 1'-0"

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Roof 54' - 0"

Third Floor 39' - 0"

Second Floor 24' - 0"

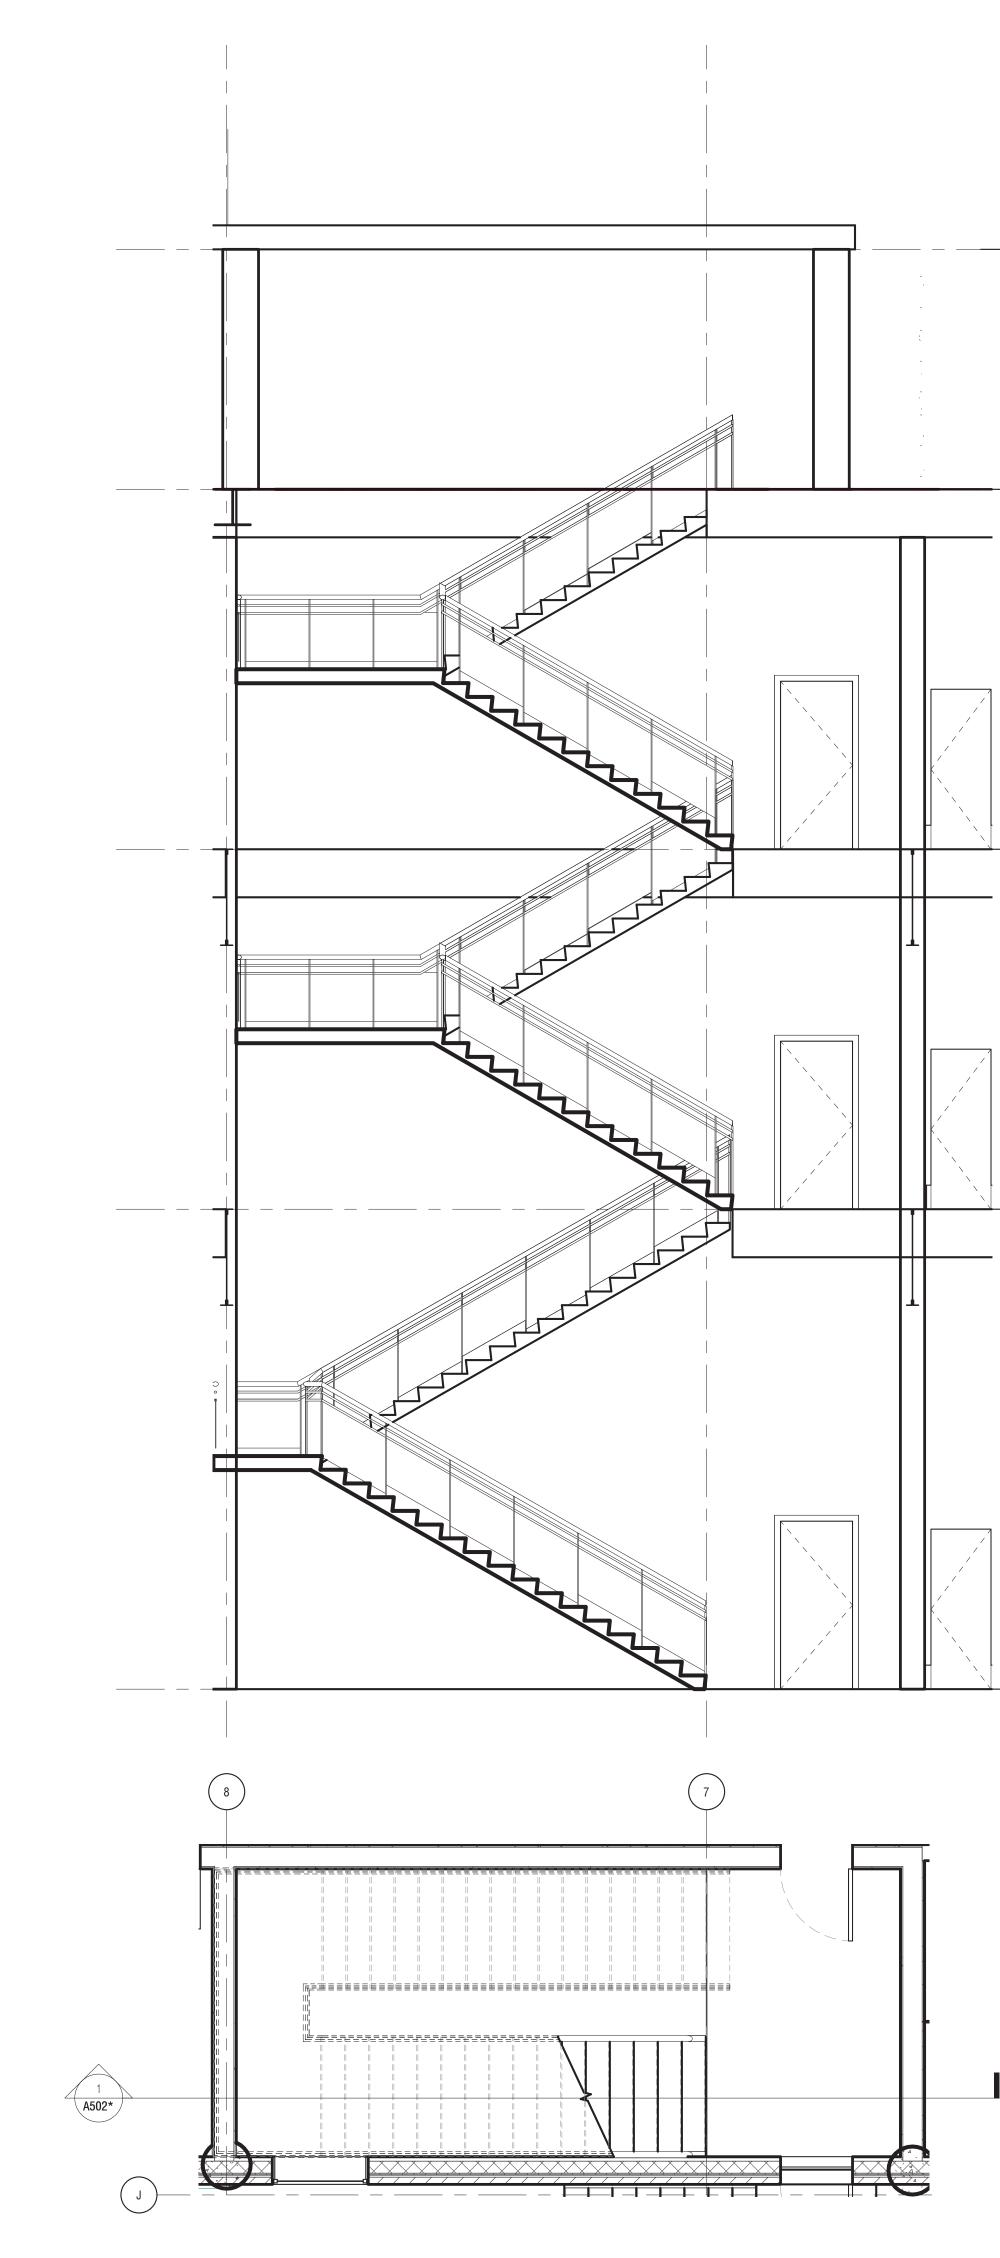24' - 0" 📍


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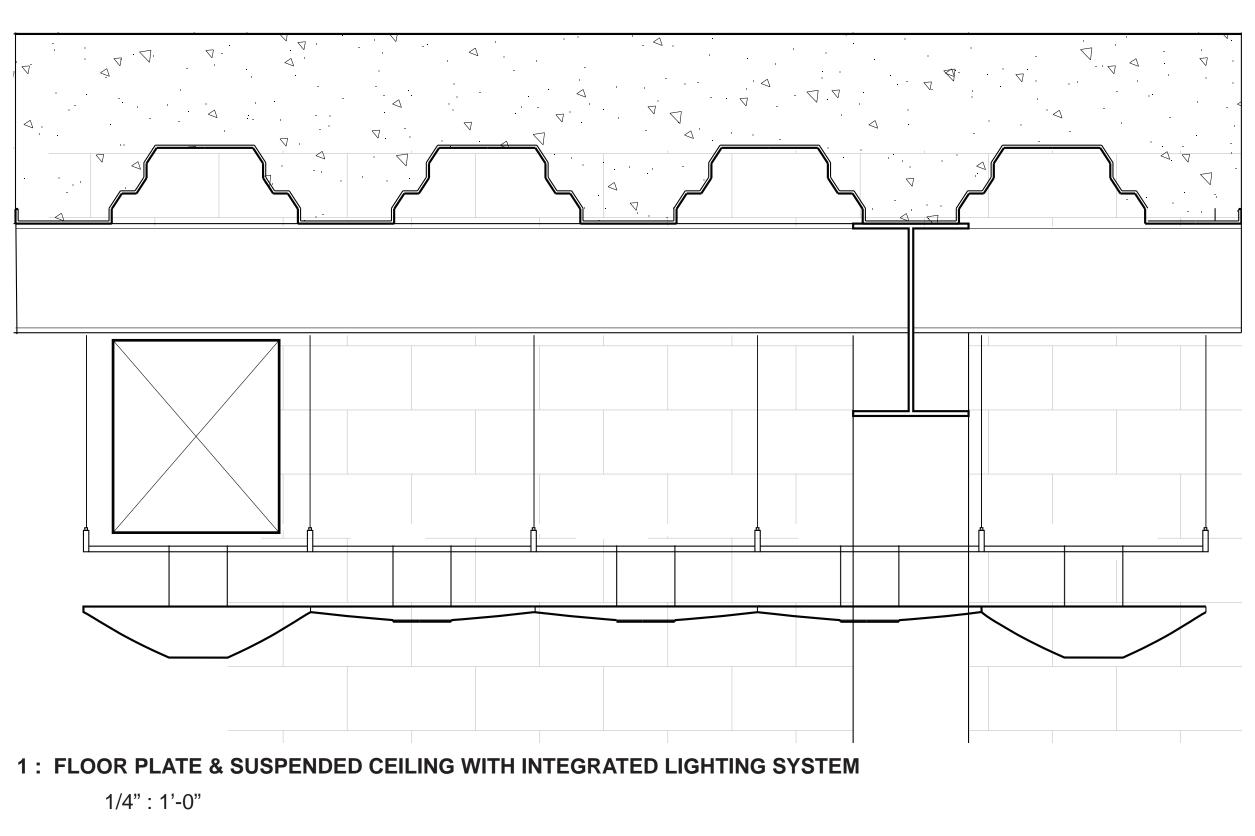



Theater Roof	THE
64' - 0" •	CEILING-TO-FLOOR DESIGN GROUP
	DAVID MUSA - LUIS MIGUEL PIZANO - TIANYU YANG - REEM YASSIN
	ADDRESS
<u>Roof</u> 54' - 0"	Columbia University Graduate School of Architecture, Planning and Preservation 1172 Amsterdam Ave New York, NY 10027
	PROJECT TEAM
	ARCHITECTURE TECHNICAL CONSULTING JOSEPH HAND Shop Architects 233 Broadway 11th Floor New York, NY 10279
Third Floor 39' - 0"	STRUCTURAL
	AMY HARRINGTON PE Silman 32 Old Slip
-	New York, NY 10005 MECHANICAL & SUSTAINABILITY
	JONCE WALKER LEED AP CSBA Thornton Tomasetti, Inc. 51 Madison Ave New York, NY 10010
	ENCLOSURE KATHERINE CHAN
Second Floor	Walter P Moore 180 Maiden Ln #803
24' - 0" Y	New York, NY 10038
	100%
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	DOCUMENTS
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	PROJECT Greenpoint Theater 18 Greenpoint Ave.
	Brooklyn, NY 11222
	DRAWING TITLE Egress Sections
	DRAWING SCALE 1/4" : 1'-0"

ISSUE DATE December 13, 2019


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A504



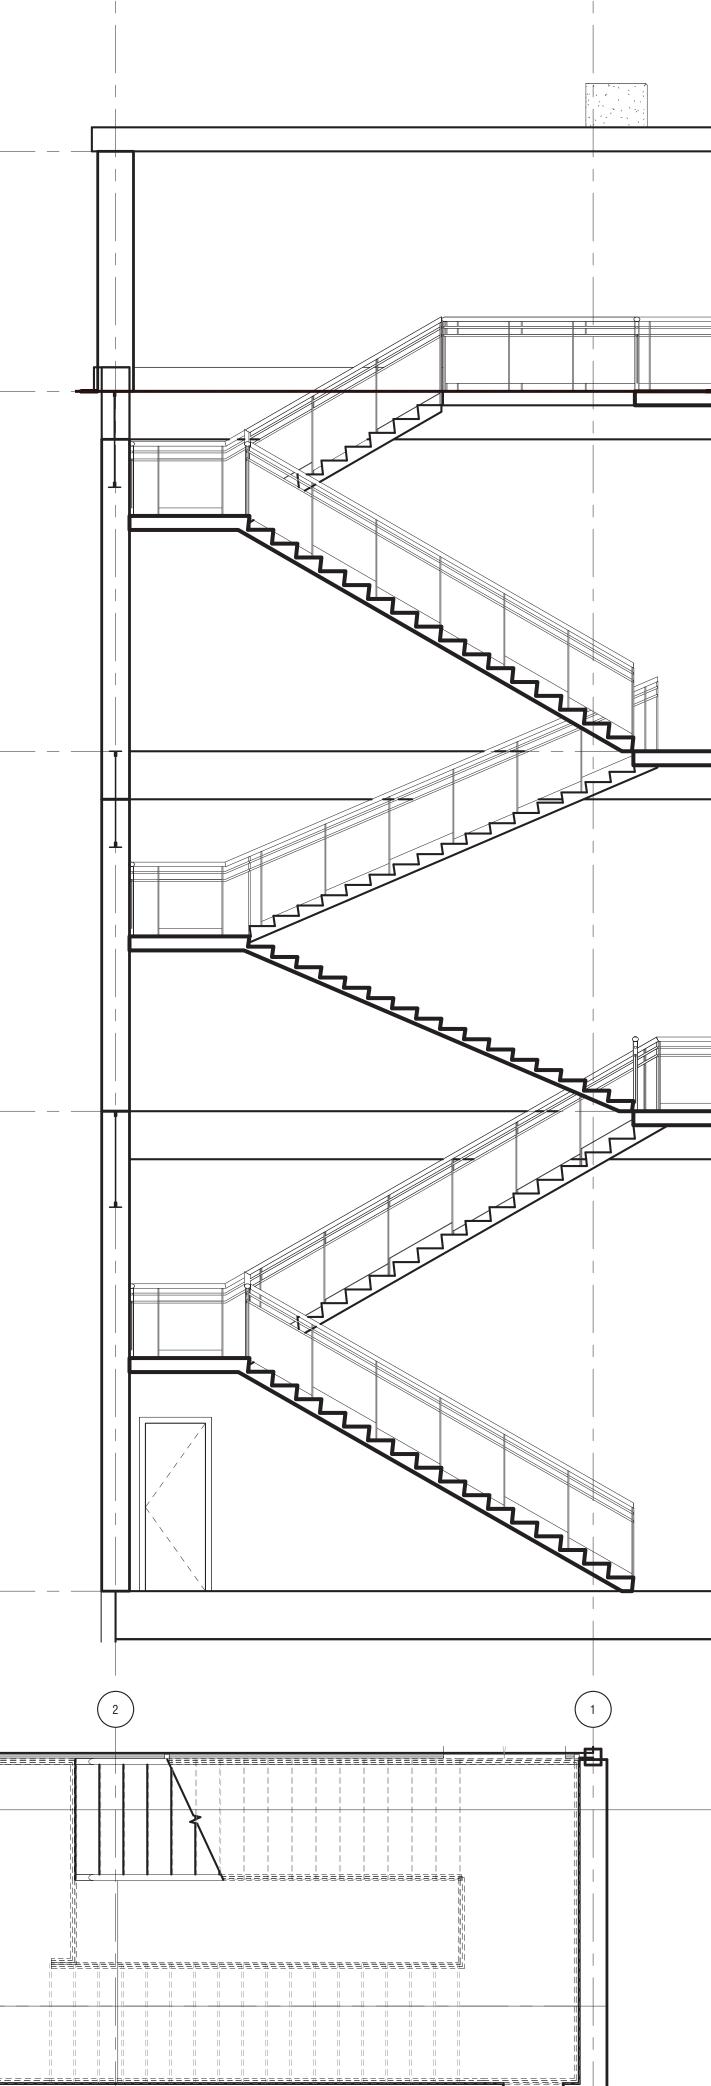

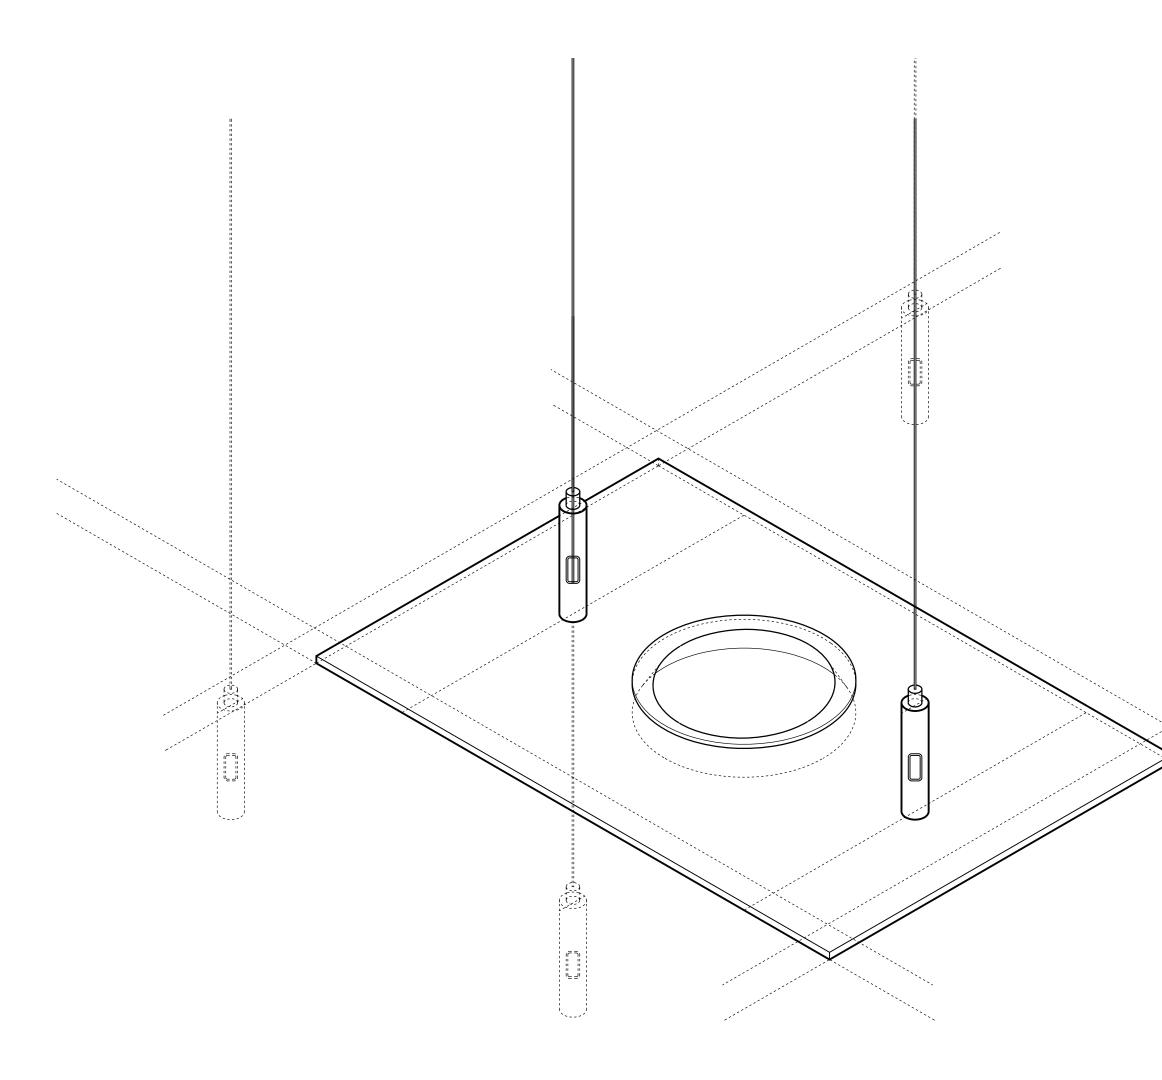

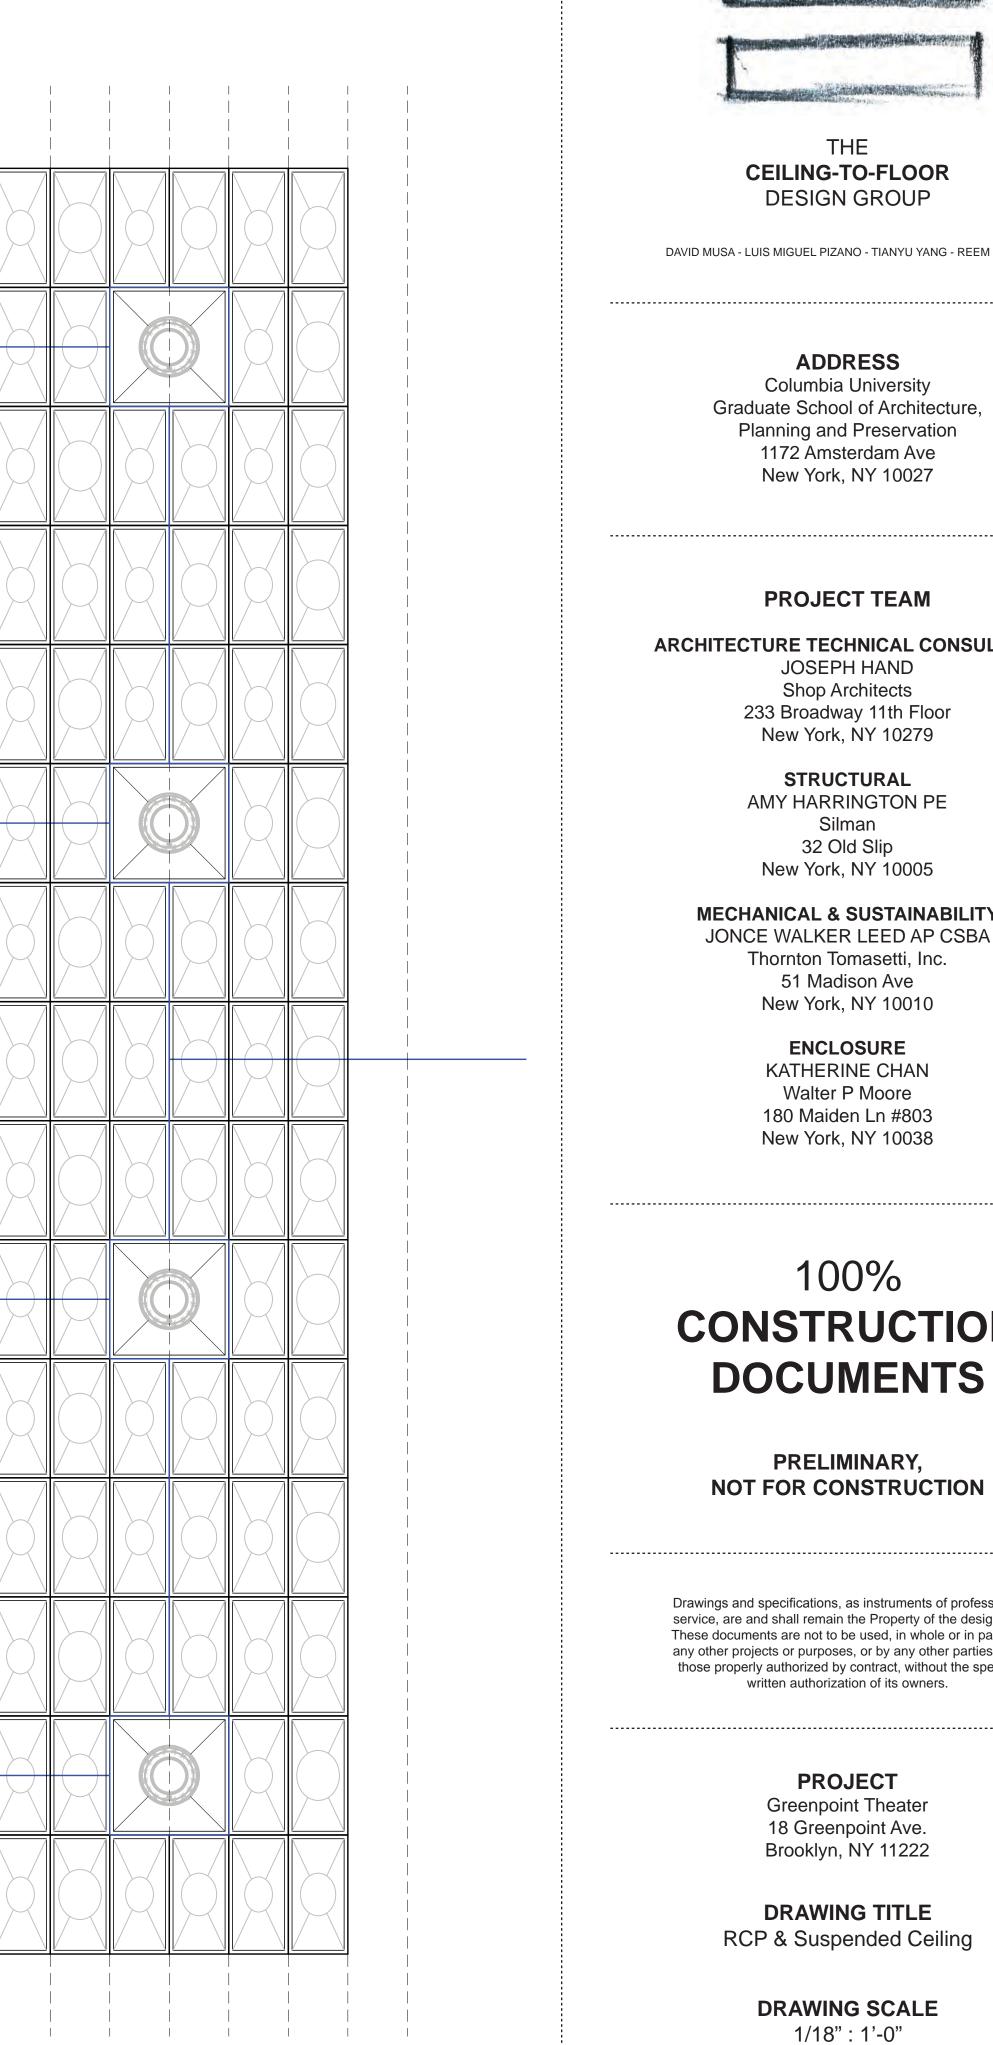

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ISSUE DATE December 13, 2019

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Walter P Moore

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> PROJECT Greenpoint Theater

Brooklyn, NY 11222

DRAWING TITLE RCP & Suspended Ceiling

and the second

CEILING-TO-FLOOR DESIGN GROUP

DAVID MUSA - LUIS MIGUEL PIZANO - TIANYU YANG - REEM YASSIN

ADDRESS

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ARCHITECTURE TECHNICAL CONSULTING

Shop Architects 233 Broadway 11th Floor New York, NY 10279


AMY HARRINGTON PE New York, NY 10005


MECHANICAL & SUSTAINABILITY

KATHERINE CHAN

180 Maiden Ln #803 New York, NY 10038

written authorization of its owners.

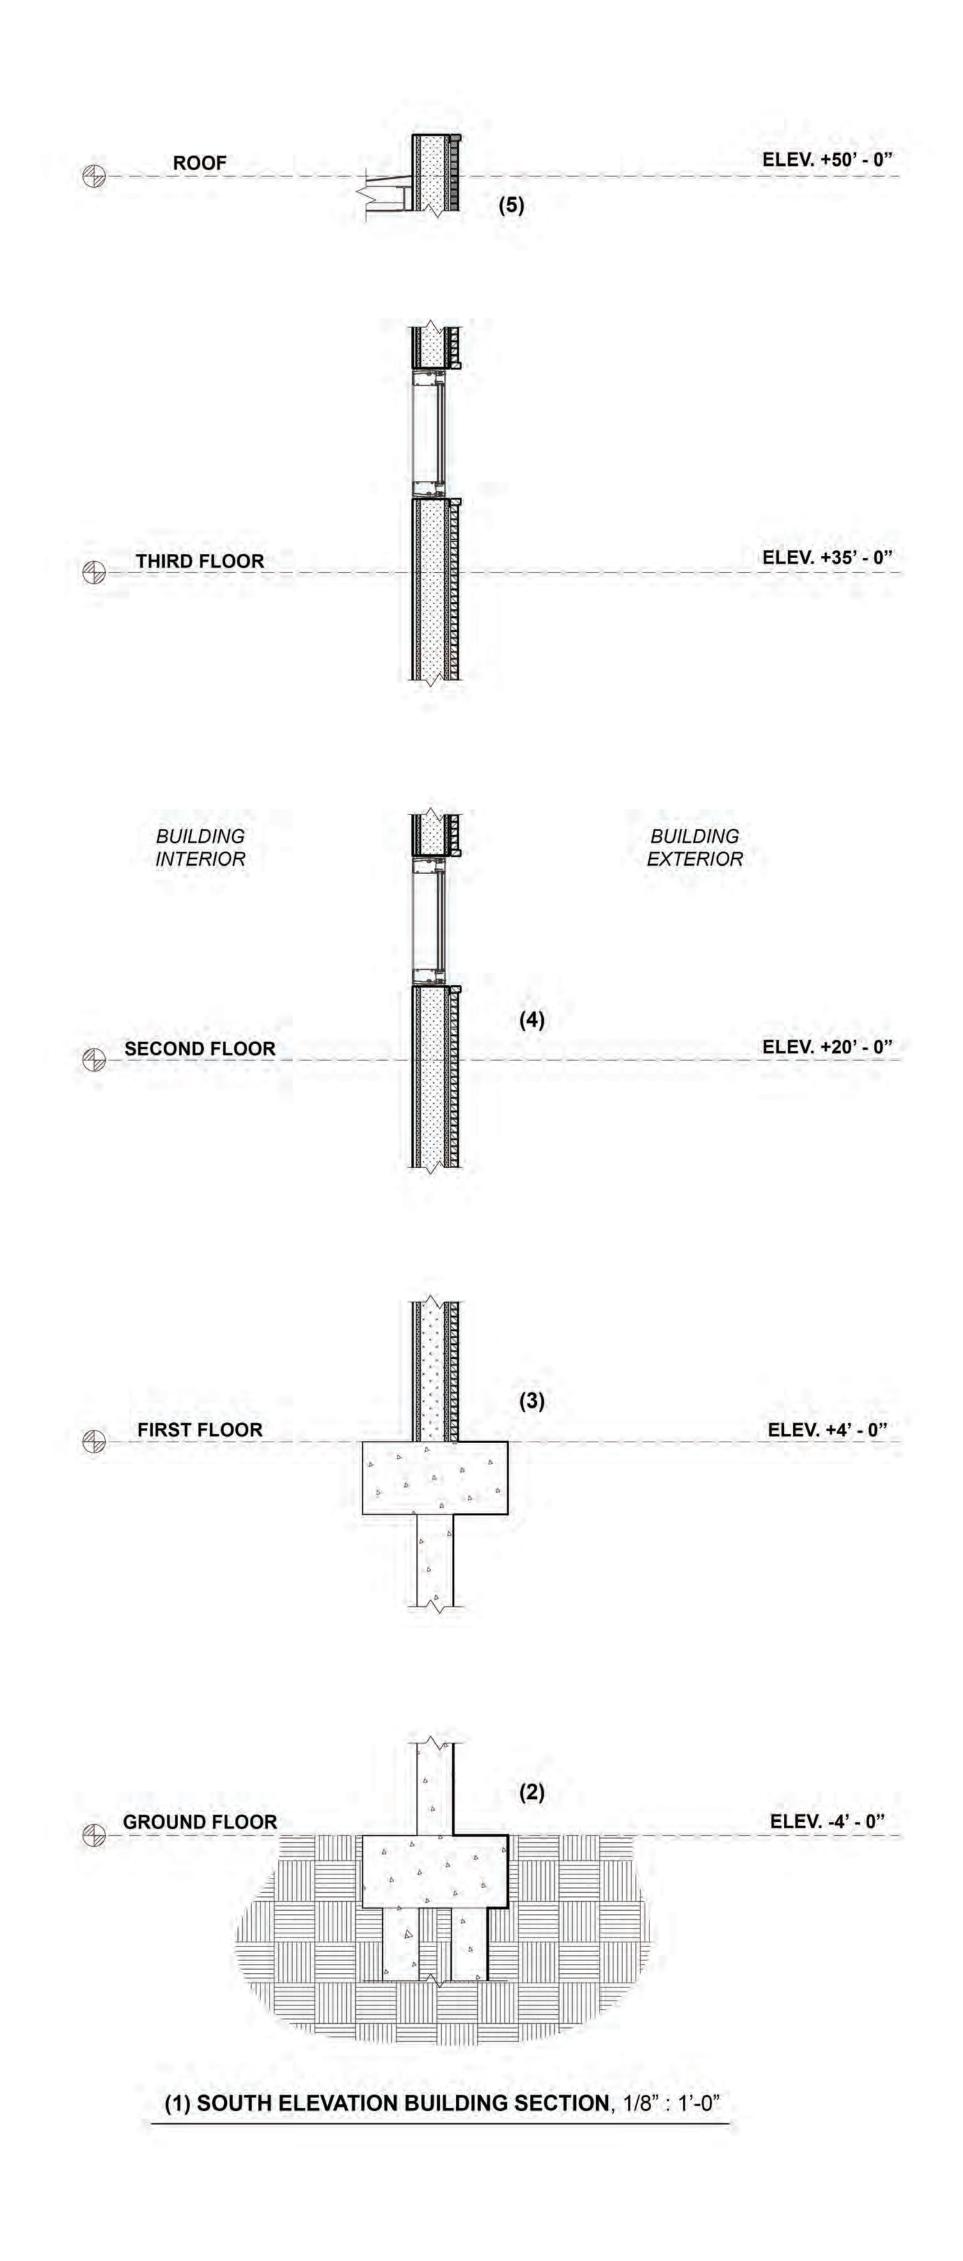

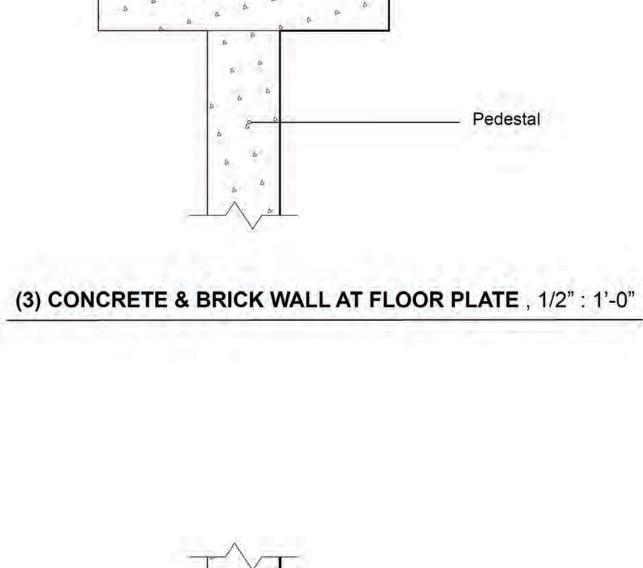

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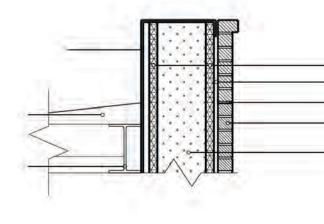
Recovered Brick Veneer

2" Insulation Board


12" Concrete Column


- 5" Slab in Grade

Grout





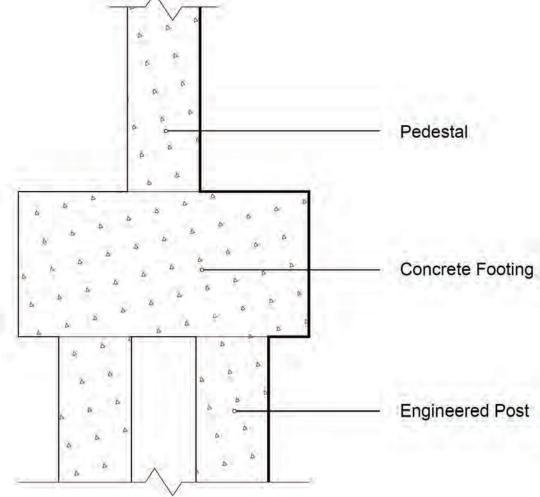

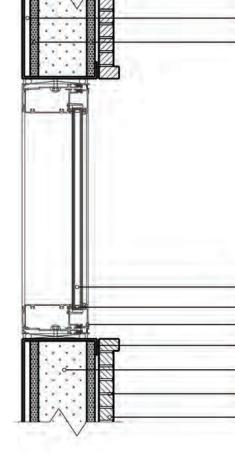

(2) FOUNDATION , 1/2" : 1'-0"

(4) WINDOW OPENING, 1/2": 1'-0"

2" Insulation Board - Air Space Grout Recovered Brick Veneer

12" Concrete Column

Air Space 2" Insulation Board

Low-E Argon Tripled Glazed System Spacer & Desiccant Steel Window Frame 5/8" Gypsum Board 12" Concrete Column Grout

Recovered Brick Veneer



THE **CEILING-TO-FLOOR** DESIGN GROUP

DAVID MUSA - LUIS MIGUEL PIZANO - TIANYU YANG - REEM YASSIN

ADDRESS

Columbia University Graduate School of Architecture, Planning and Preservation 1172 Amsterdam Ave New York, NY 10027

PROJECT TEAM

ARCHITECTURE TECHNICAL CONSULTING

JOSEPH HAND Shop Architects 233 Broadway 11th Floor New York, NY 10279

STRUCTURAL AMY HARRINGTON PE Silman 32 Old Slip New York, NY 10005

MECHANICAL & SUSTAINABILITY

JONCE WALKER LEED AP CSBA Thornton Tomasetti, Inc. 51 Madison Ave New York, NY 10010

ENCLOSURE

KATHERINE CHAN Walter P Moore 180 Maiden Ln #803 New York, NY 10038

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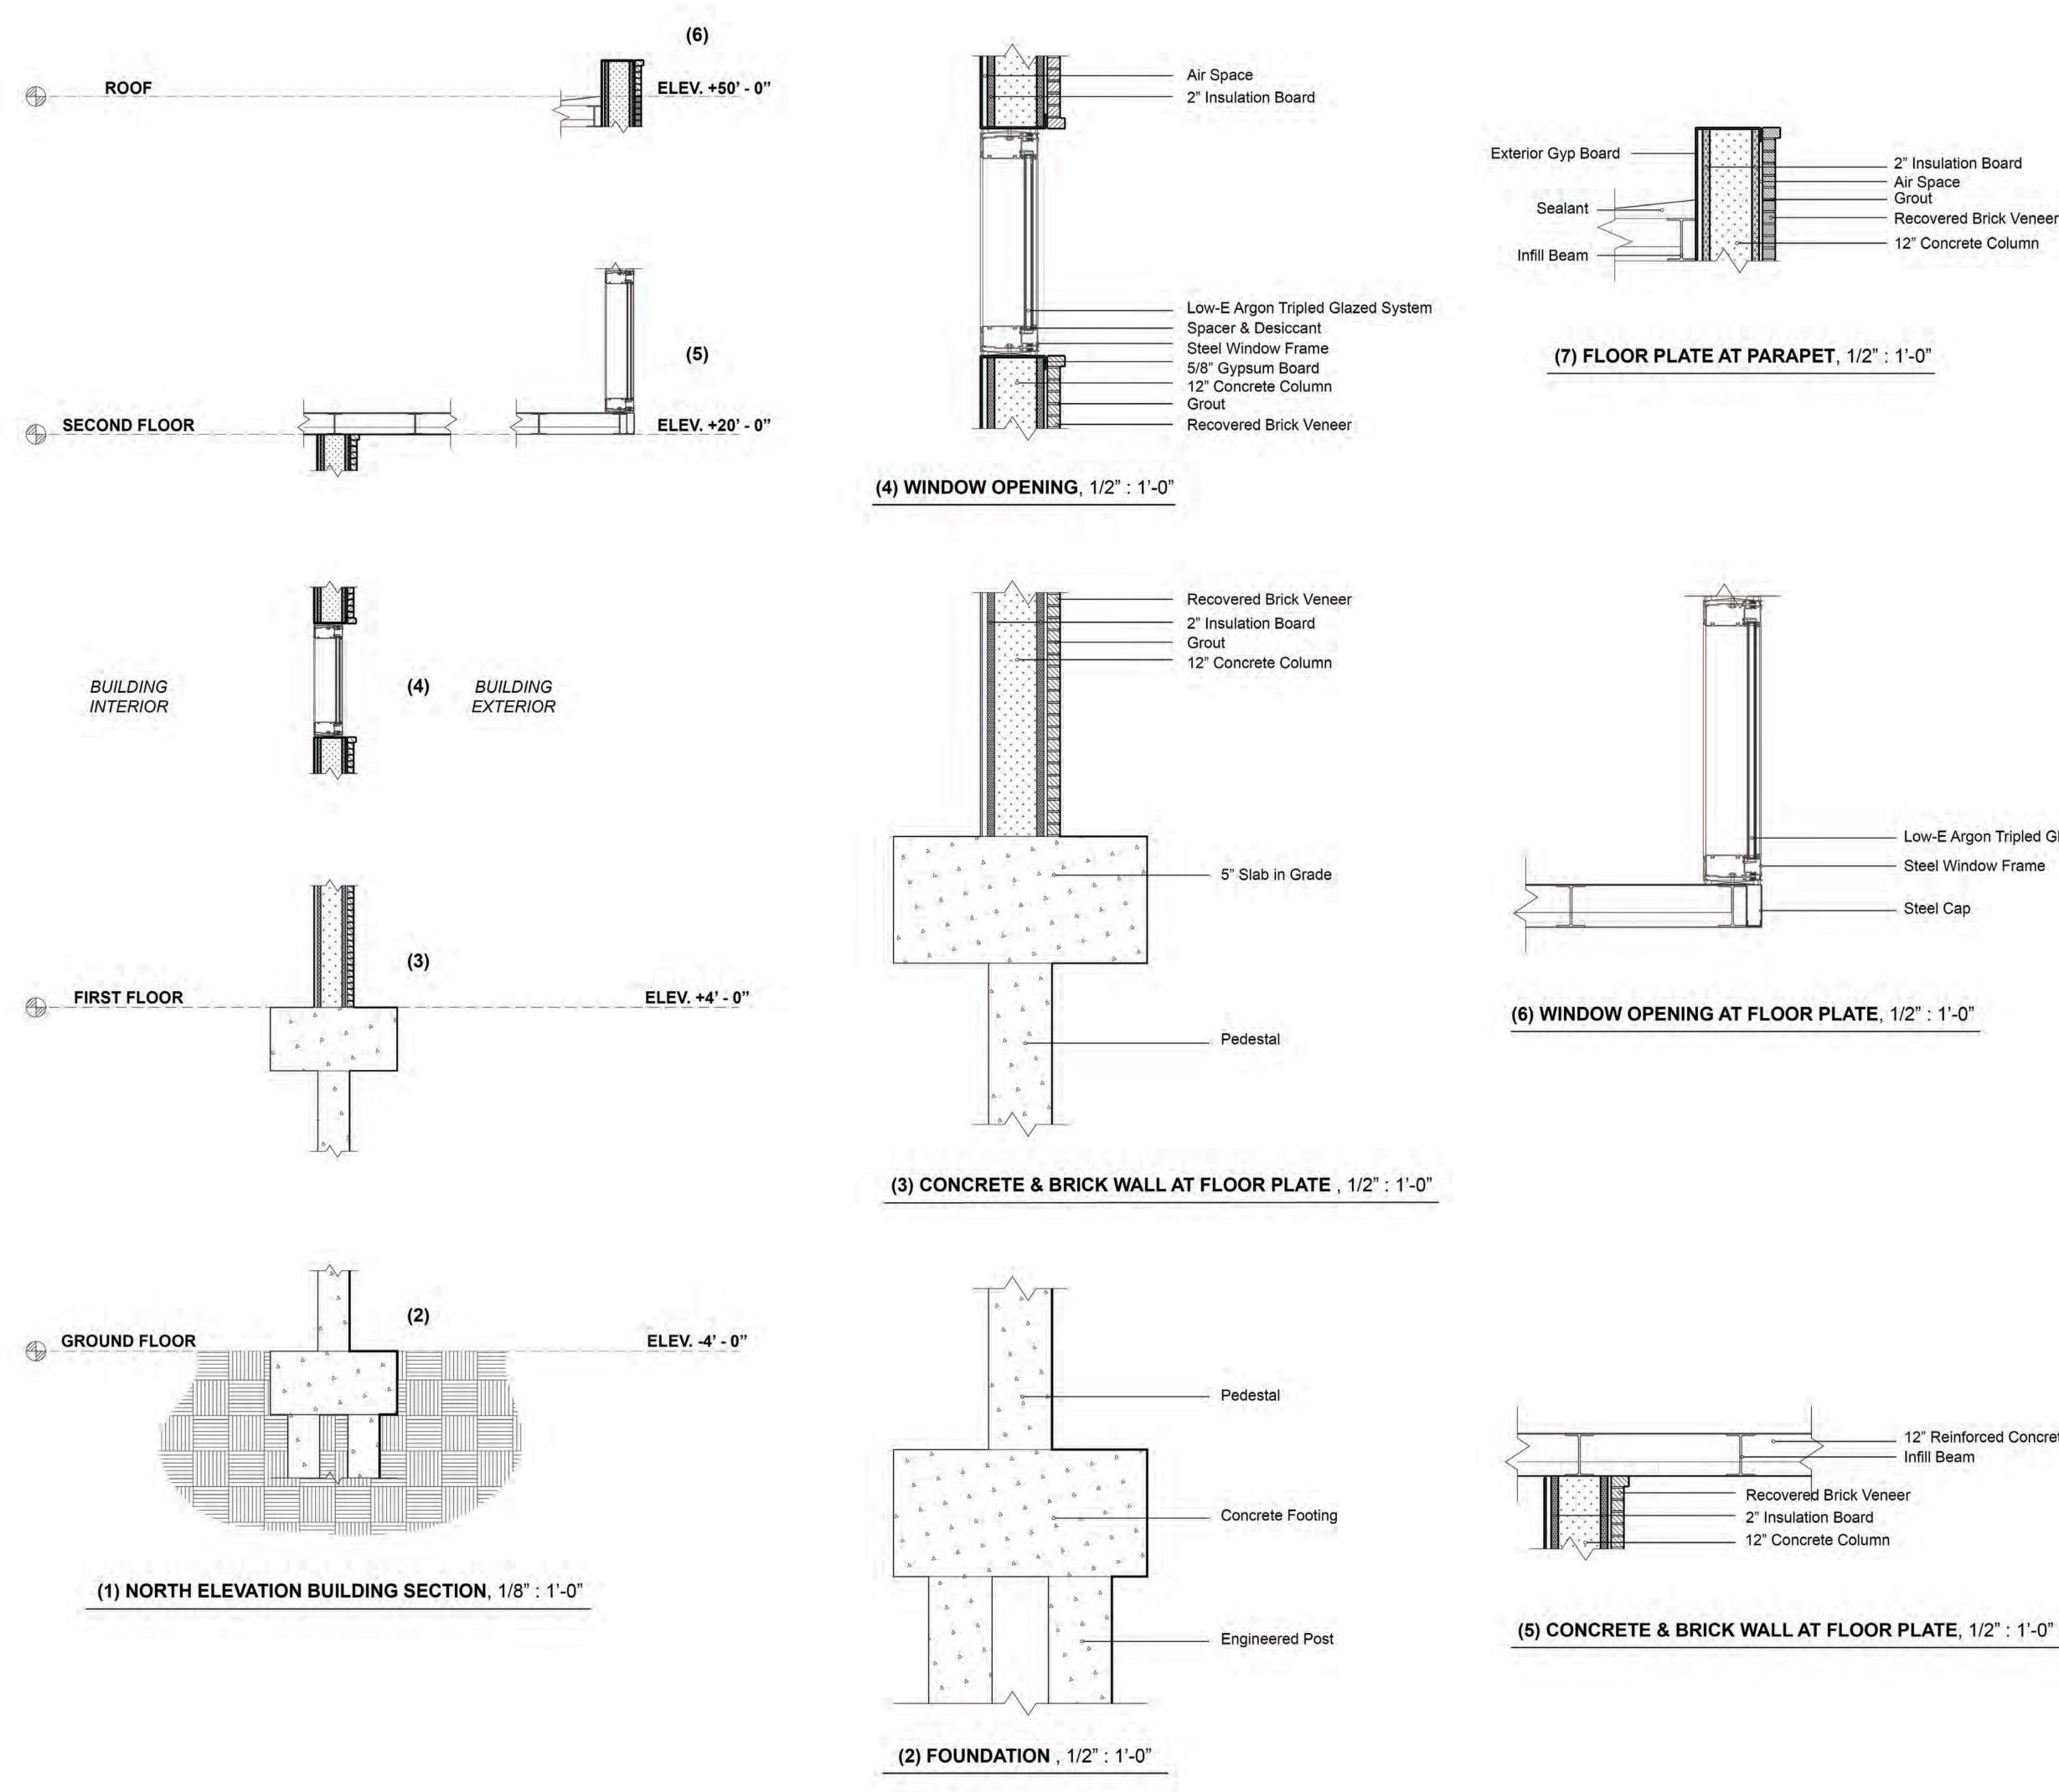
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> PROJECT Greenpoint Theater 18 Greenpoint Ave. Brooklyn, NY 11222

DRAWING TITLE **BOH Sections**

DRAWING SCALE Various

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2" Insulation Board Recovered Brick Veneer - 12" Concrete Column

- Low-E Argon Tripled Glazed System Steel Window Frame

12" Reinforced Concrete Floor Plate Infill Beam



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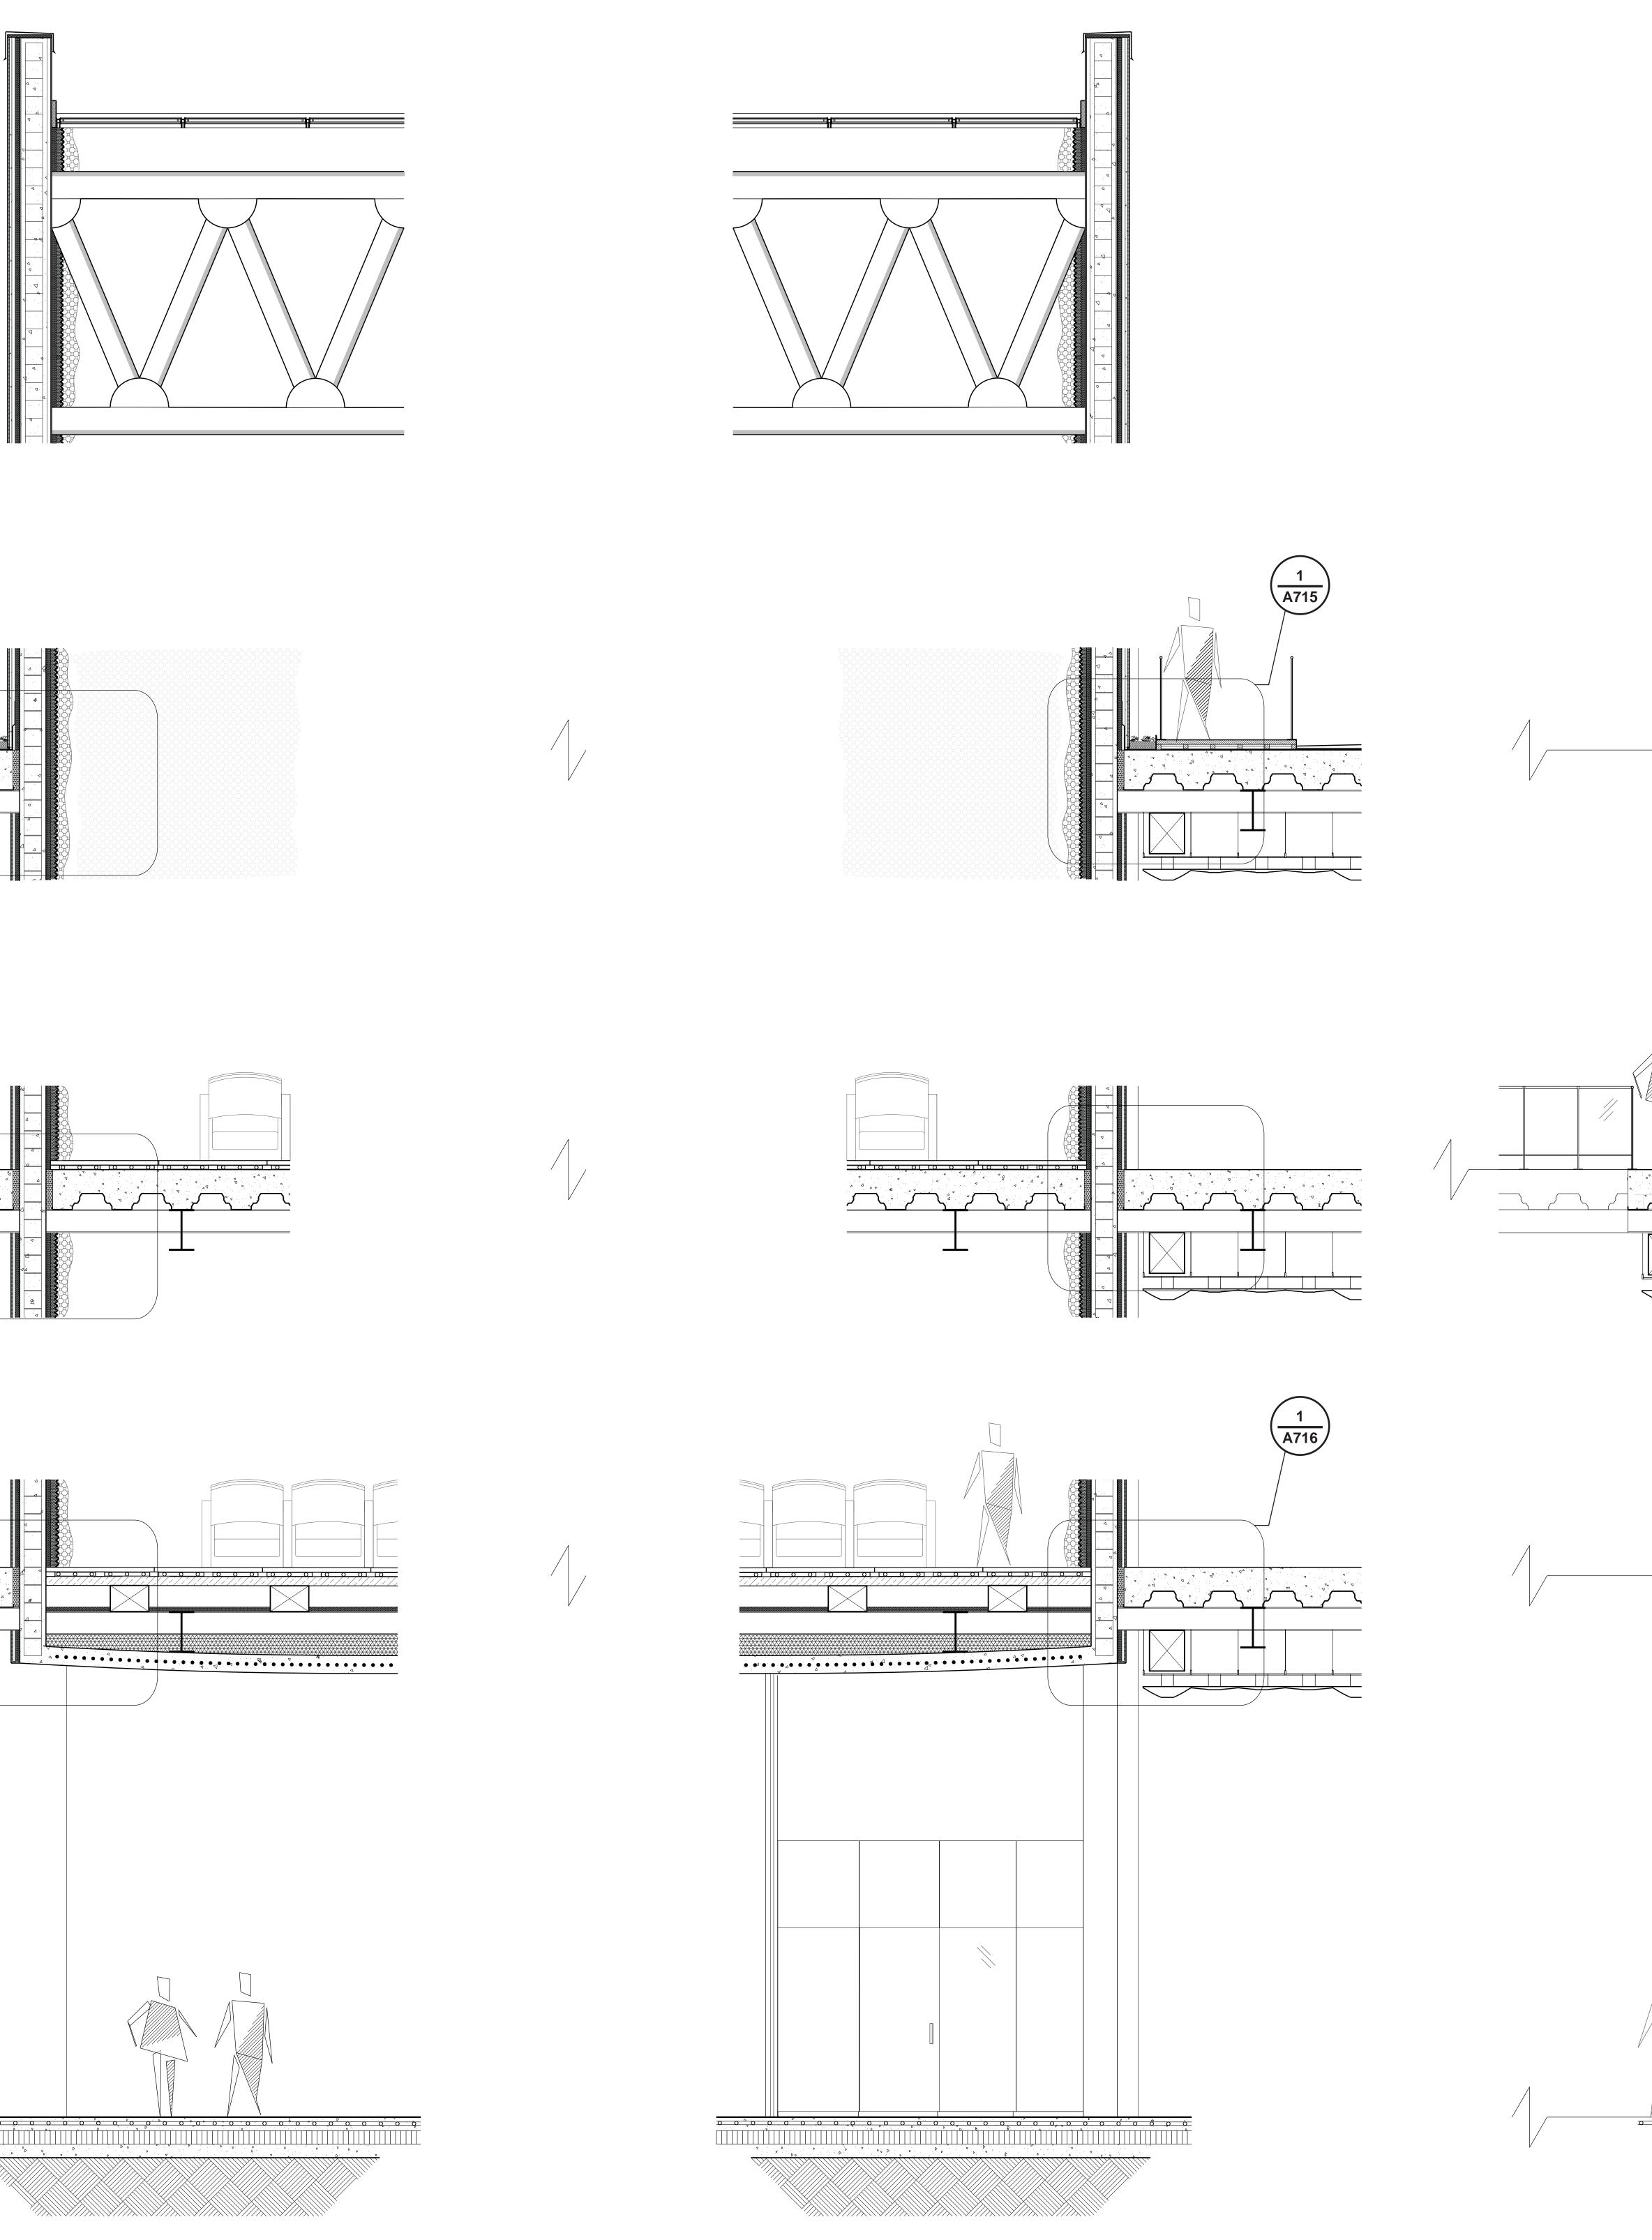
> PROJECT Greenpoint Theater


18 Greenpoint Ave. Brooklyn, NY 11222


DRAWING TITLE FOH Sections


DRAWING SCALE Various


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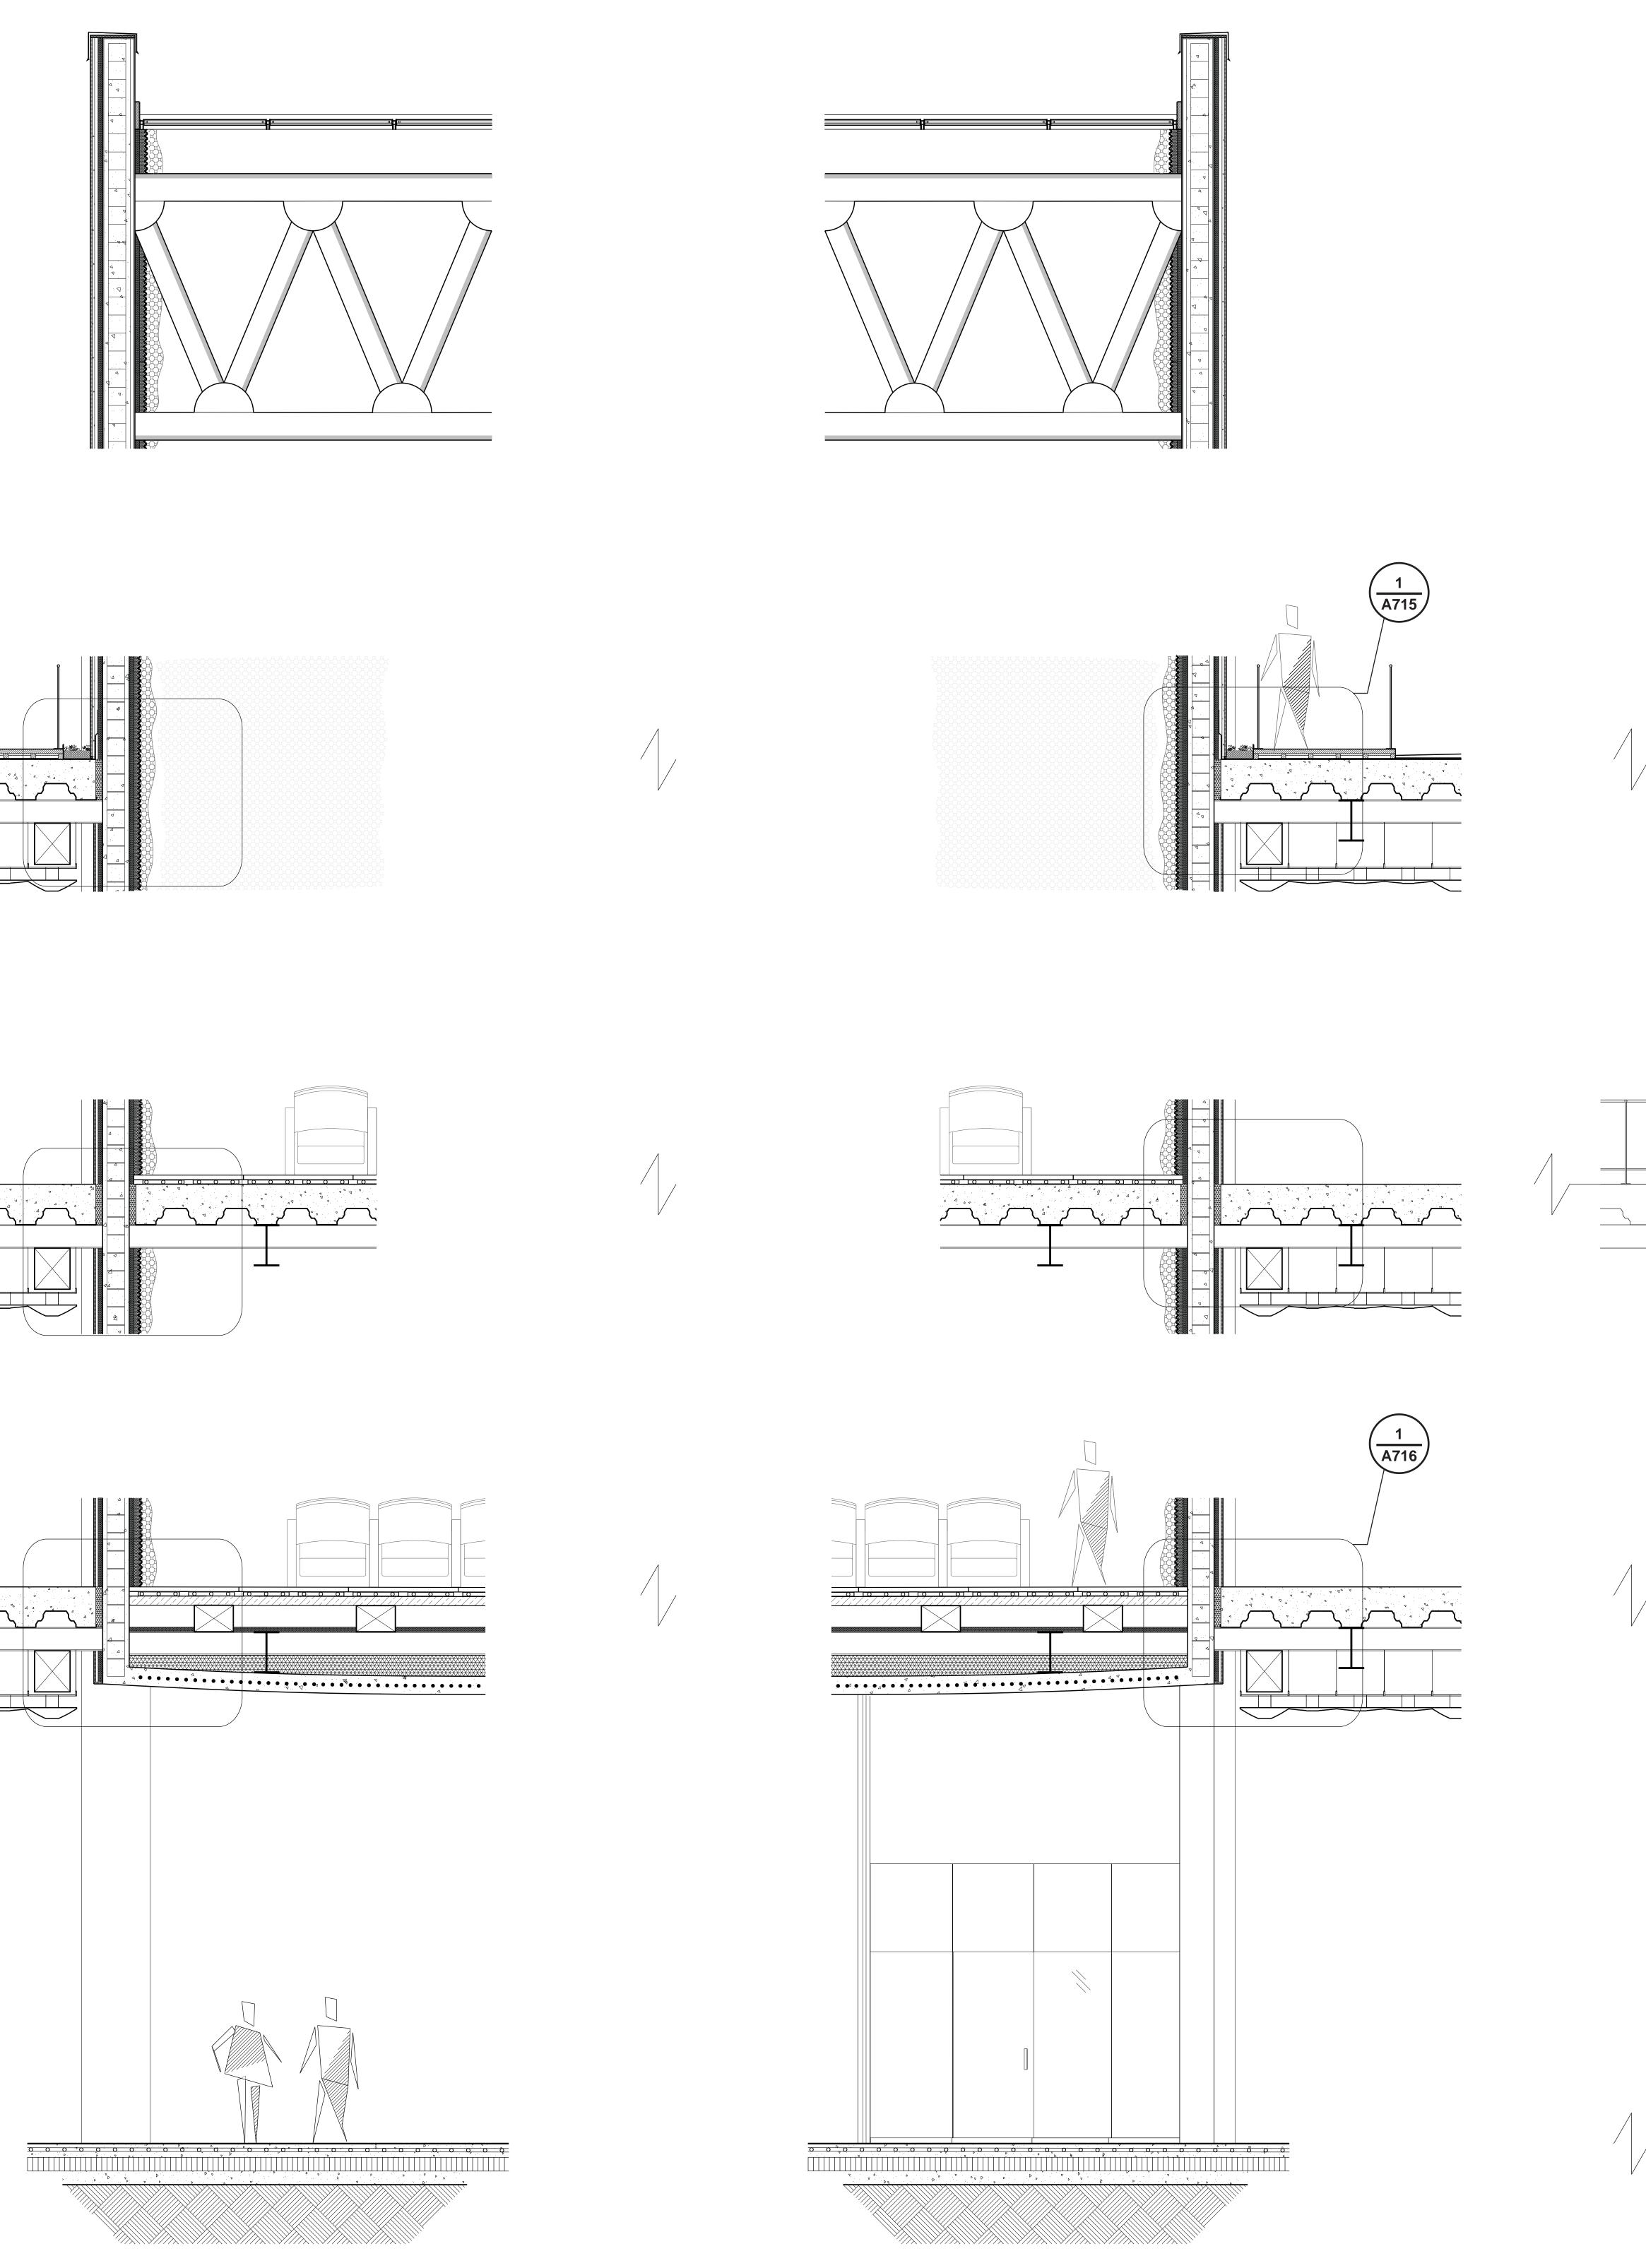




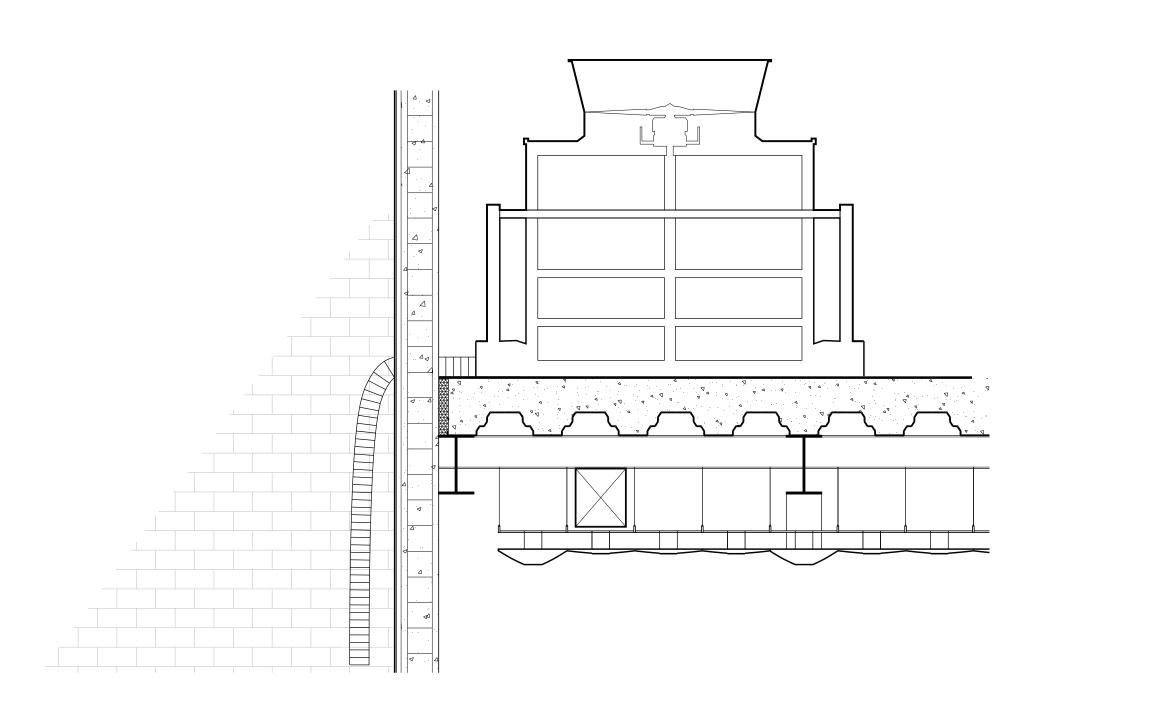

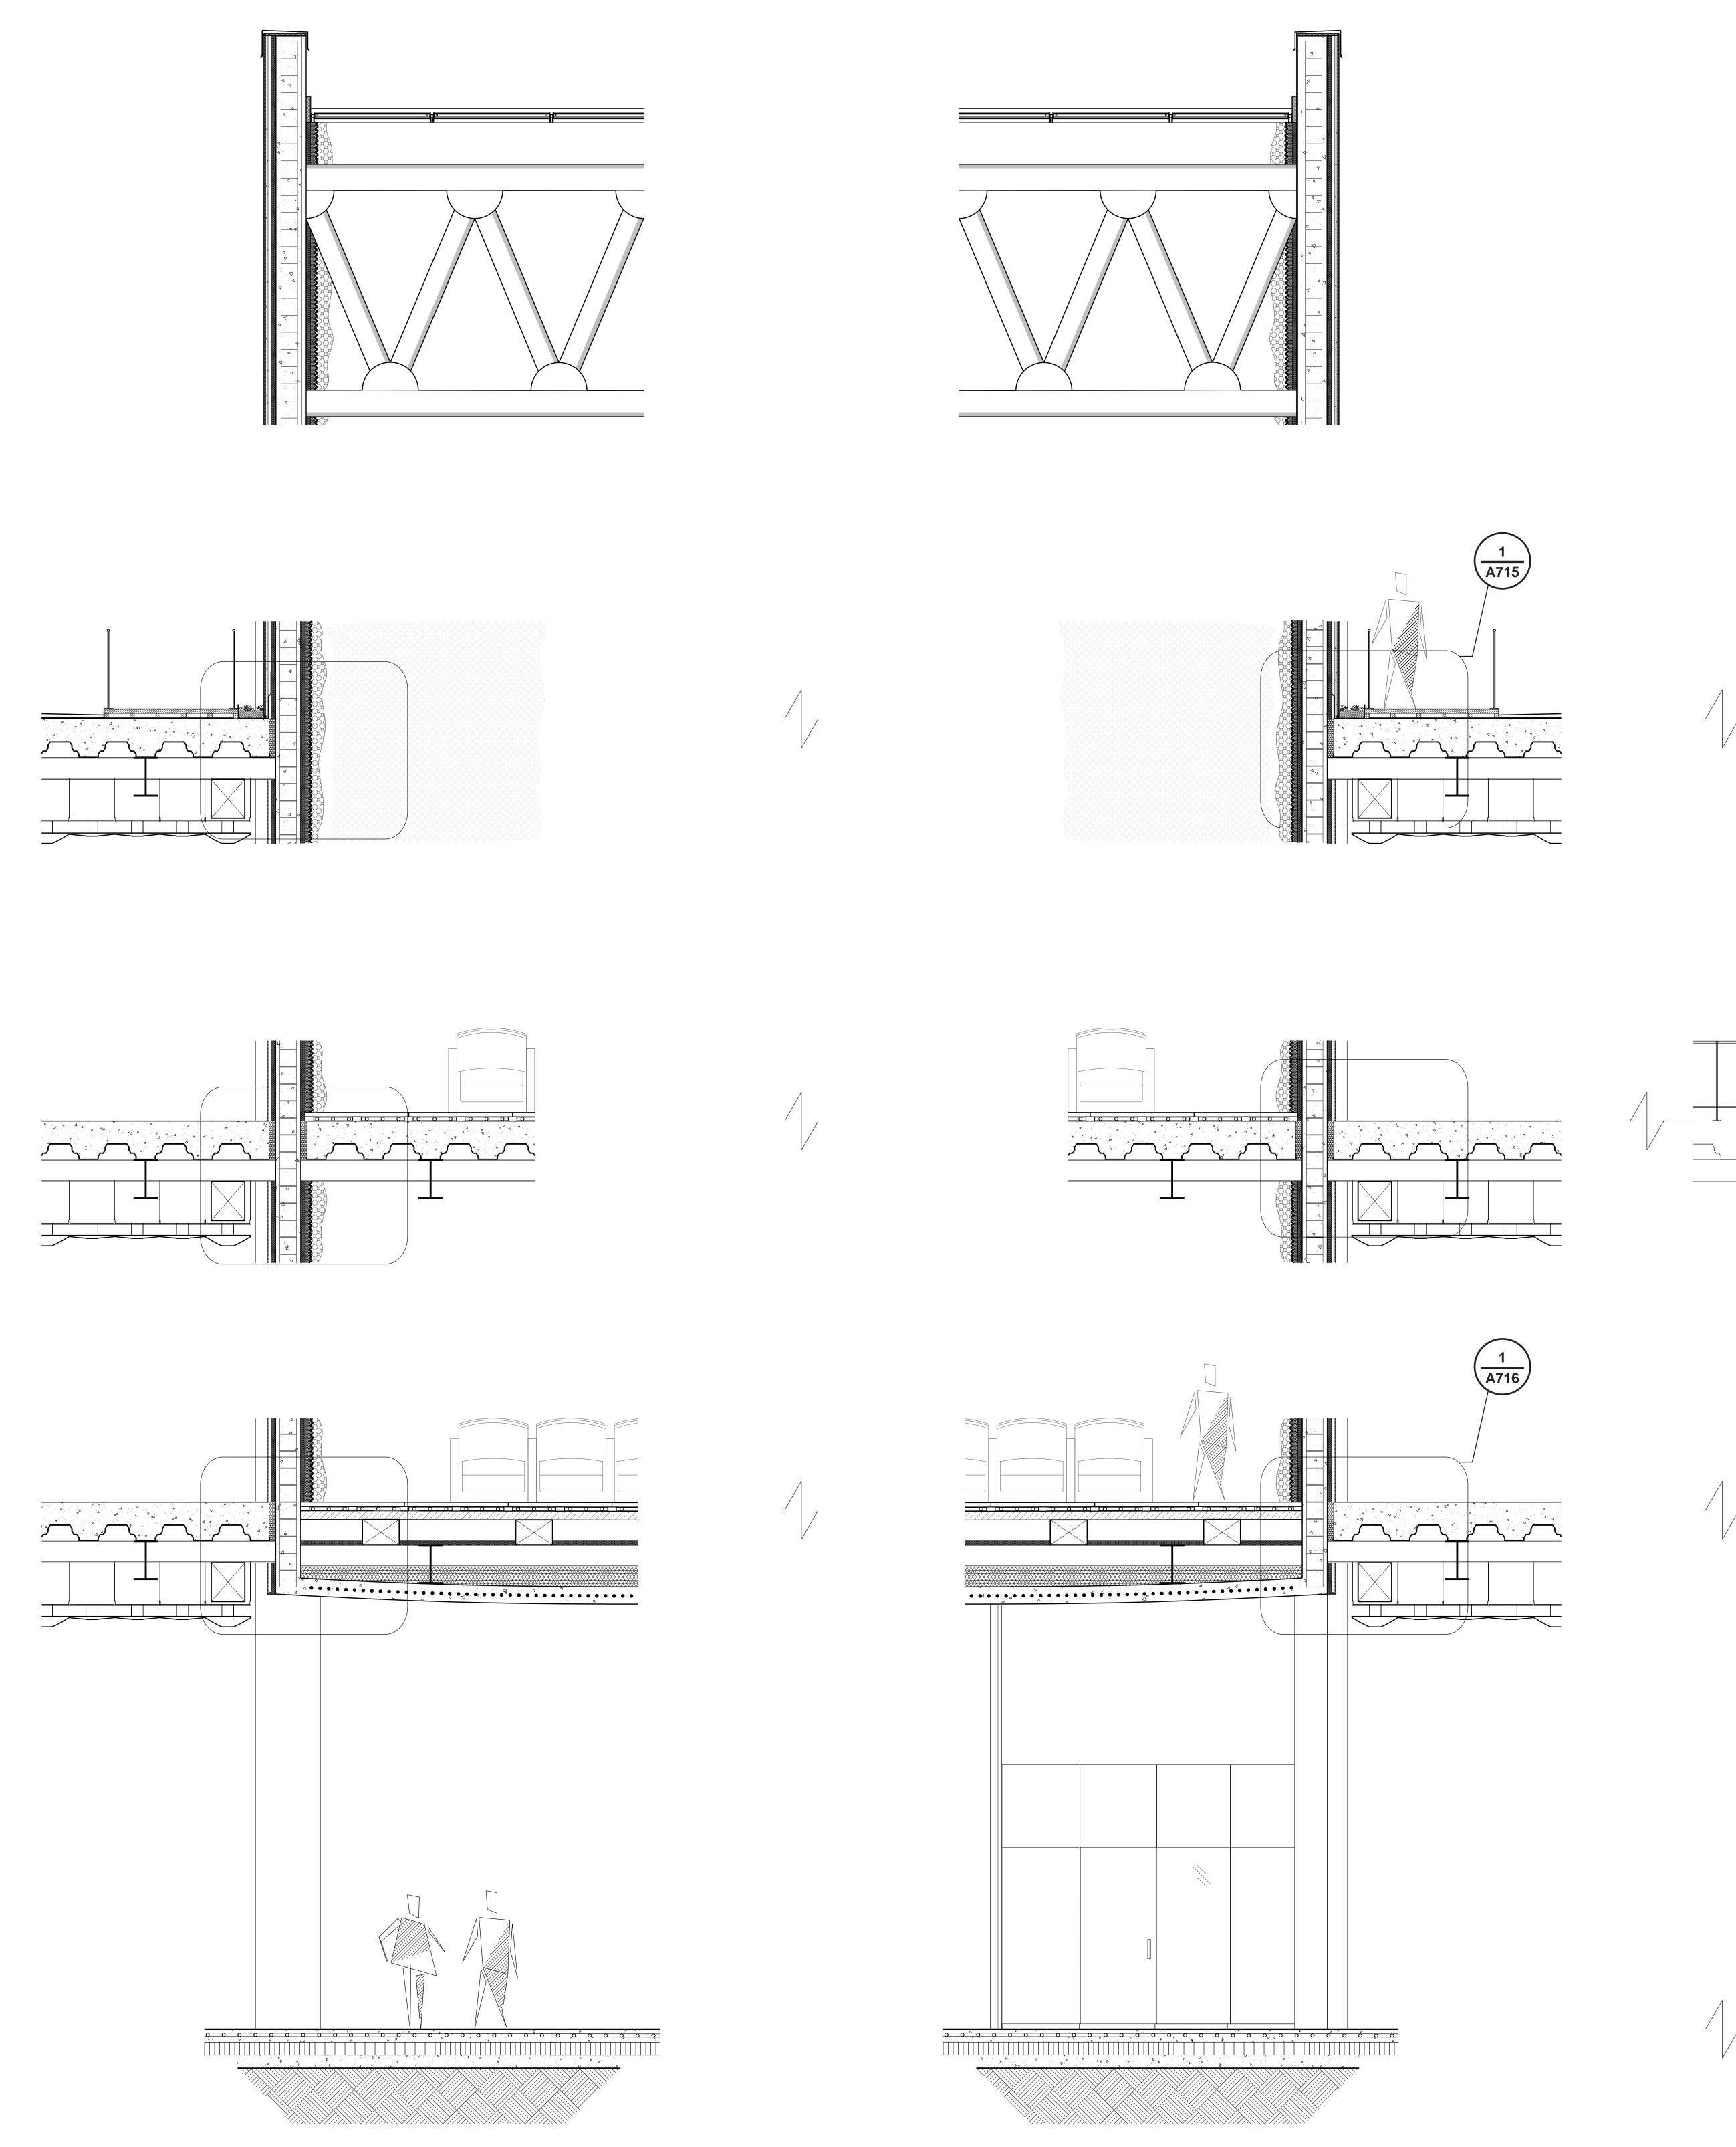


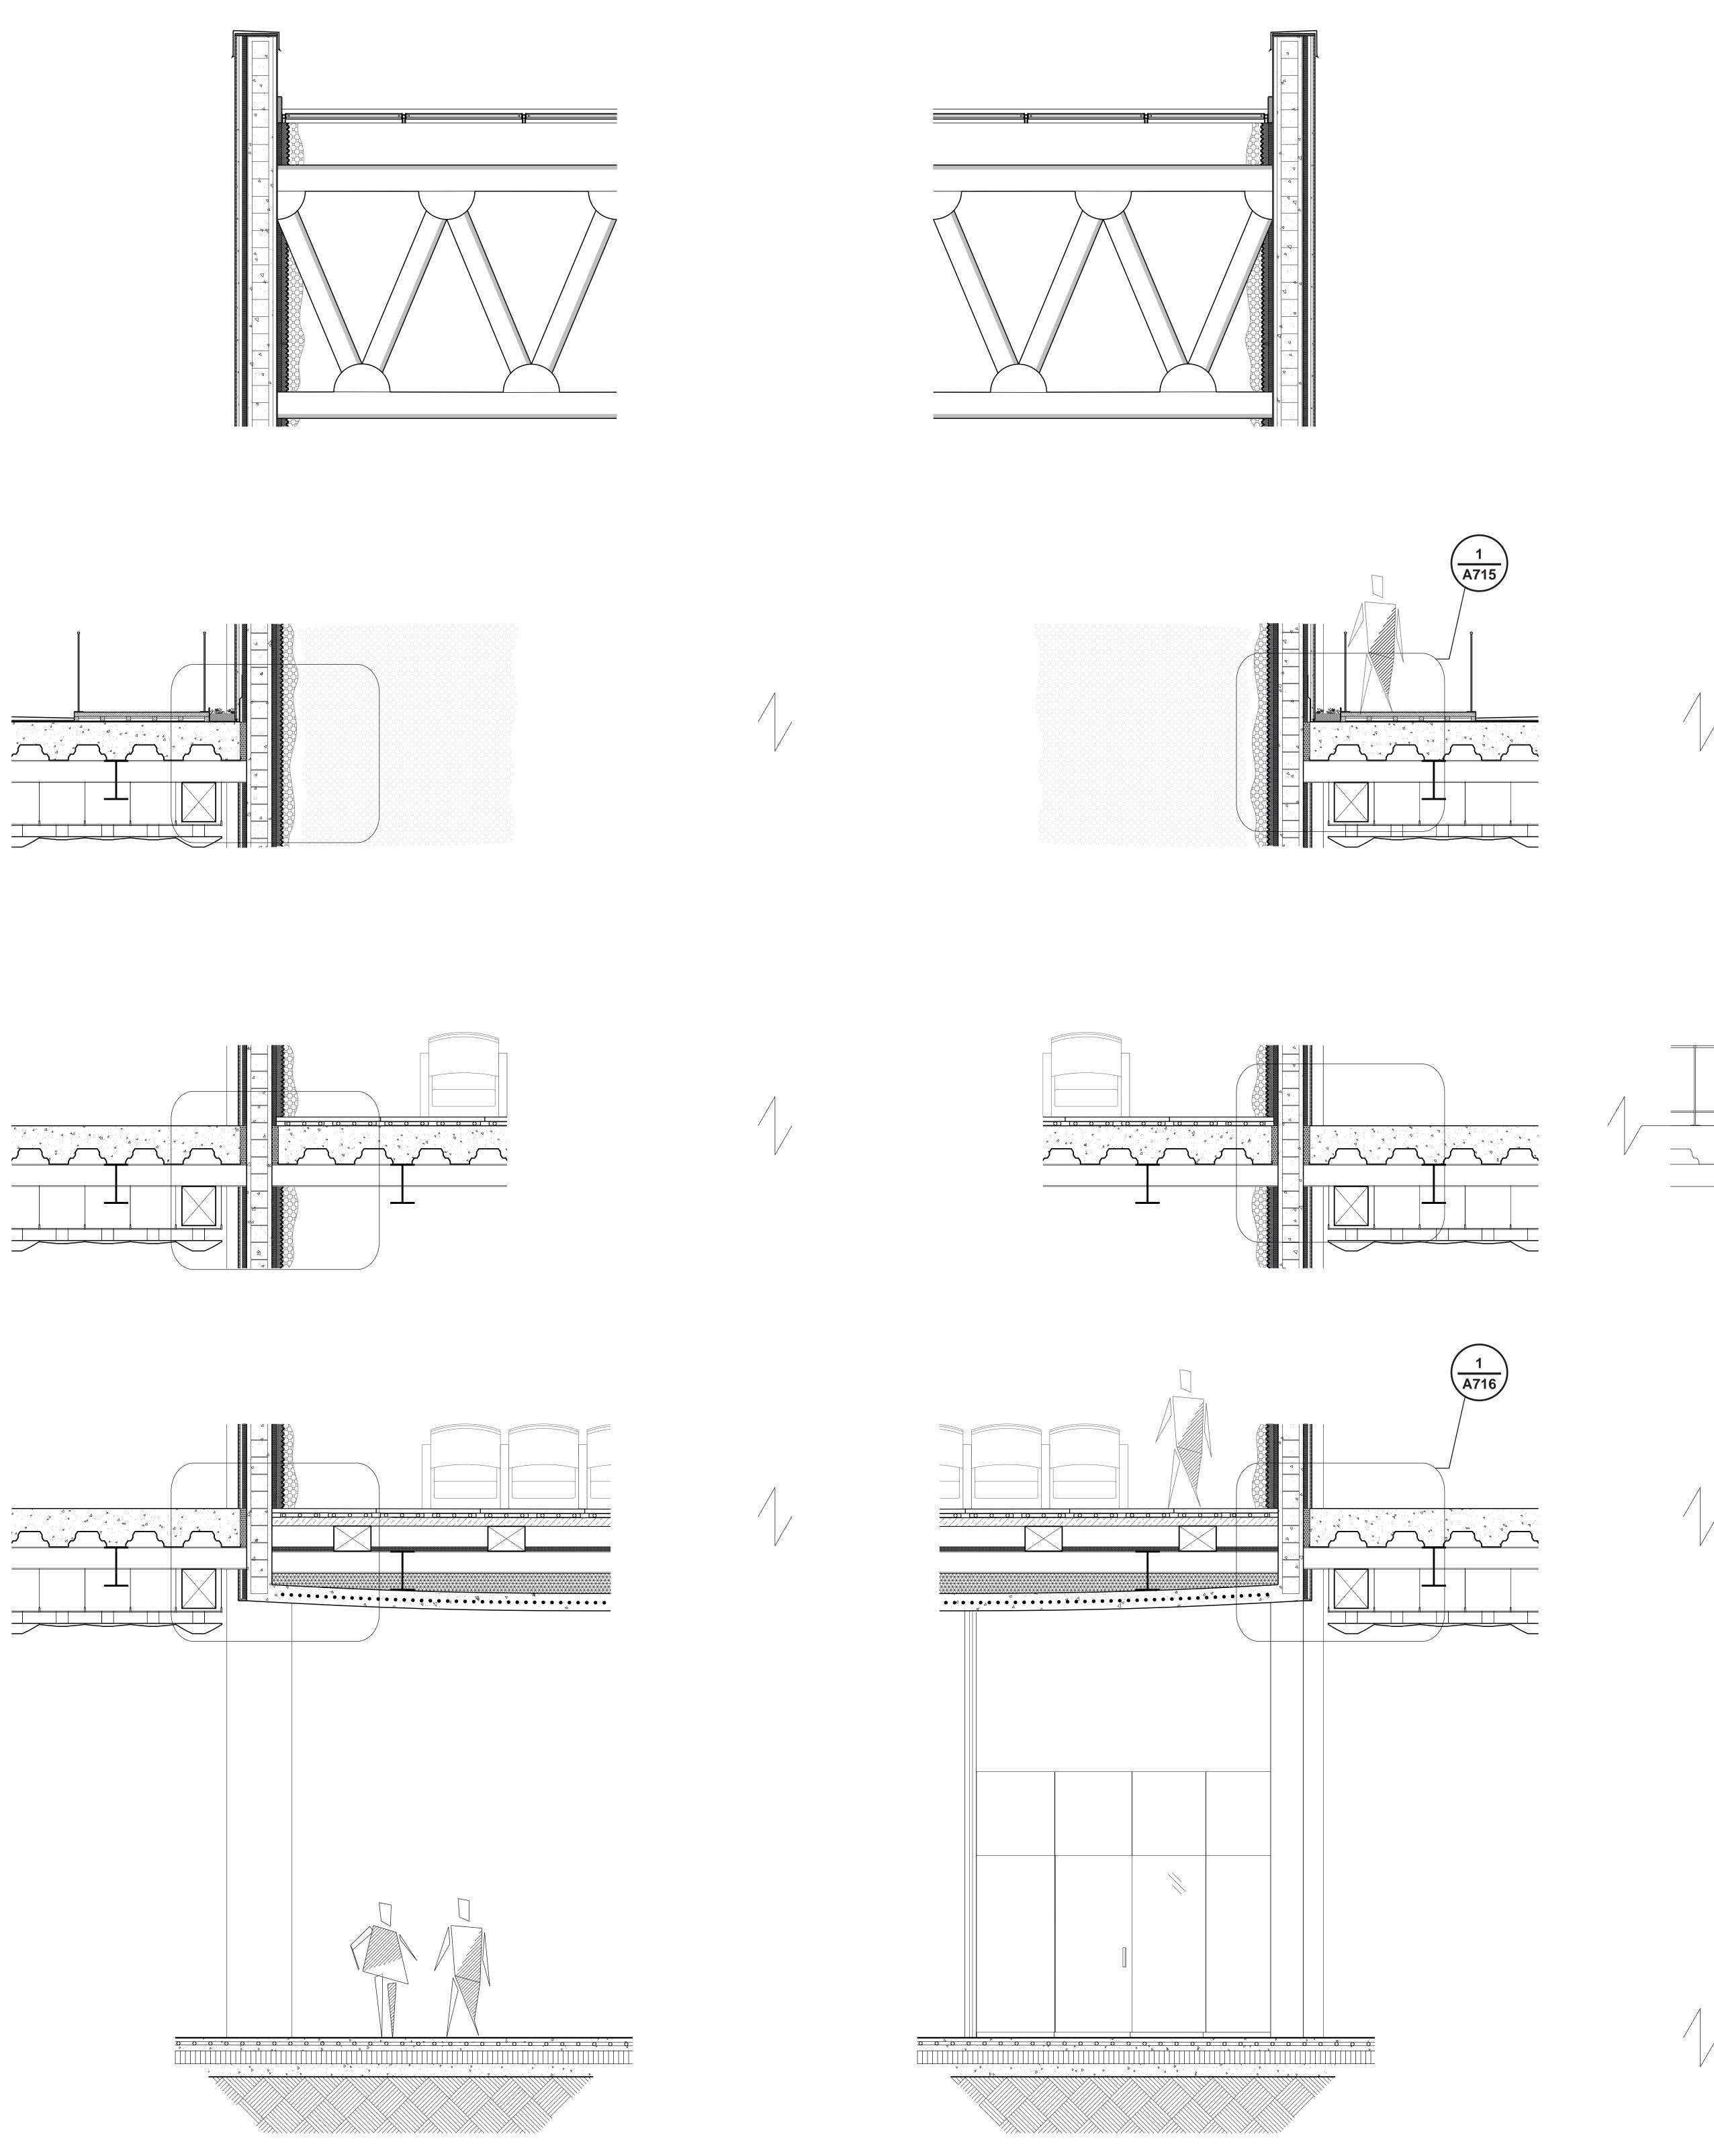


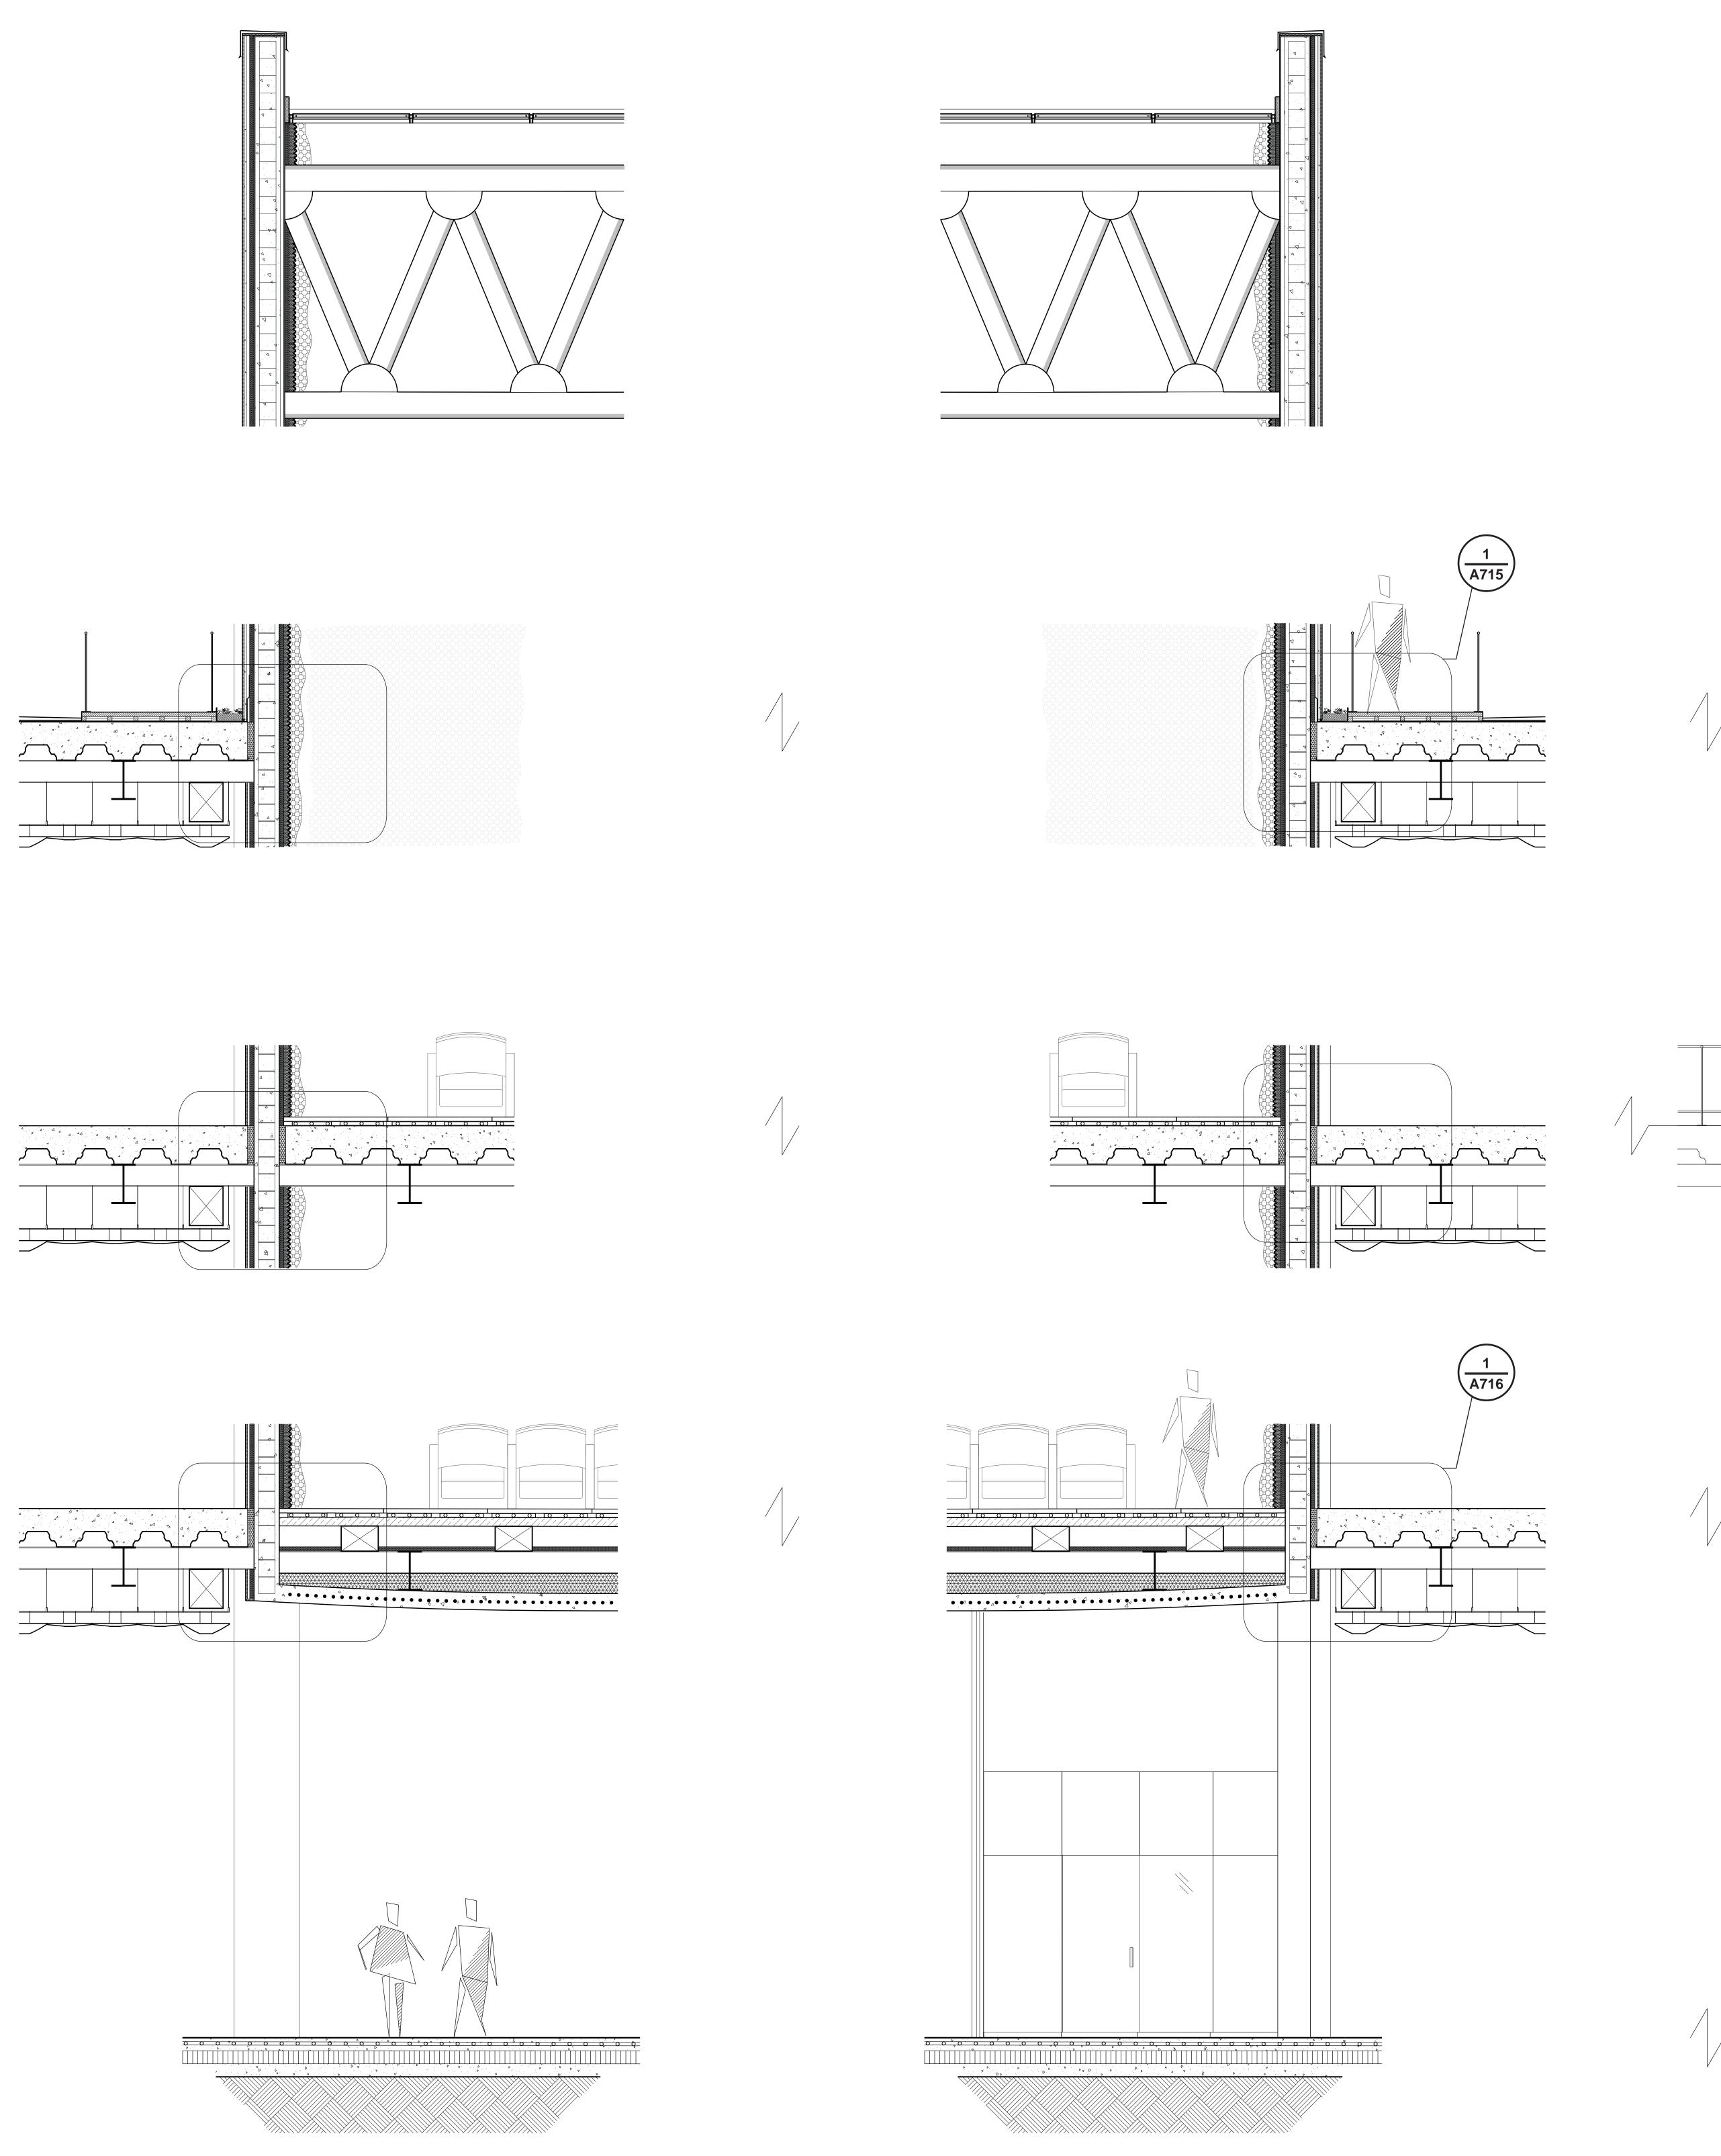

THEATER & OPEN PERFORMANCE SPACE

THEATER AT ARTIST'S STUDIO

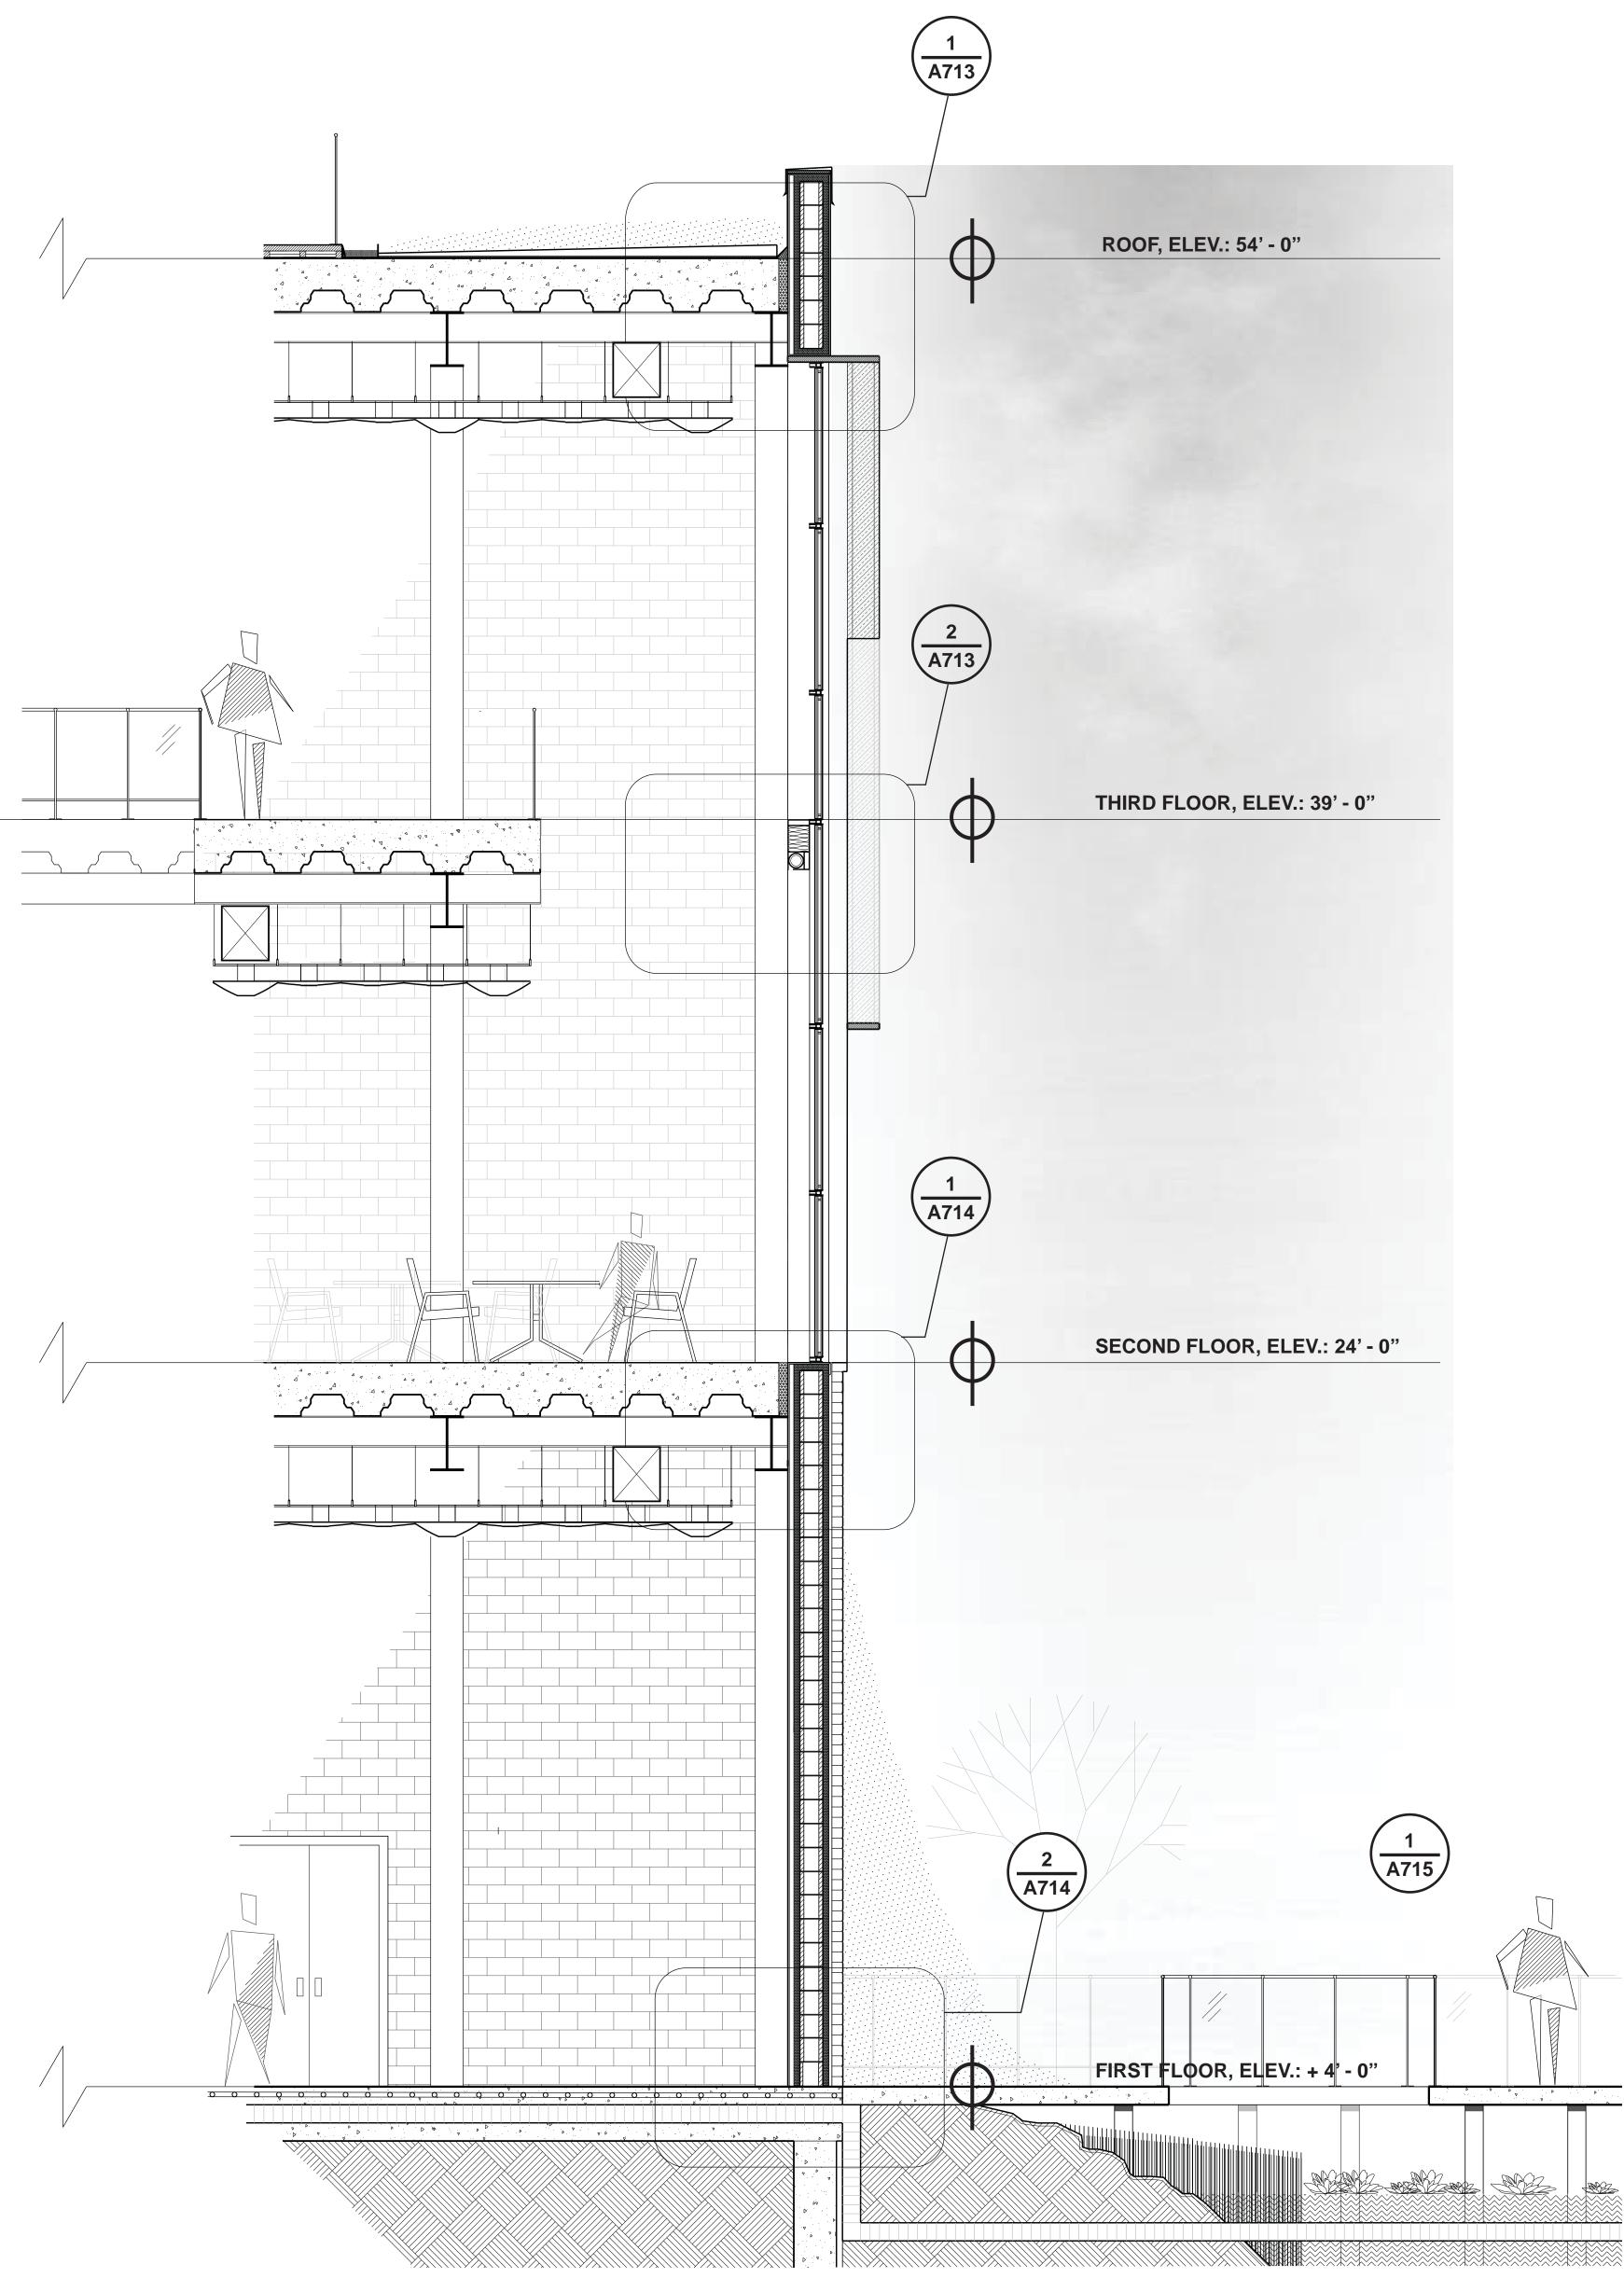

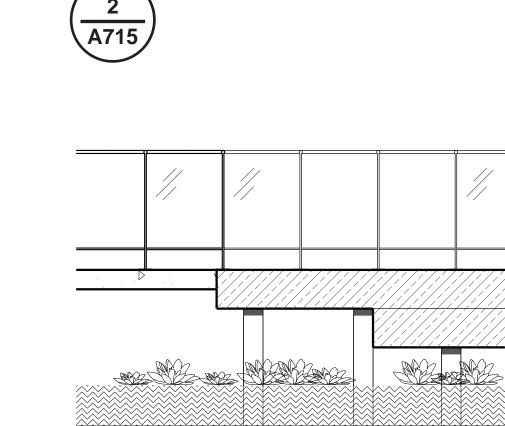

WEST BUILDING ELEVATION

PIER & WATER FEATURE

-	
L	

THE CEILING-TO-FLOOR DESIGN GROUP

DAVID MUSA - LUIS MIGUEL PIZANO - TIANYU YANG - REEM YASSIN

ADDRESS Columbia University Graduate School of Architecture, Planning and Preservation 1172 Amsterdam Ave New York, NY 10027

PROJECT TEAM

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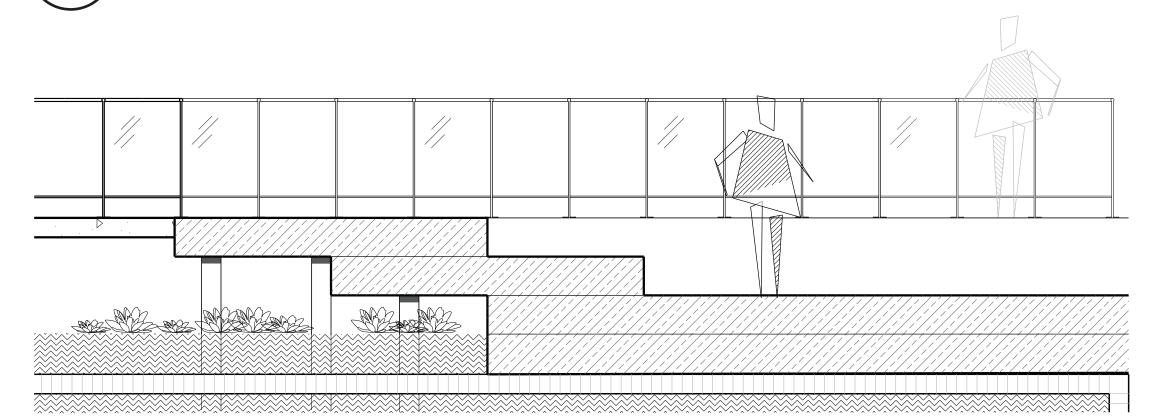
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PROJECT Greenpoint Theater 18 Greenpoint Ave. Brooklyn, NY 11222


DRAWING TITLE Building Section Details

DRAWING SCALE 1/4":1'-0"

ISSUE DATE November 26, 2019



PERFORMANCE PLATFORM

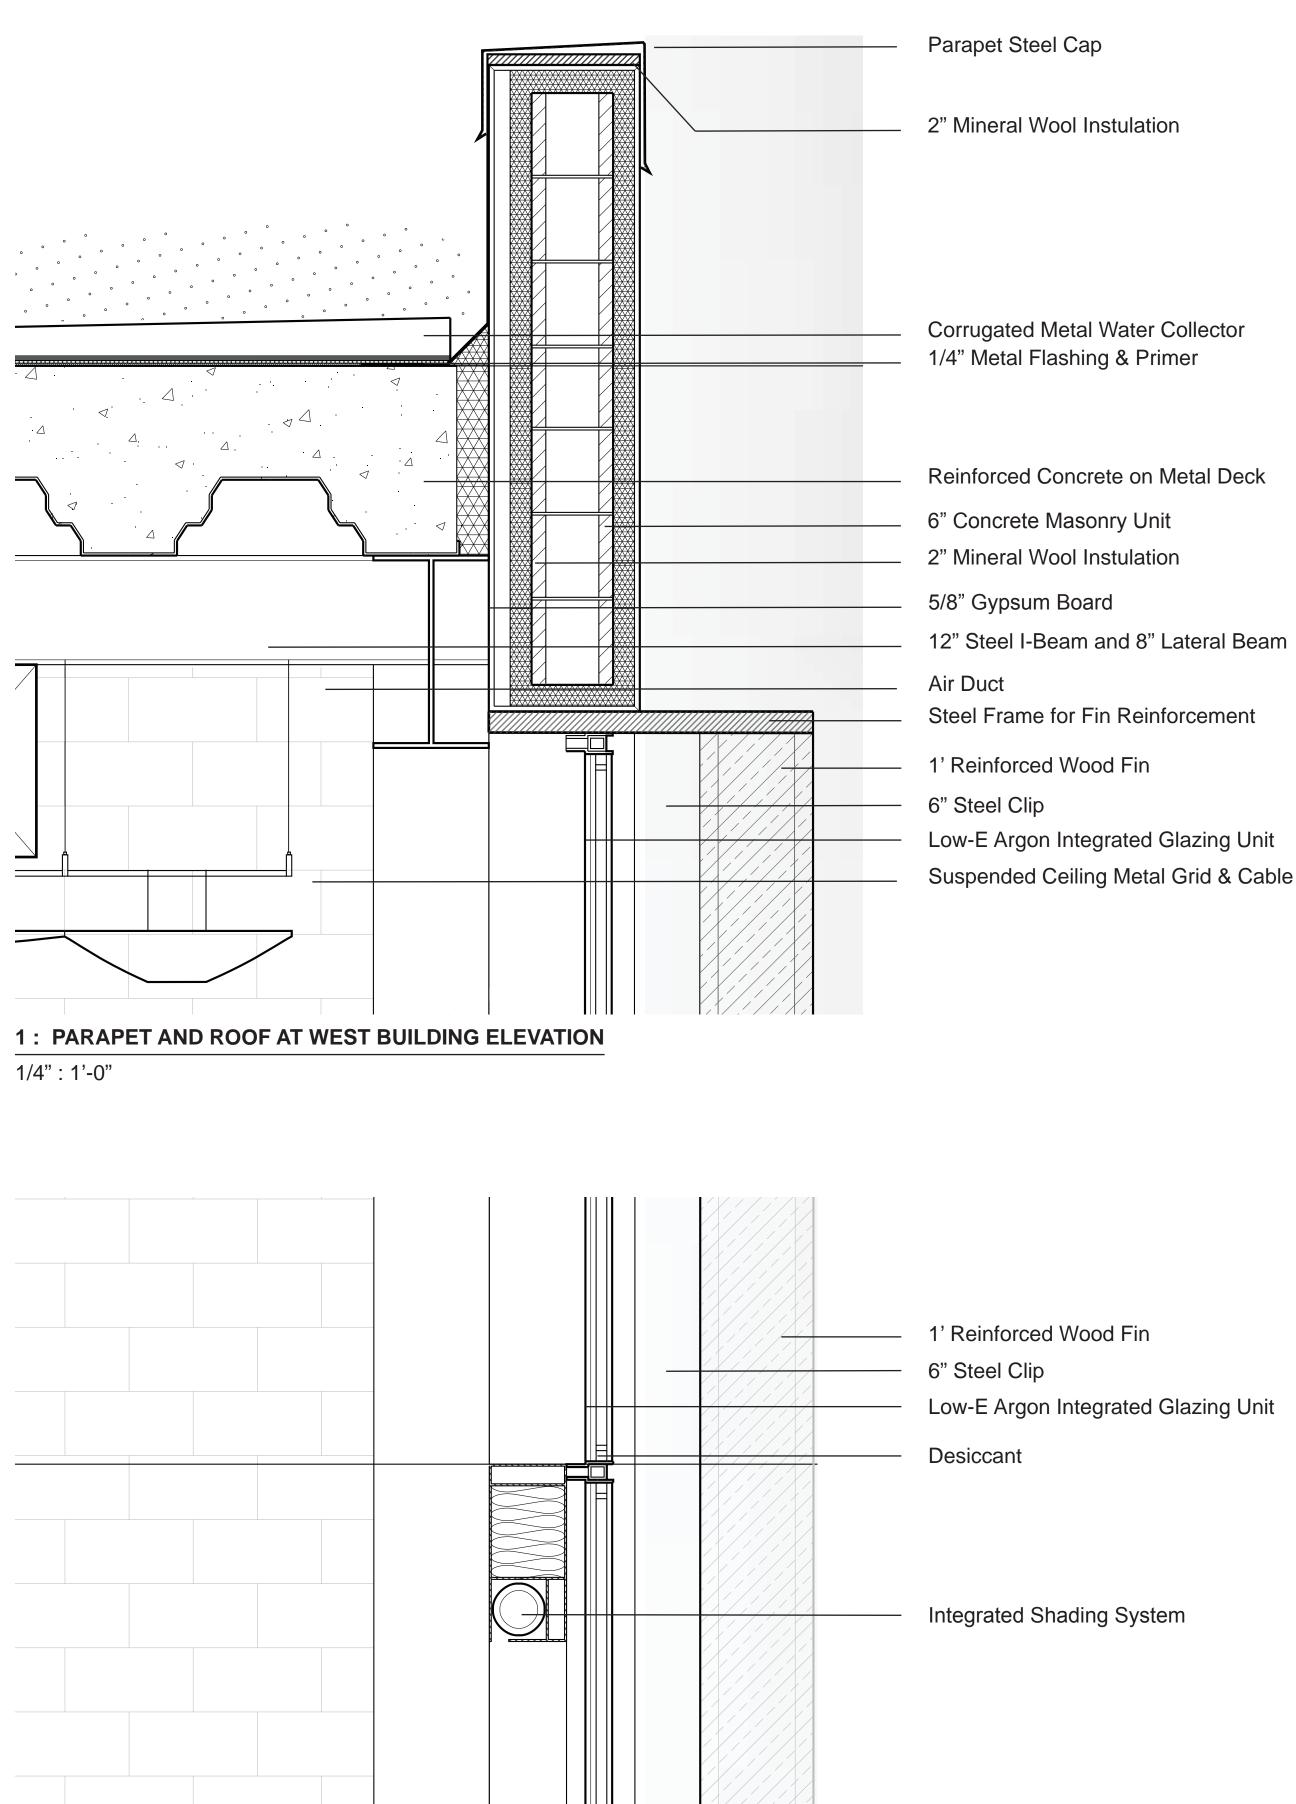


2: GLAZING AND SHADING SYSTEM AT WEST BUILDING ELEVATION 1/4":1'-0"

Reinforced Concrete on Metal Deck

Steel Frame for Fin Reinforcement

Low-E Argon Integrated Glazing Unit Suspended Ceiling Metal Grid & Cable

Low-E Argon Integrated Glazing Unit

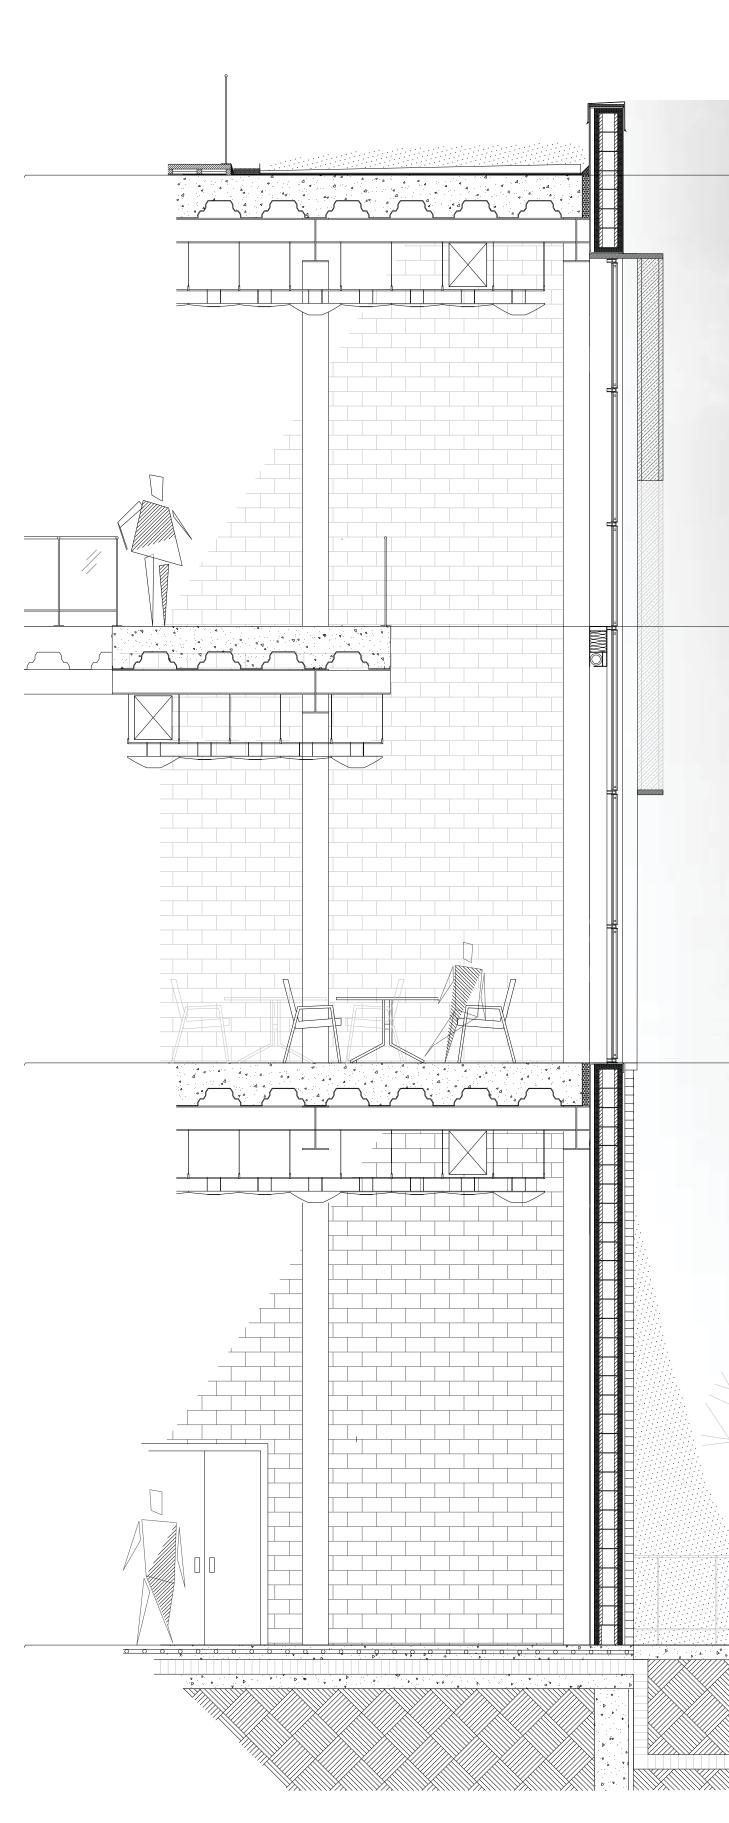

BUILDING SECTION, WEST ELEVATION



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DAVID MUSA - LUIS MIGUEL PIZANO - TIANYU YANG - REEM YASSIN

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STRUCTURAL AMY HARRINGTON PE Silman 32 Old Slip New York, NY 10005

MECHANICAL & SUSTAINABILITY JONCE WALKER LEED AP CSBA

Thornton Tomasetti, Inc. 51 Madison Ave New York, NY 10010

ENCLOSURE

KATHERINE CHAN Walter P Moore 180 Maiden Ln #803 New York, NY 10038

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> PROJECT Greenpoint Theater 18 Greenpoint Ave. Brooklyn, NY 11222

DRAWING TITLE Wall Details

DRAWING SCALE 1' - 0":1"


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ROOF, ELEV +54' - 0"


THIRD FLOOR, ELEV +39' - 0"

SECOND FLOOR, ELEV +24' - 0"



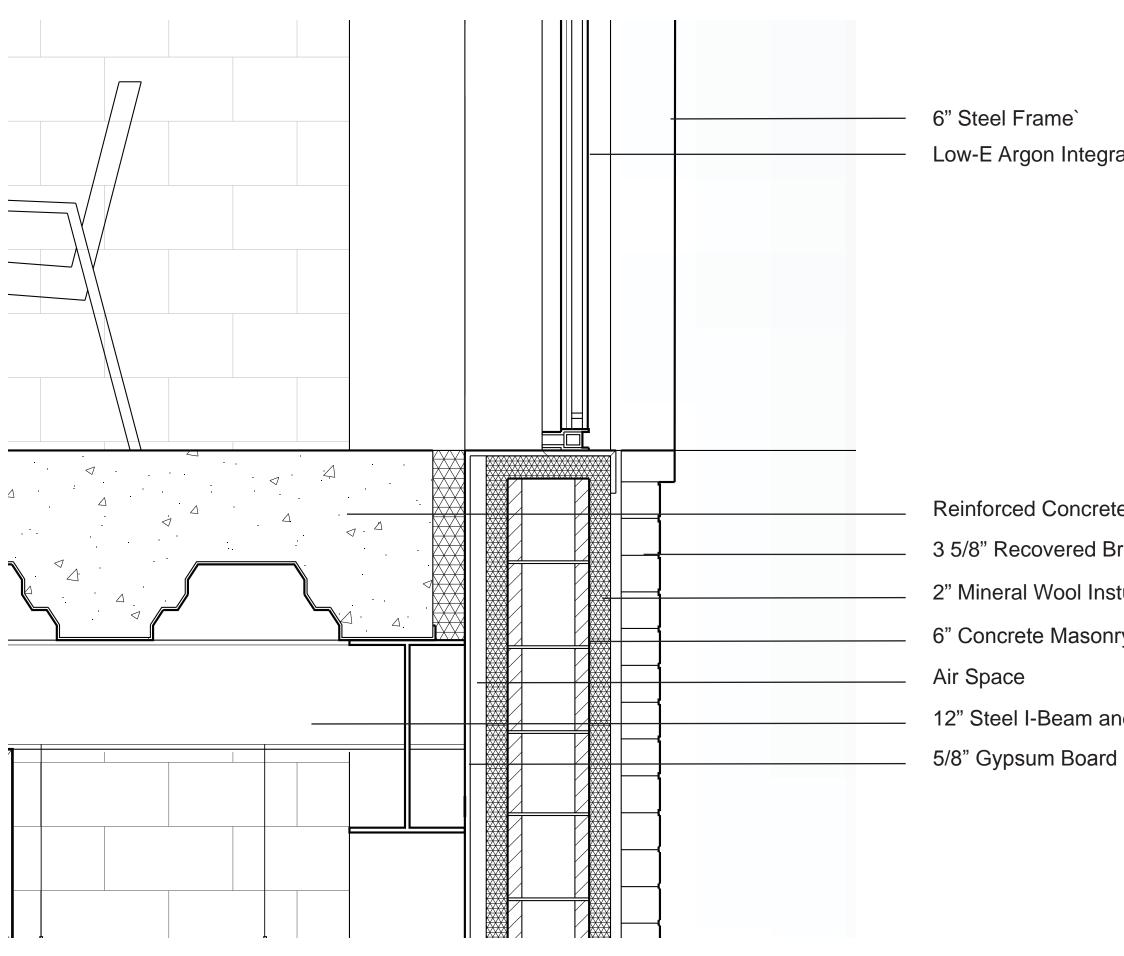

1: BRICK VENEER-CMU WALL AND SECOND FLOOR PLATE AT WEST BUILDING ELEVATION 1/4":1'-0"

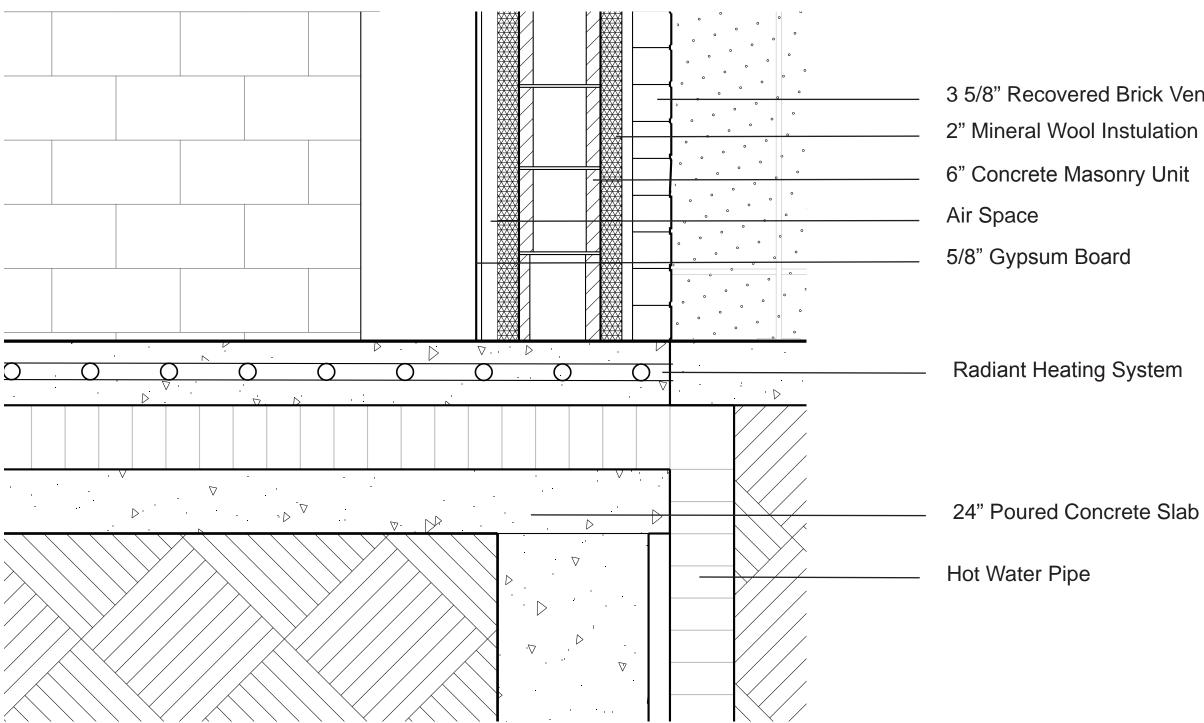

2: BRICK VENEER-CMU WALL AND GROUND FLOOR PLATE AT WEST BUILDING ELEVATION 1/4":1'-0"

Low-E Argon Integrated Glazing Unit


Reinforced Concrete Poured on Metal Deck

- 3 5/8" Recovered Brick Veneer
- 2" Mineral Wool Instulation
- 6" Concrete Masonry Unit

12" Steel I-Beam and 8" Lateral Beam

3 5/8" Recovered Brick Veneer 2" Mineral Wool Instulation

Radiant Heating System

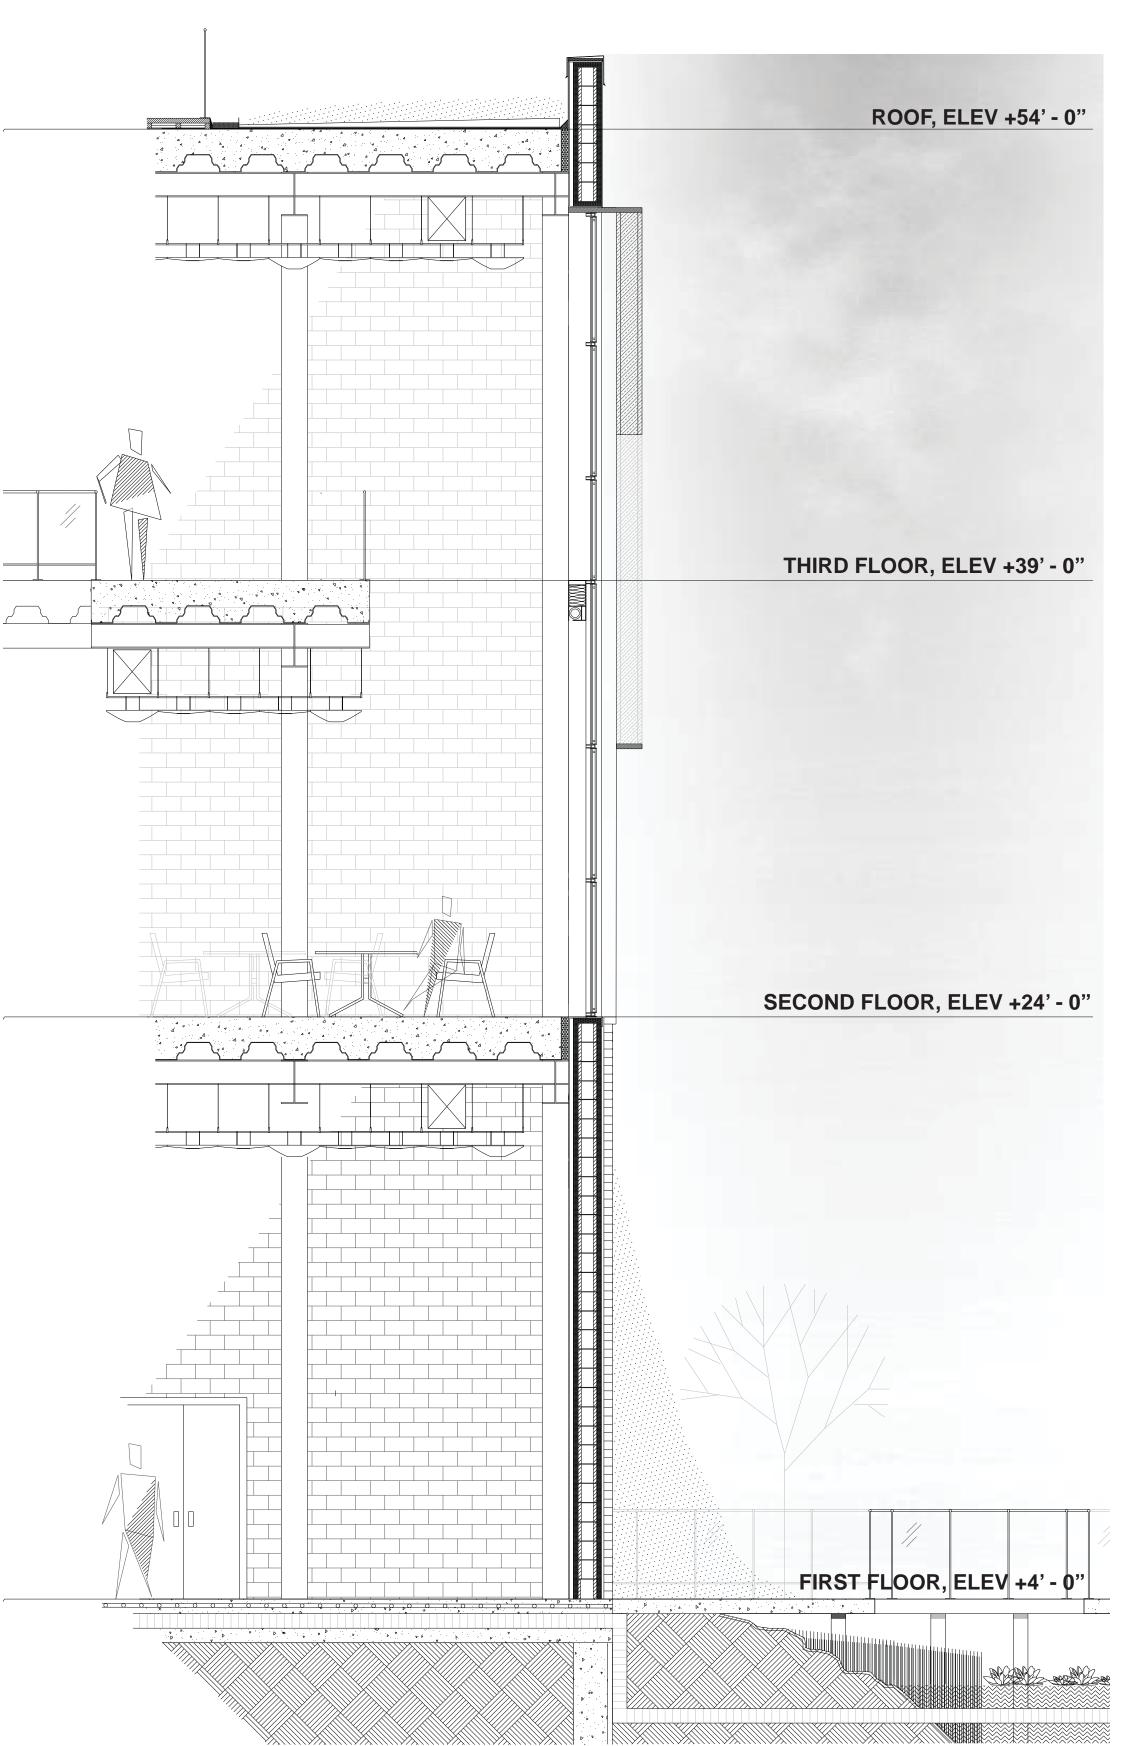

BUILDING SECTION, WEST ELEVATION



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ADDRESS

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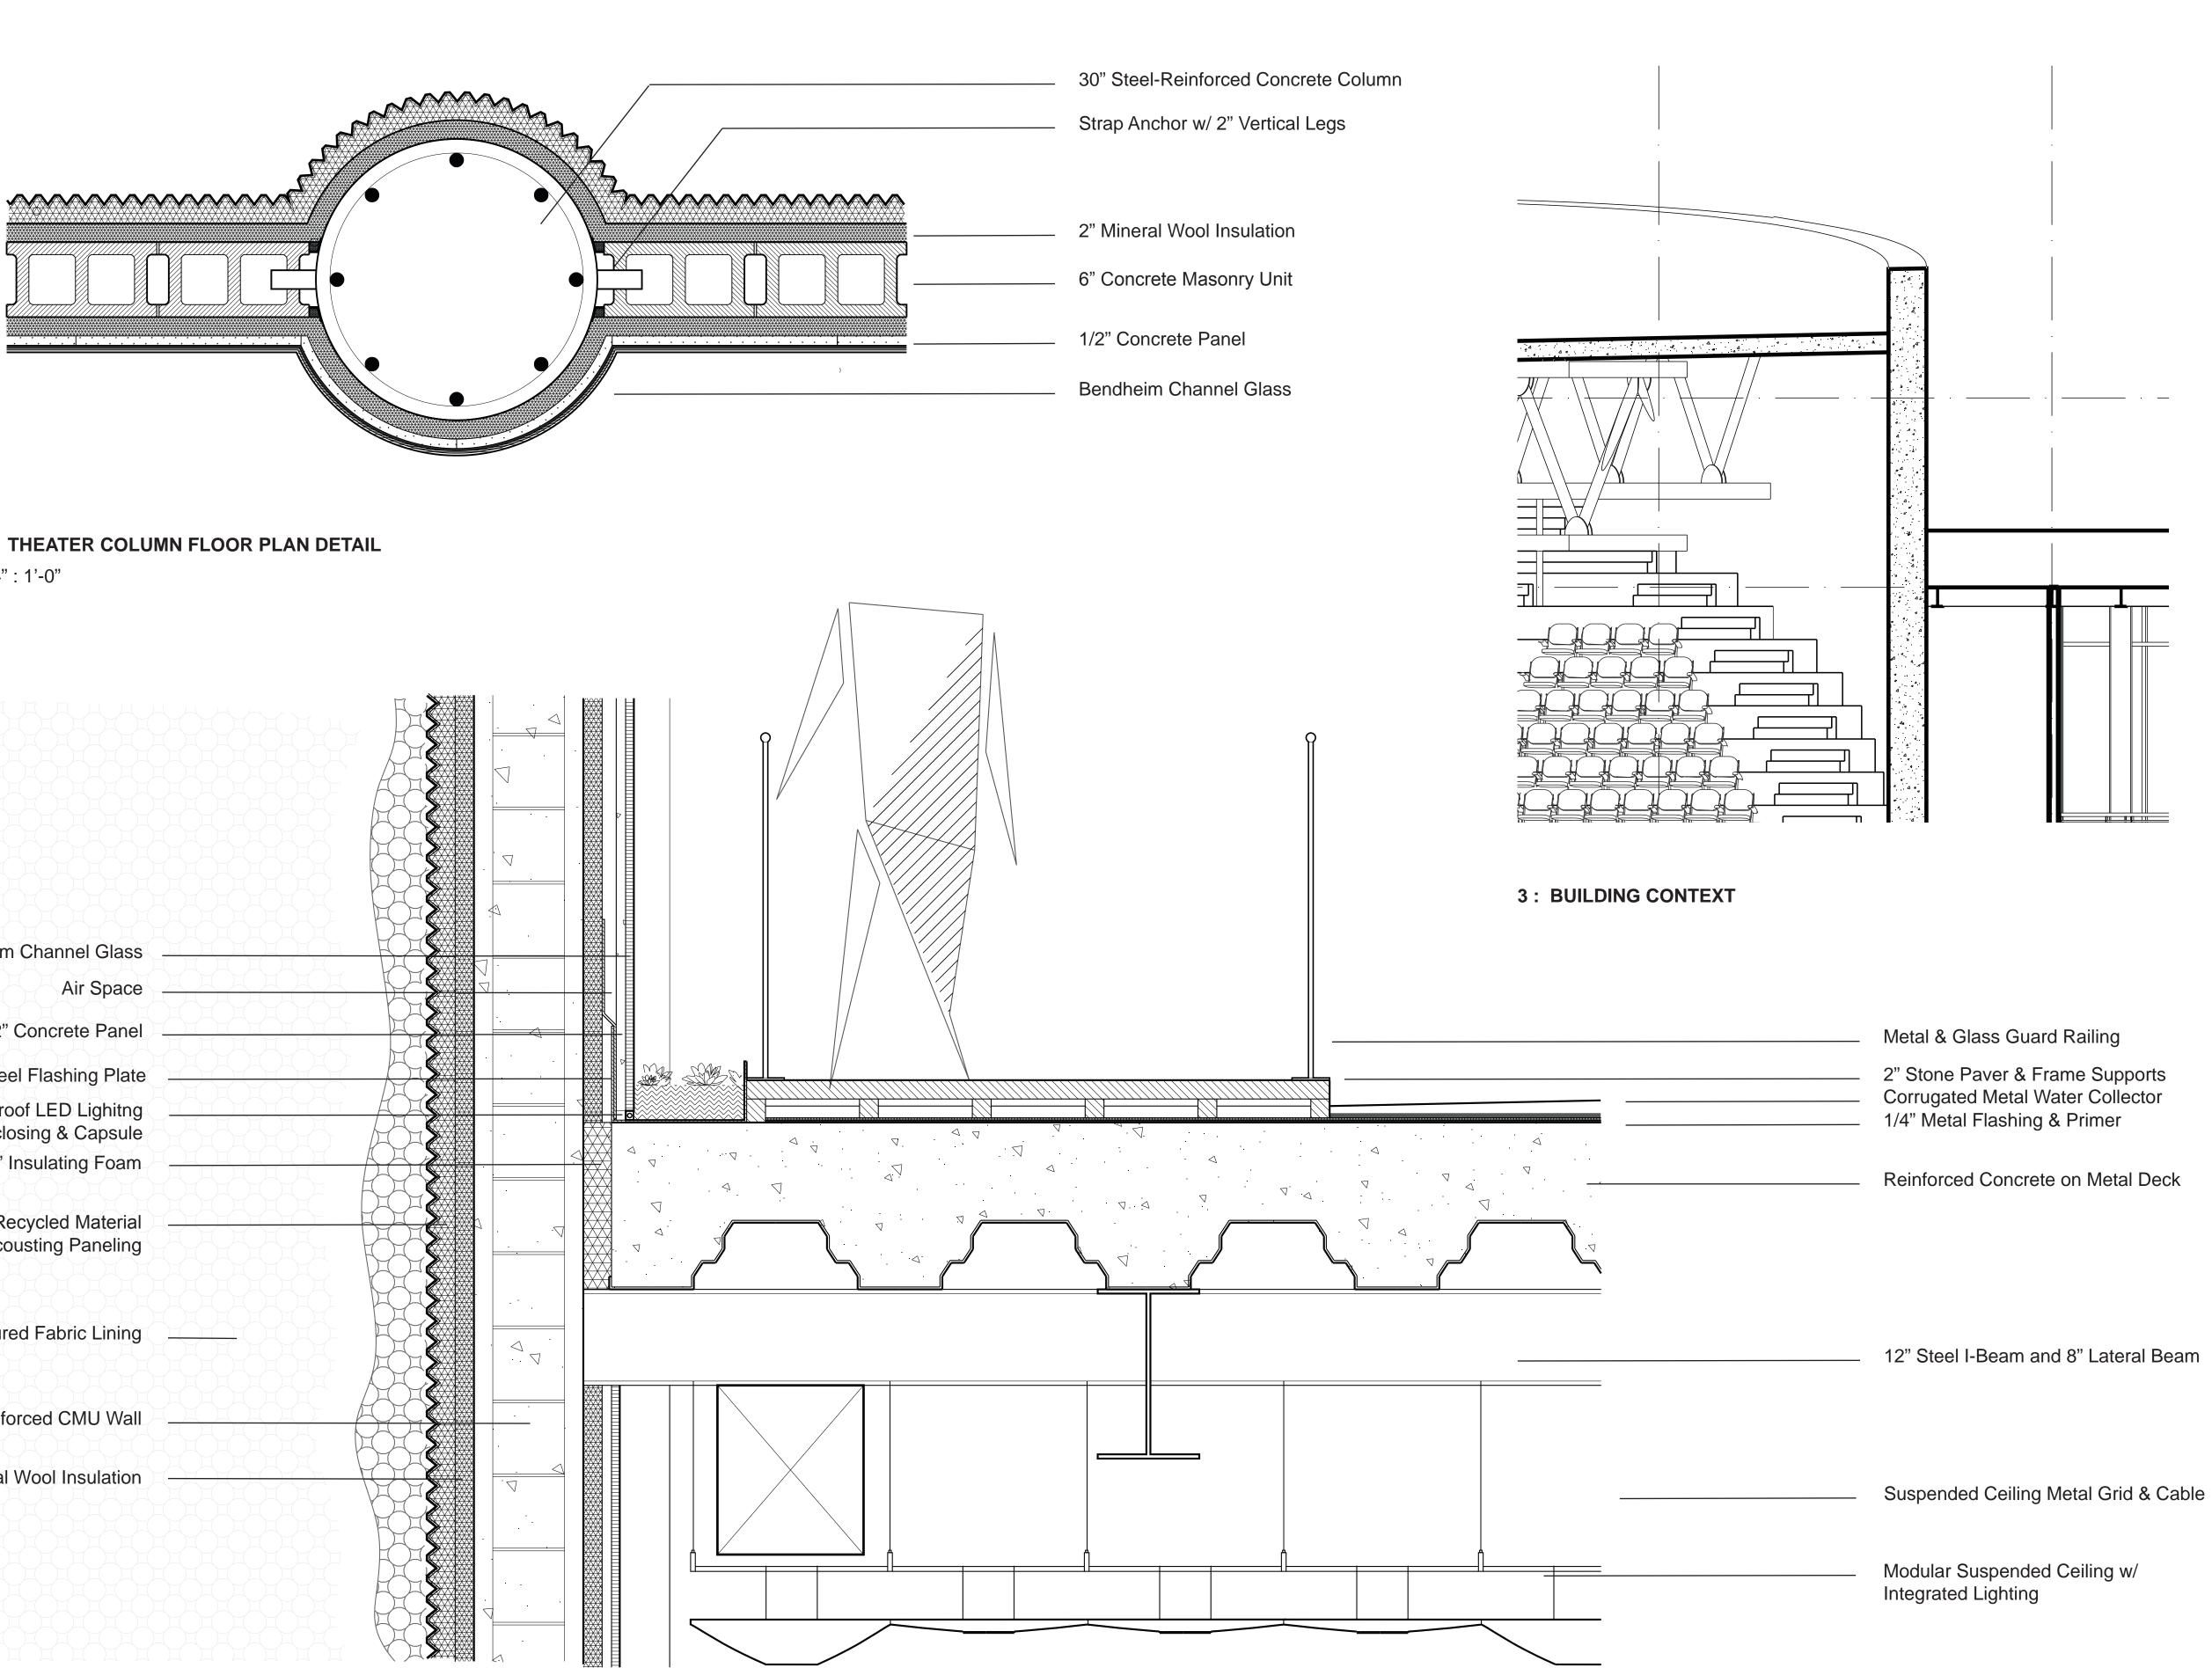
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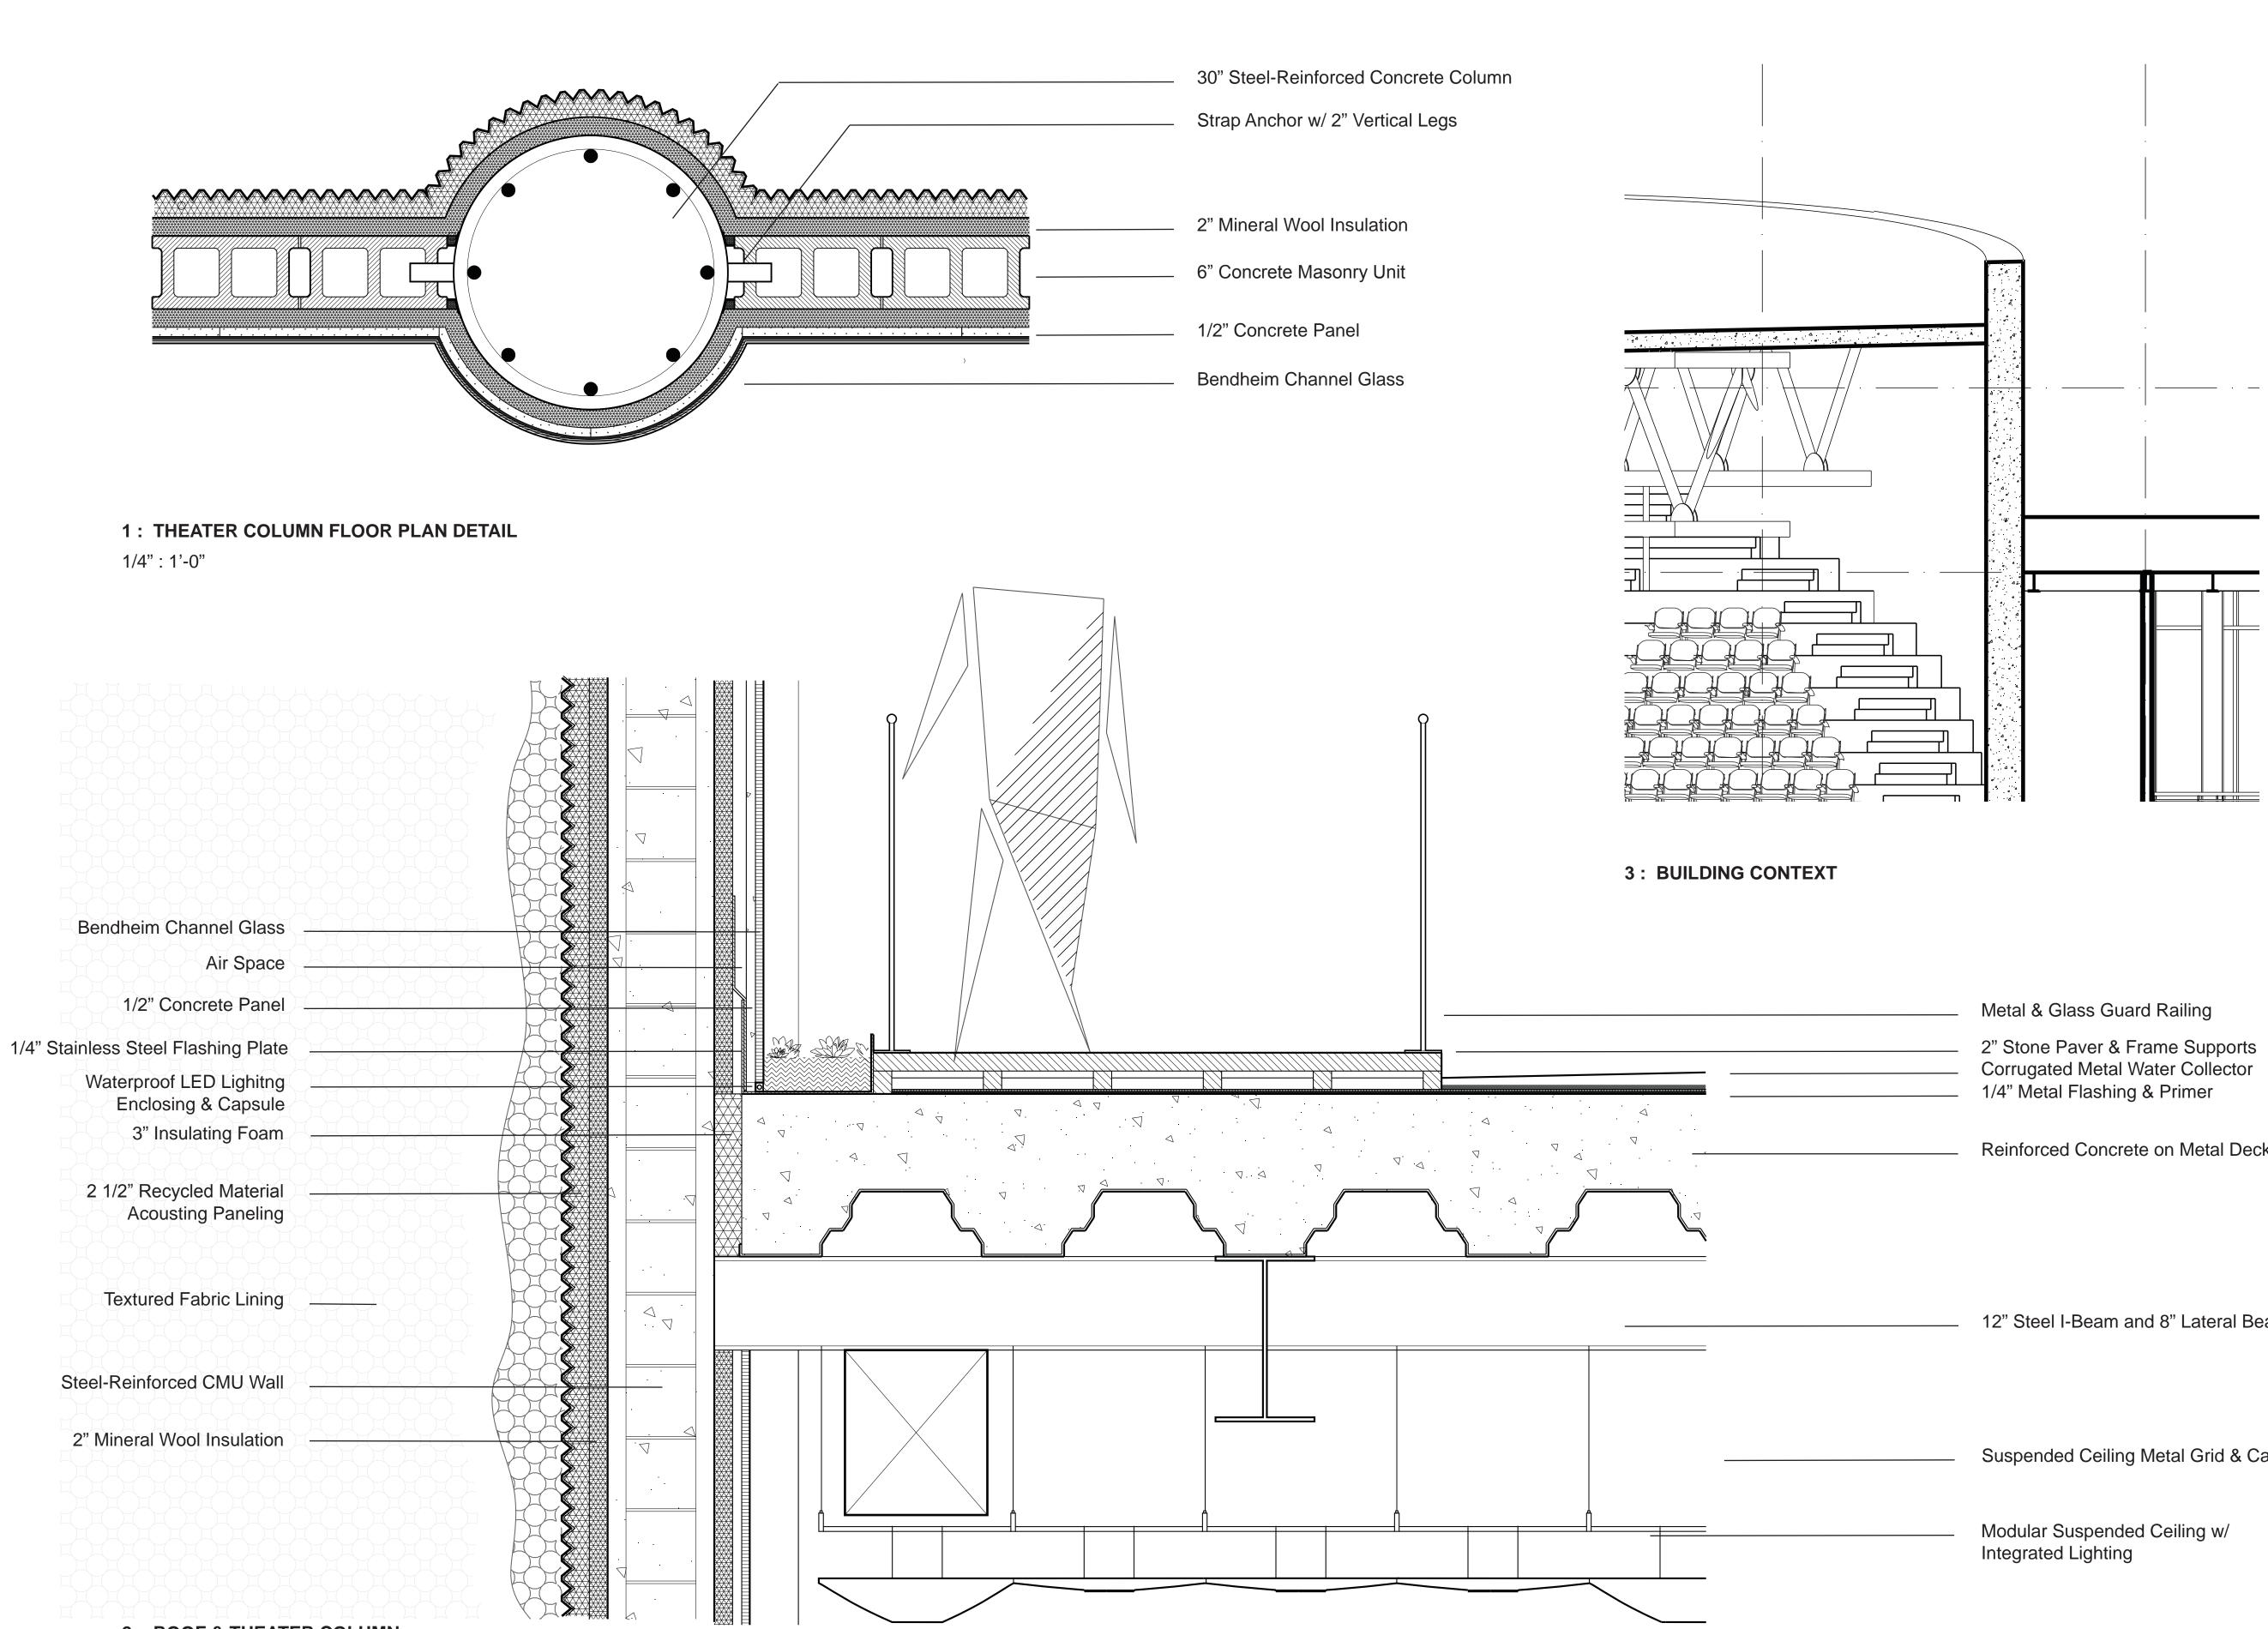
> PROJECT Greenpoint Theater 18 Greenpoint Ave. Brooklyn, NY 11222

DRAWING TITLE Wall Details

DRAWING SCALE 1' - 0":1"

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2: ROOF & THEATER COLUMN 1/4":1'-0"

12" Steel I-Beam and 8" Lateral Beam



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MECHANICAL & SUSTAINABILITY JONCE WALKER LEED AP CSBA

Thornton Tomasetti, Inc. 51 Madison Ave New York, NY 10010

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180 Maiden Ln #803 New York, NY 10038

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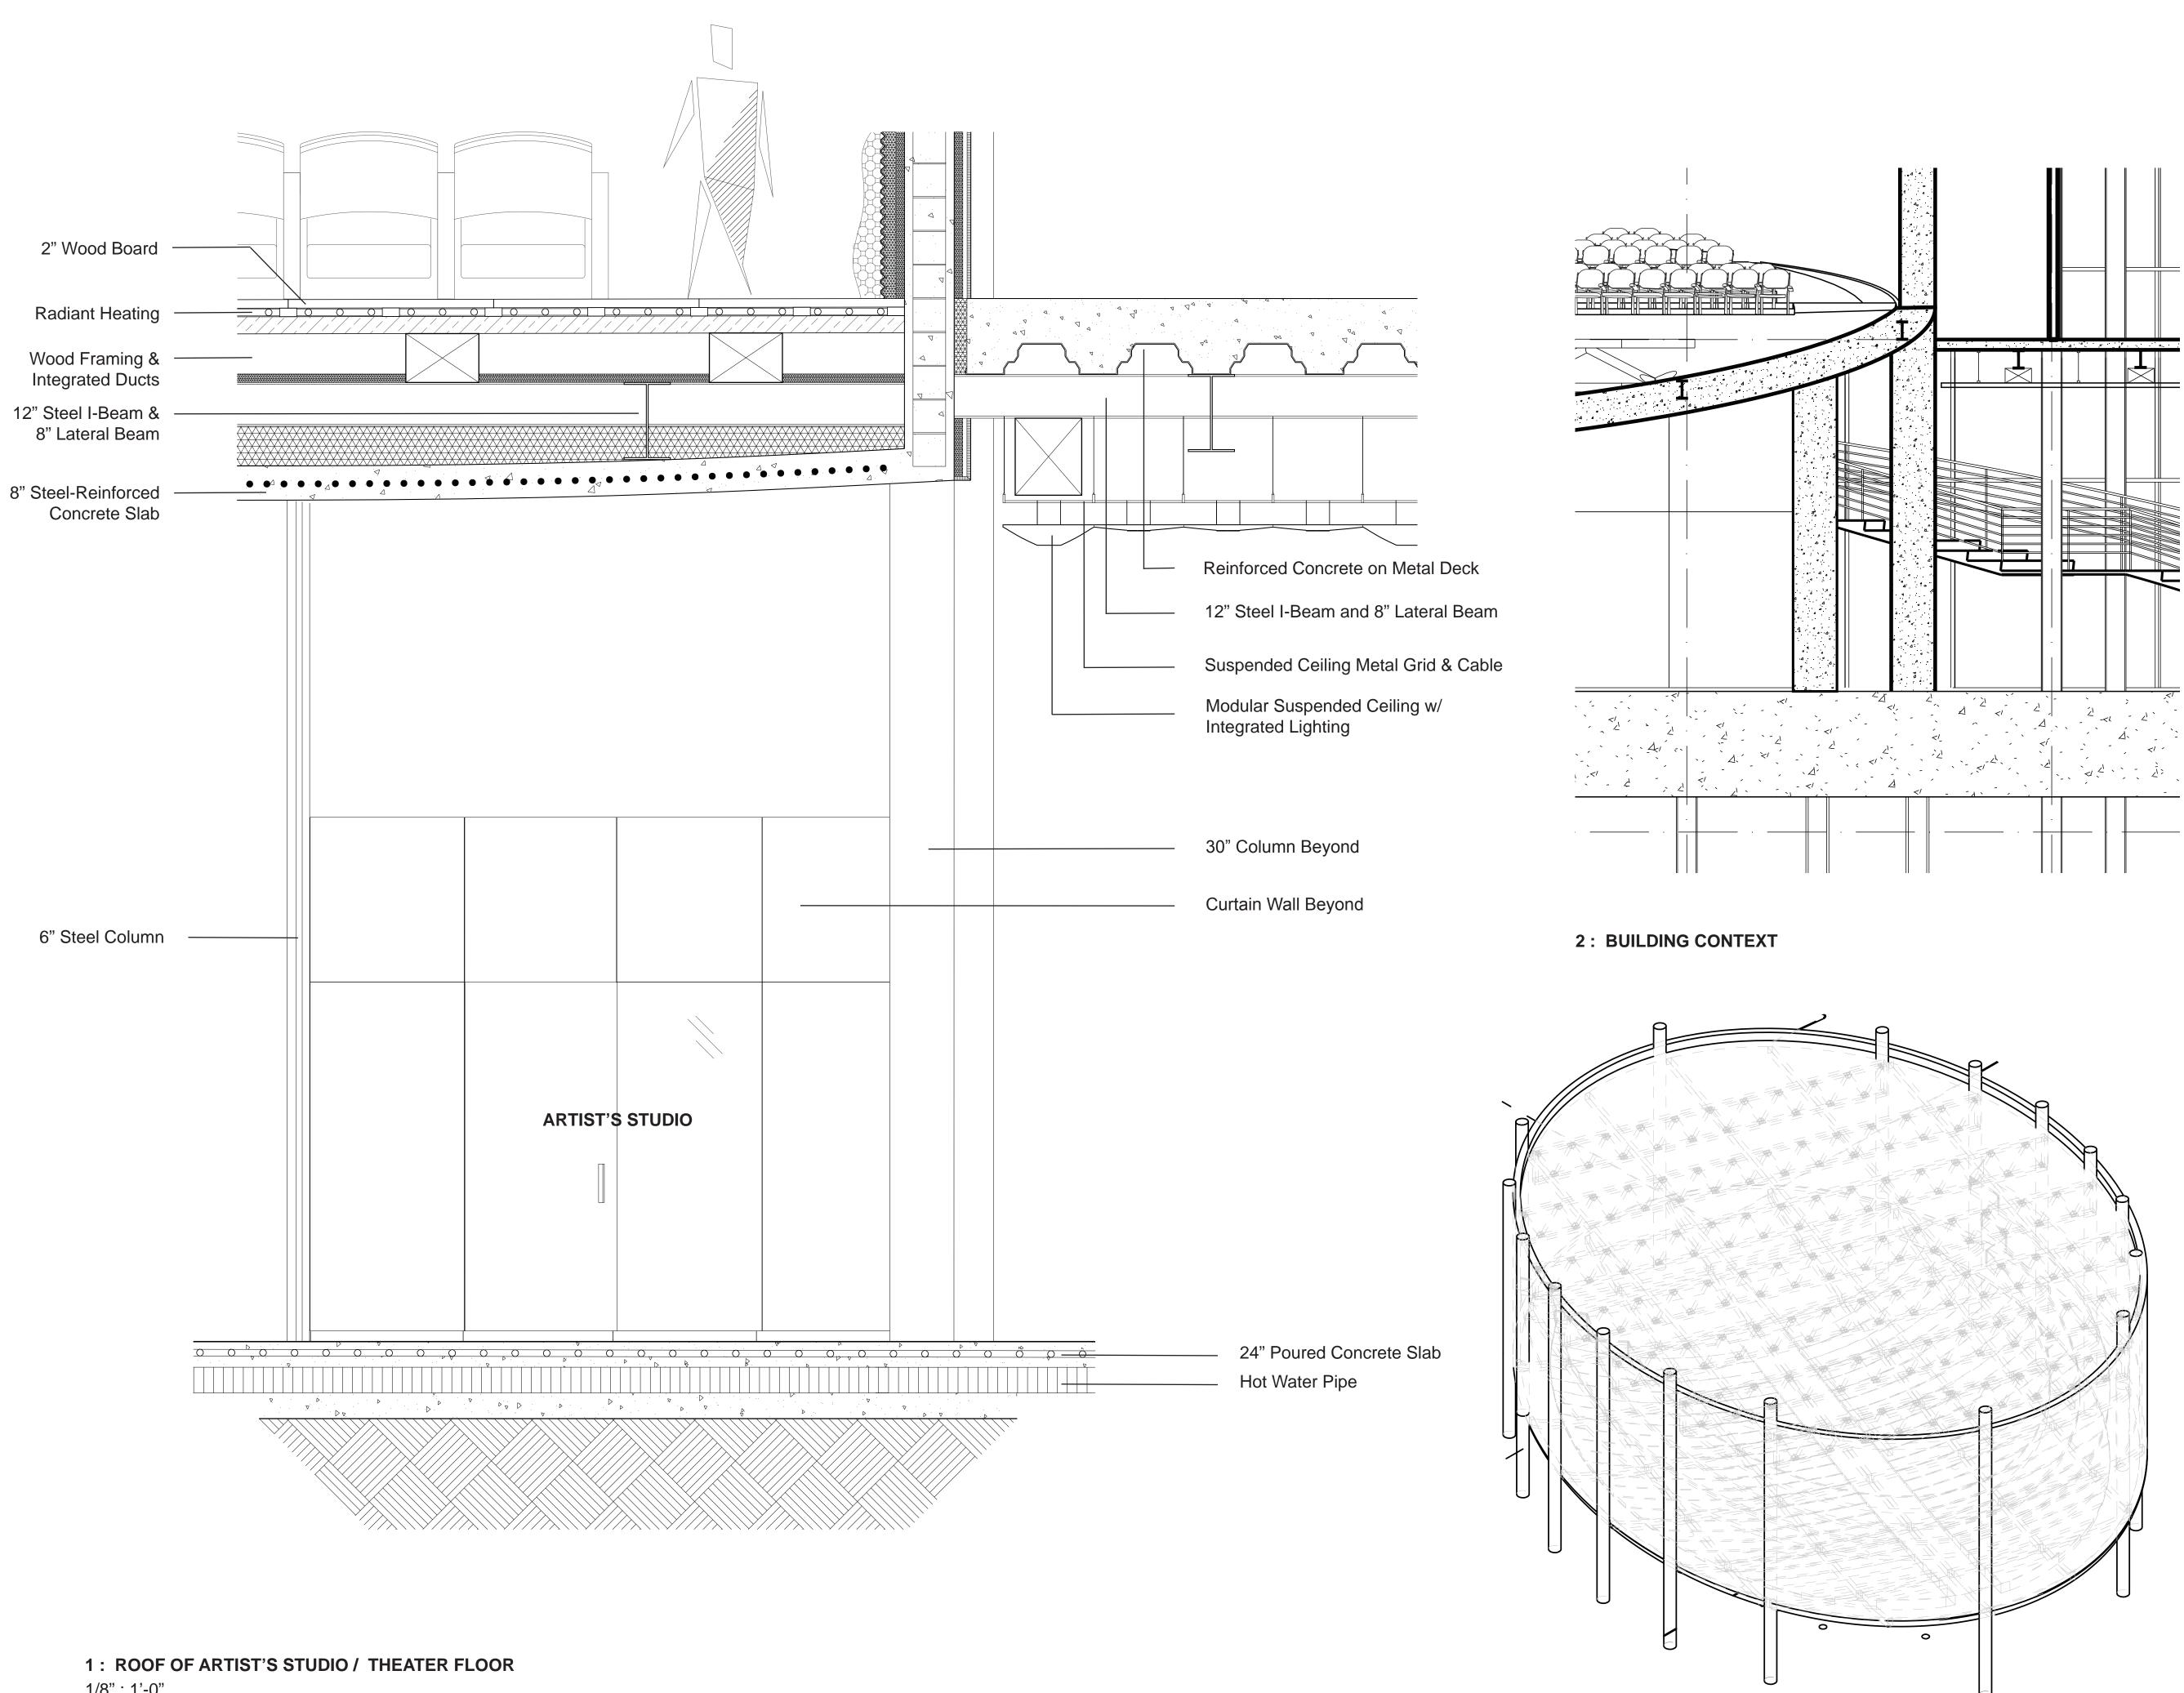
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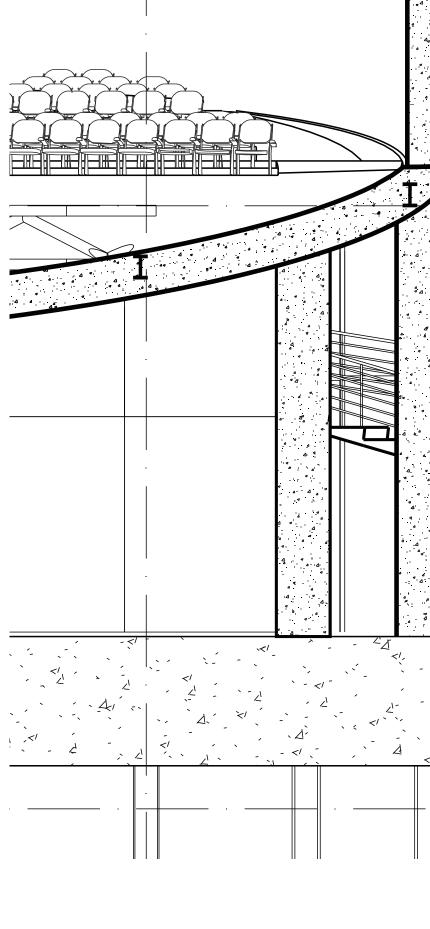
DRAWING TITLE Wall Details

DRAWING SCALE 1' - 0":1"

S



1/8":1'-0"







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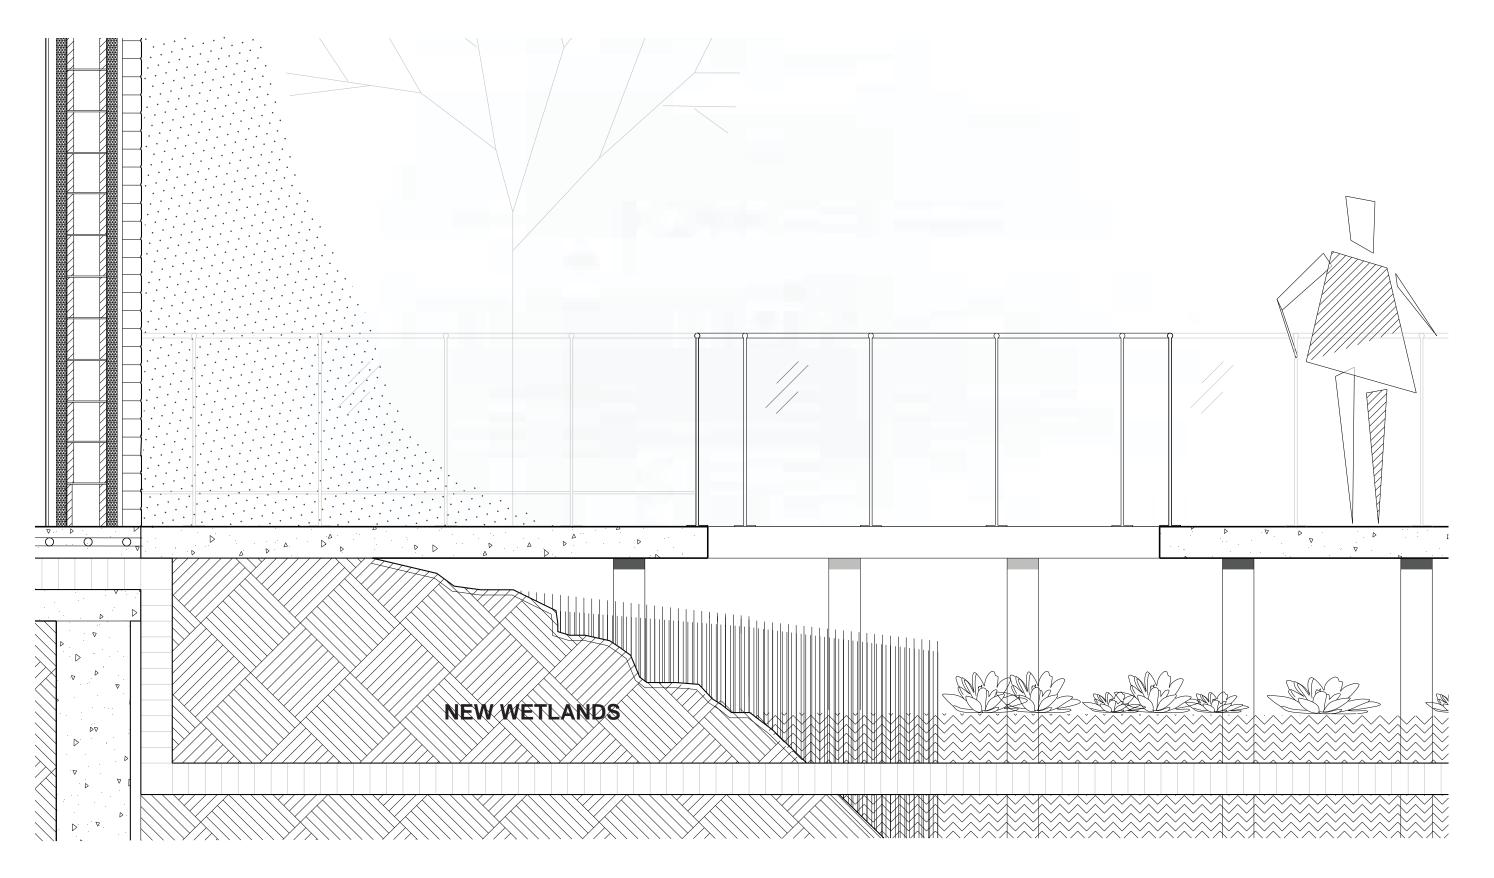
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> PROJECT Greenpoint Theater 18 Greenpoint Ave. Brooklyn, NY 11222

DRAWING TITLE Wall Details


DRAWING SCALE 1' - 0":1"

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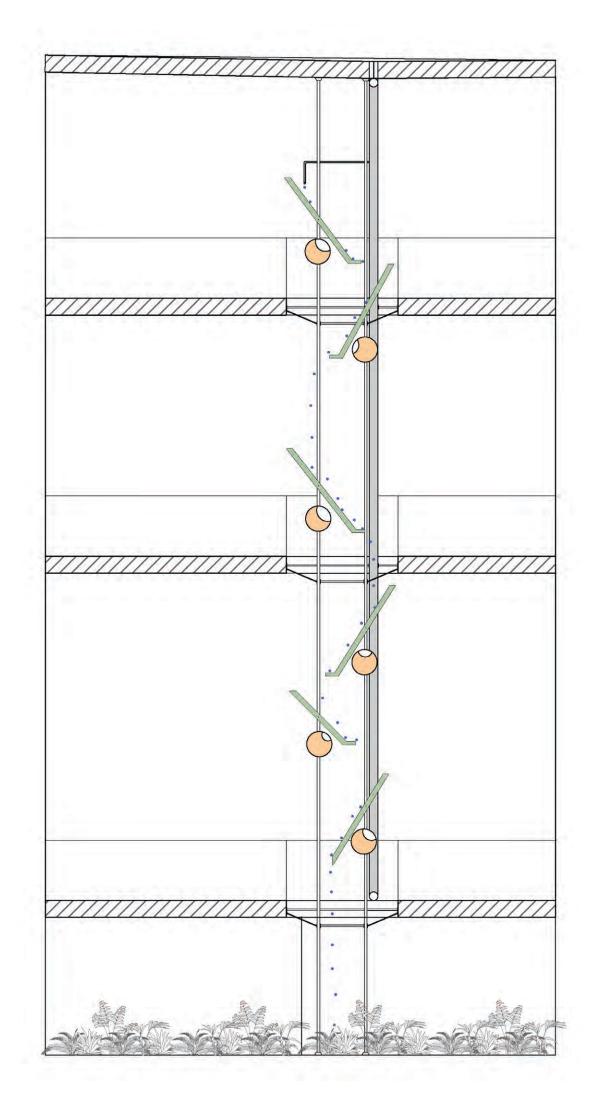
1 : WATERFRONT PIER & WATER FEATURE

1/4":1'-0"




2: THEATER COLUMN FLOOR PLAN DETAIL

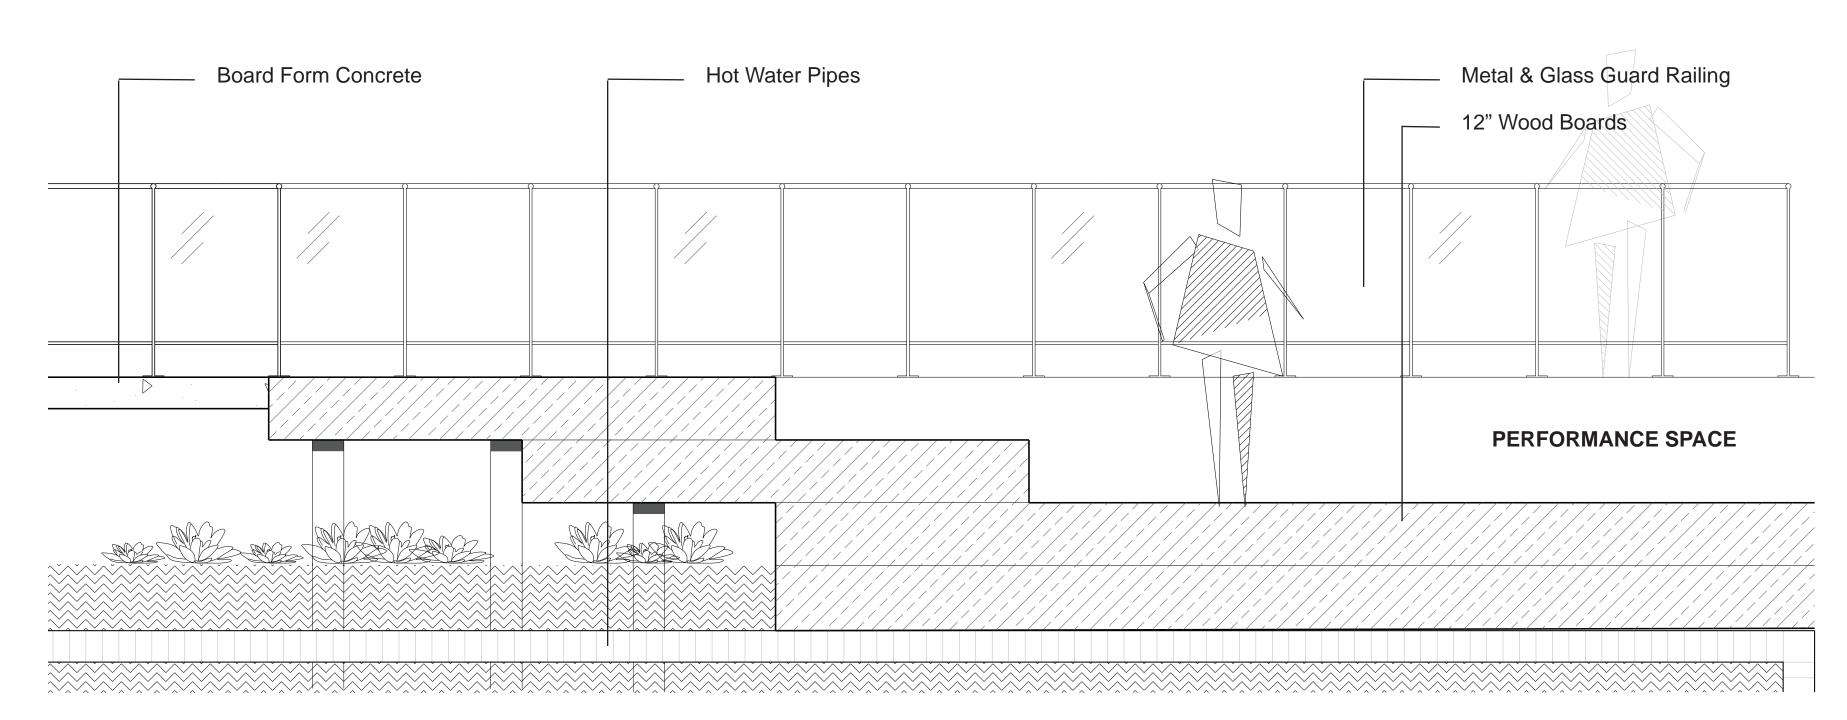1/4":1'-0"





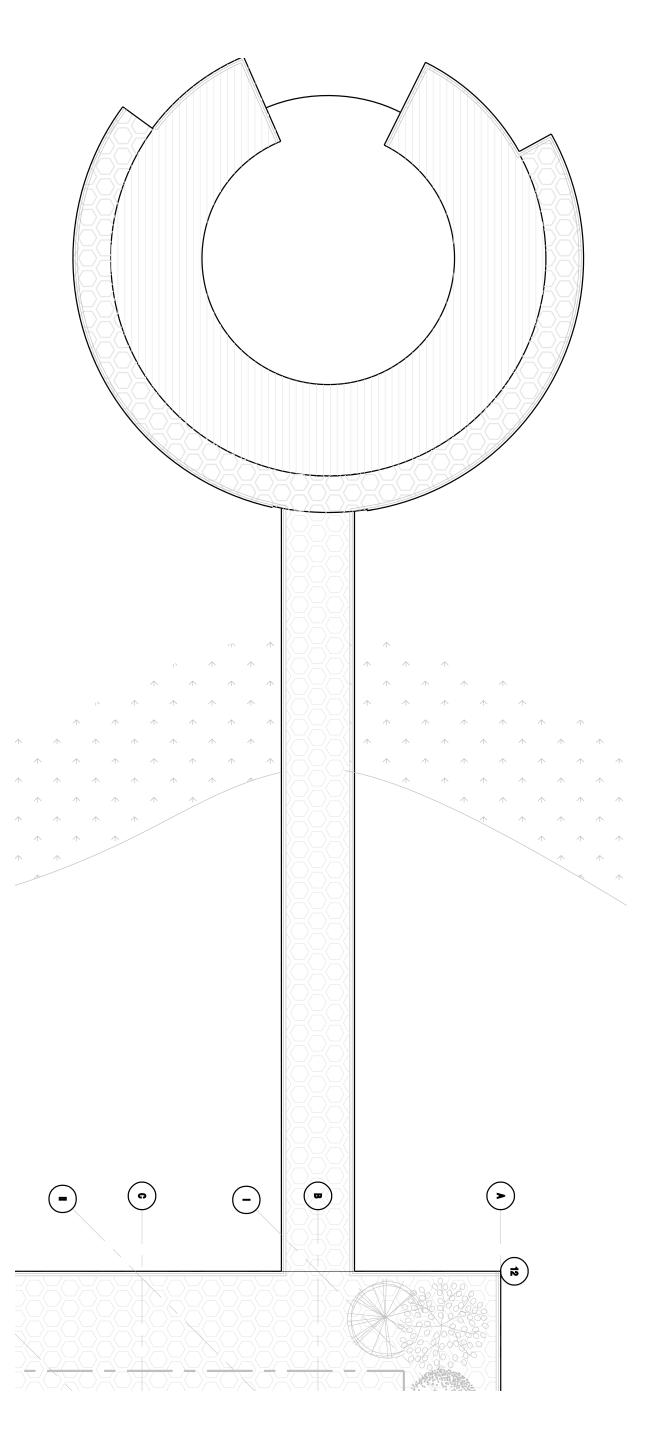

4: BUILDING CONTEXT



THE **CEILING-TO-FLOOR DESIGN GROUP**

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STRUCTURAL AMY HARRINGTON PE Silman 32 Old Slip New York, NY 10005

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Thornton Tomasetti, Inc. 51 Madison Ave New York, NY 10010

ENCLOSURE

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> PROJECT Greenpoint Theater 18 Greenpoint Ave. Brooklyn, NY 11222

DRAWING TITLE Wall Details

DRAWING SCALE Various



EXTERIOR BUILDING PERSPECTIVE, JANUARY 2020



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ADDRESS

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ARCHITECTURE TECHNICAL CONSULTING

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> **PROJECT** Greenpoint Theater 18 Greenpoint Ave. Brooklyn, NY 11222

DRAWING TITLE Building Perspective Renderings

> DRAWING SCALE Various

A901










Bar / Lounge

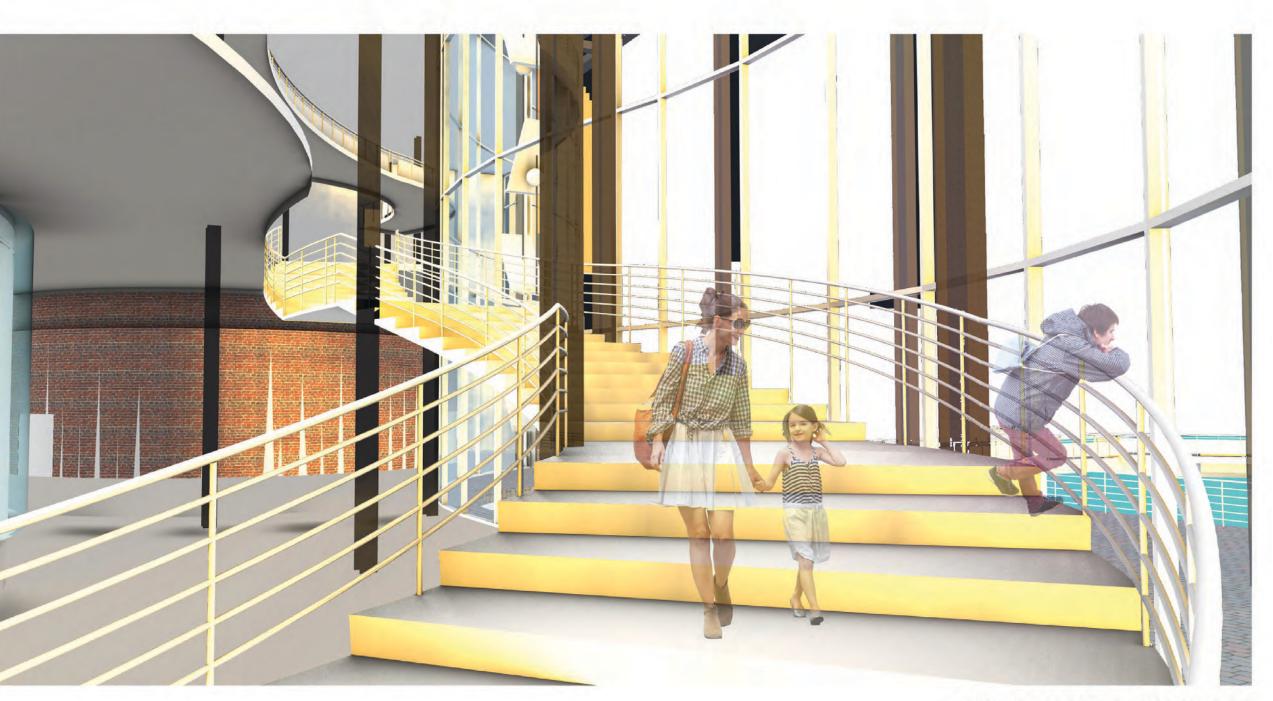

Roof Terrace

Performative Staircase



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MECHANICAL & SUSTAINABILITY

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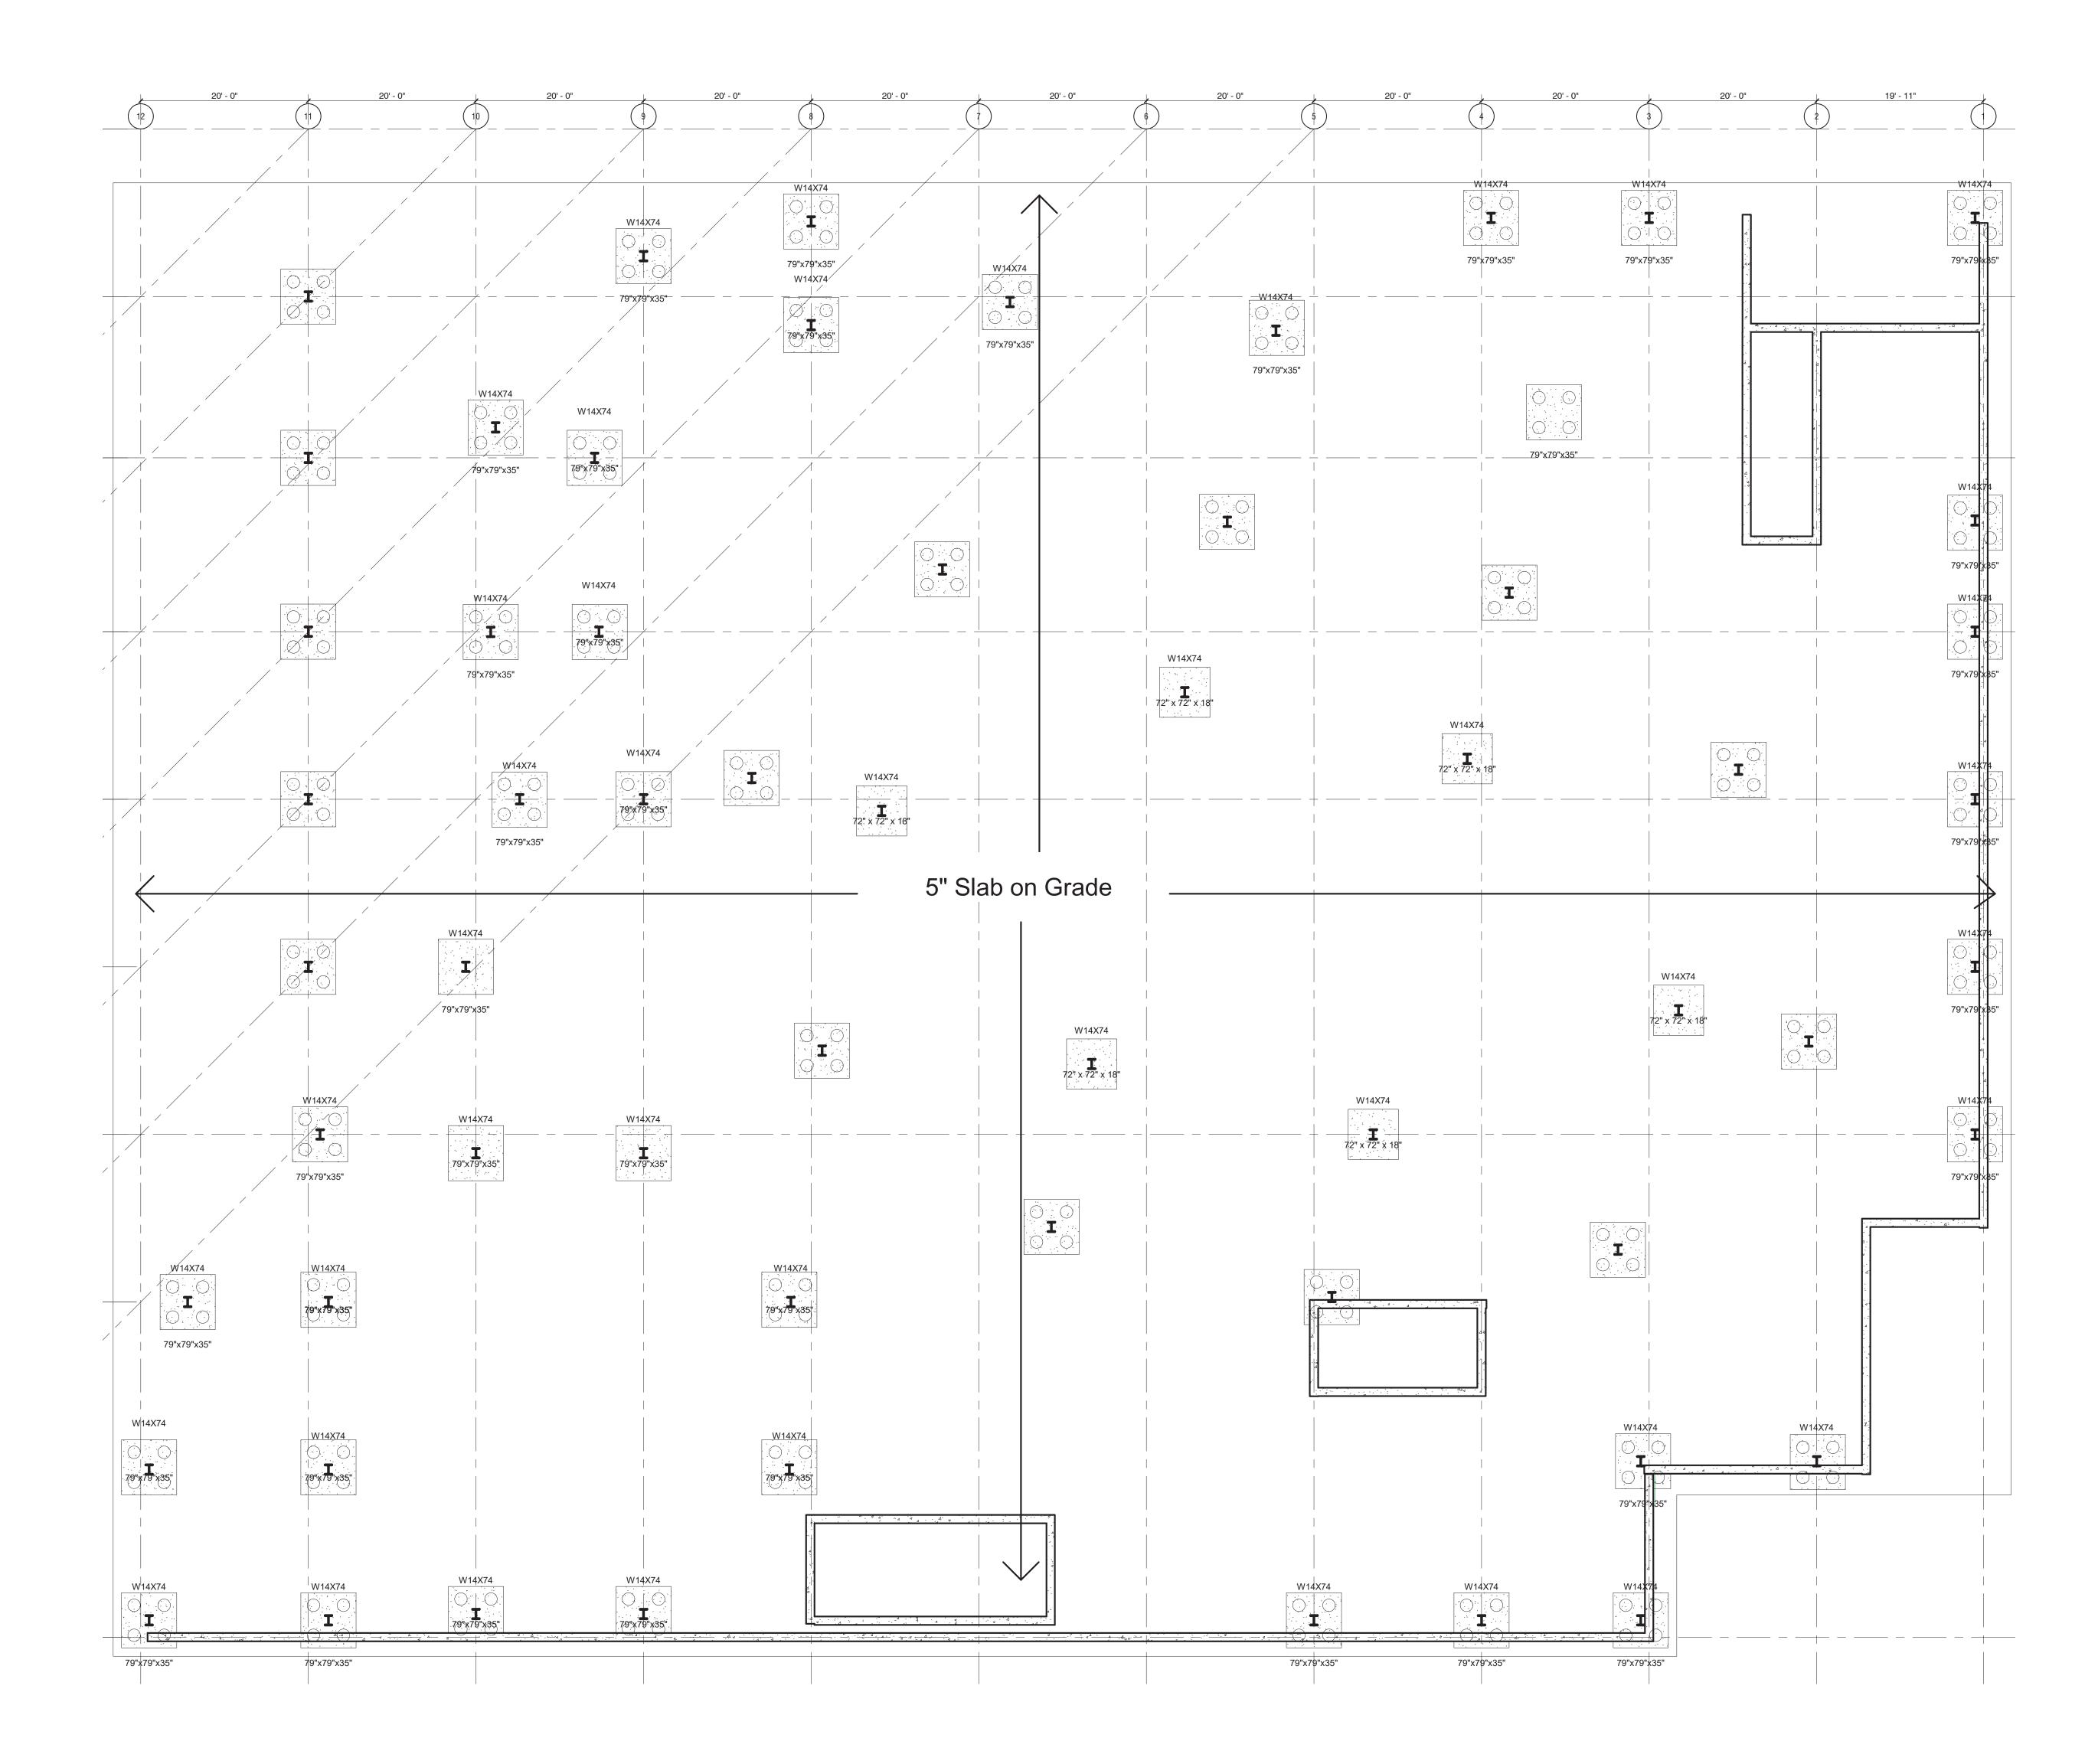
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PROJECT Greenpoint Theater 18 Greenpoint Ave. Brooklyn, NY 11222

DRAWING TITLE Building Perspective Renderings

> DRAWING SCALE Various

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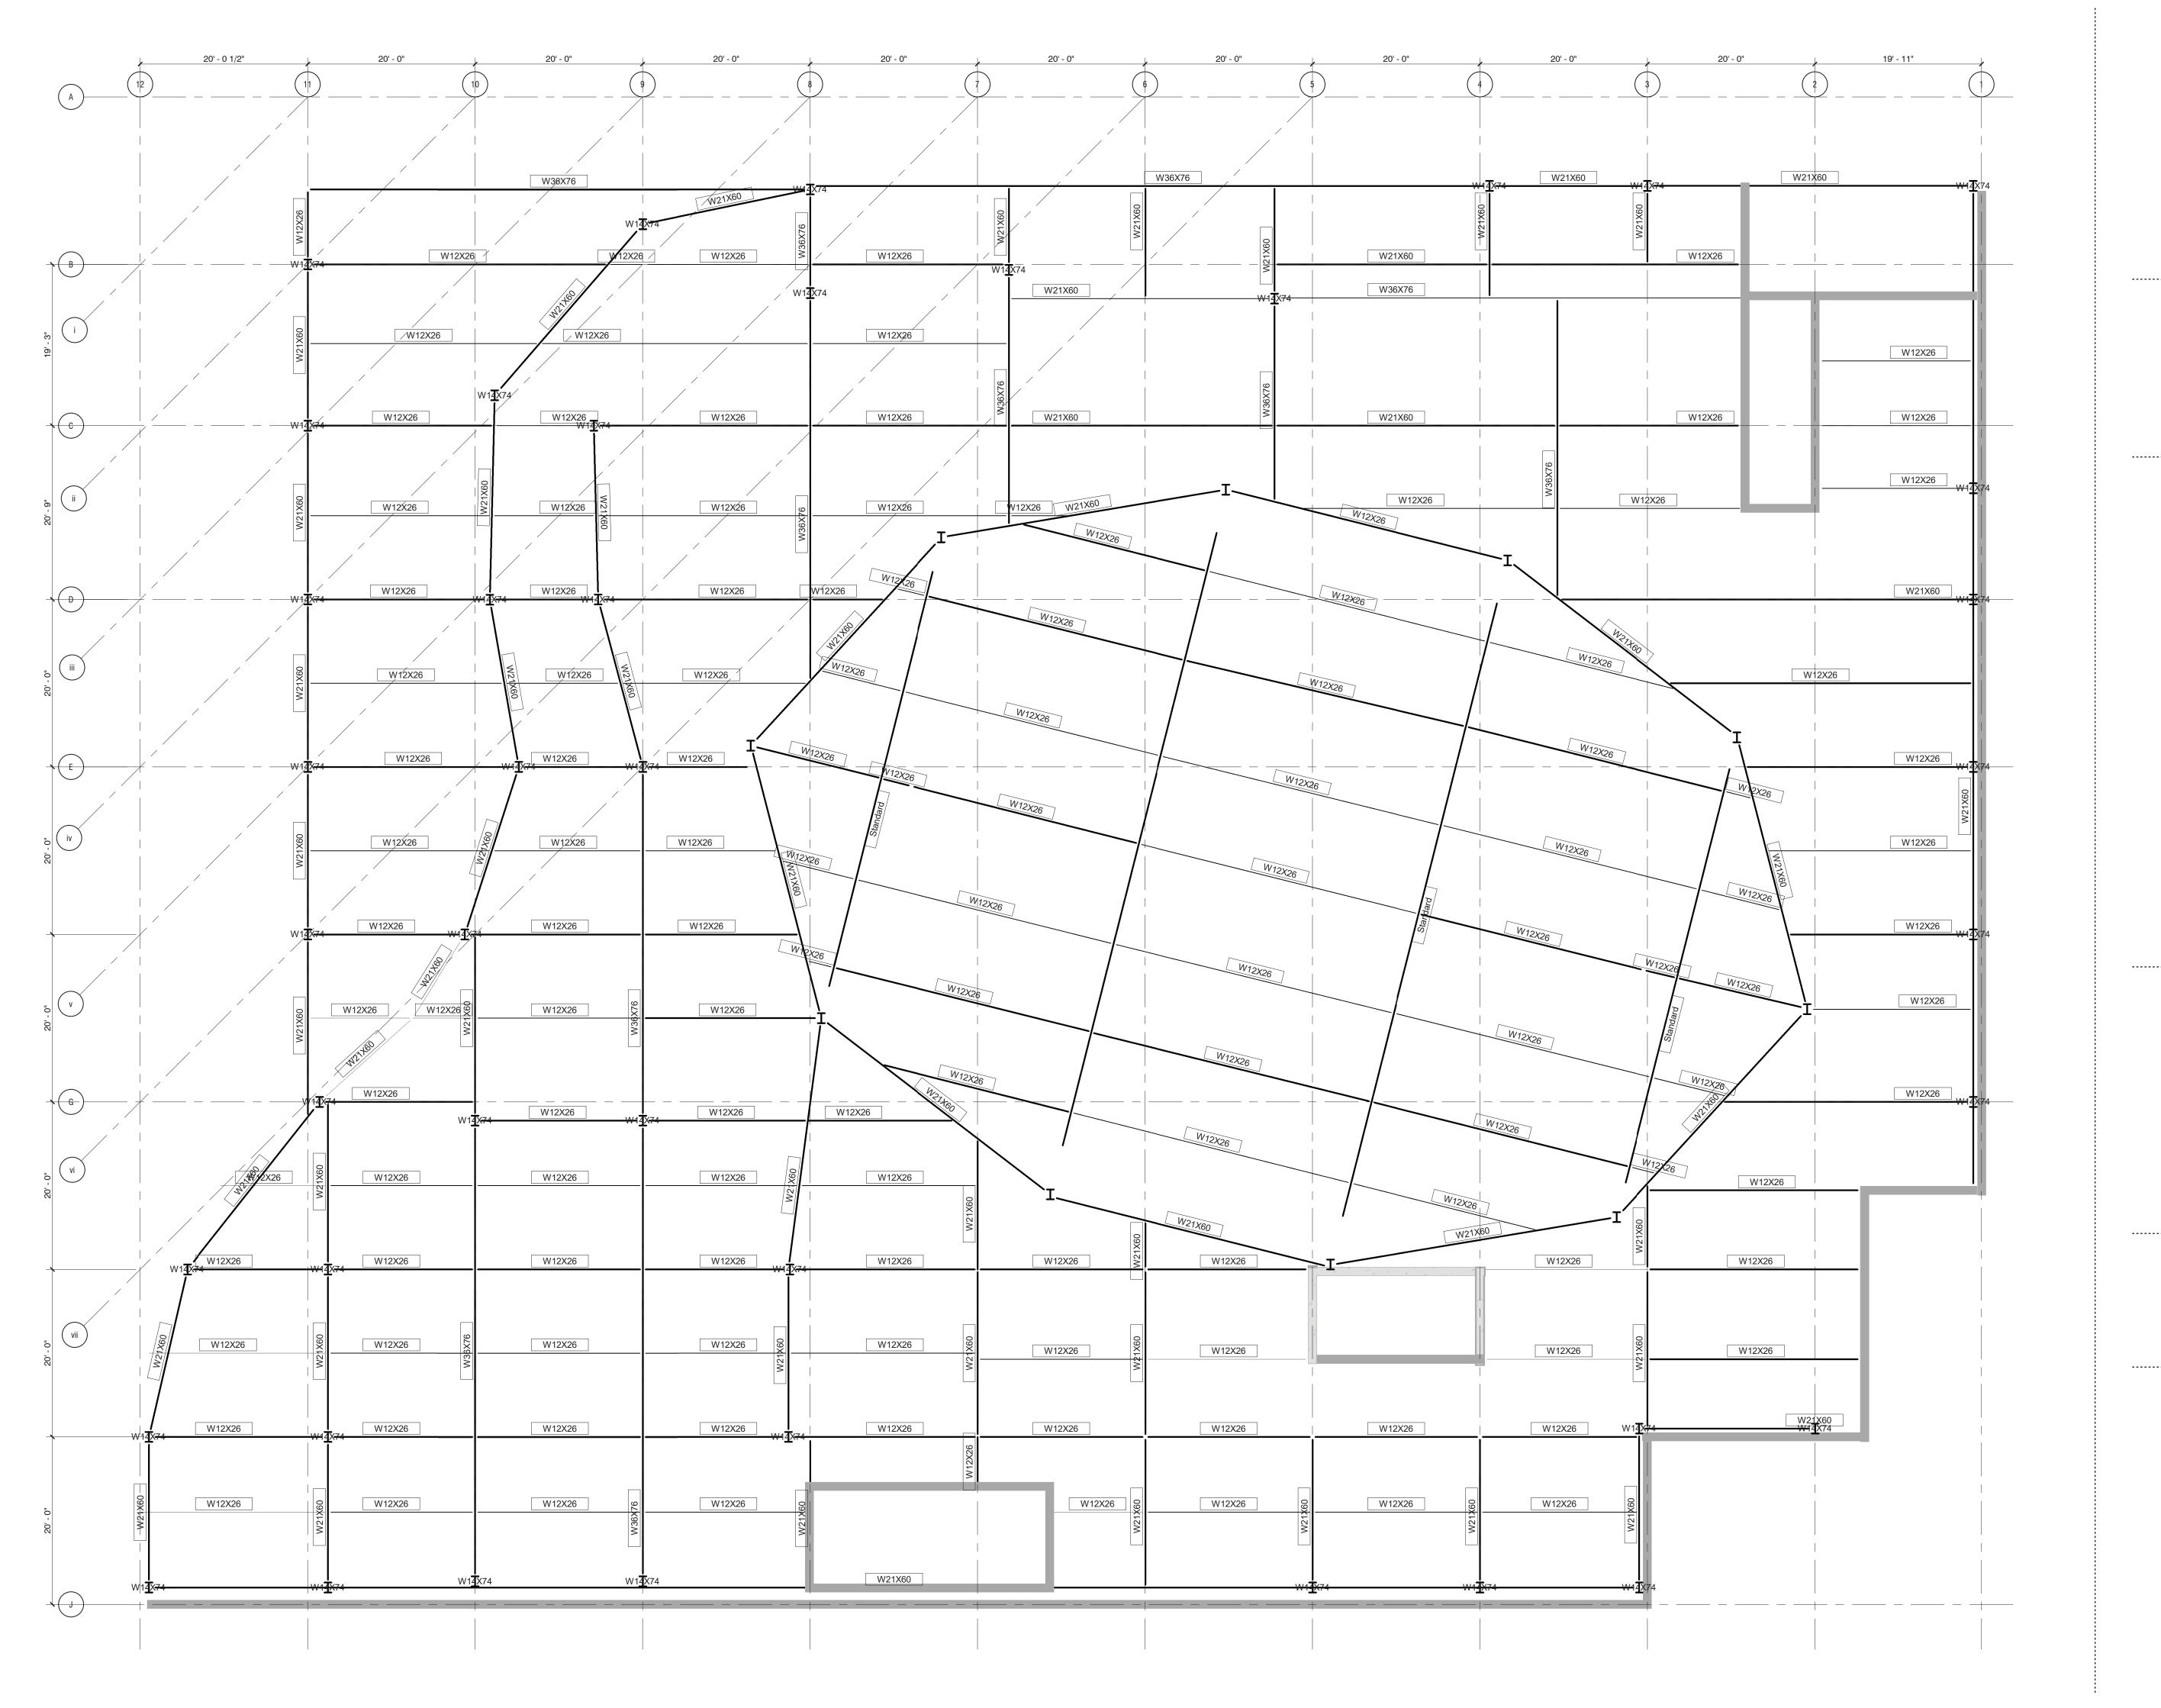
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PROJECT

Greenpoint Theater 18 Greenpoint Ave. Brooklyn, NY 11222

DRAWING TITLE Foundation Plan

DRAWING SCALE 1/8": 1'-0" S101



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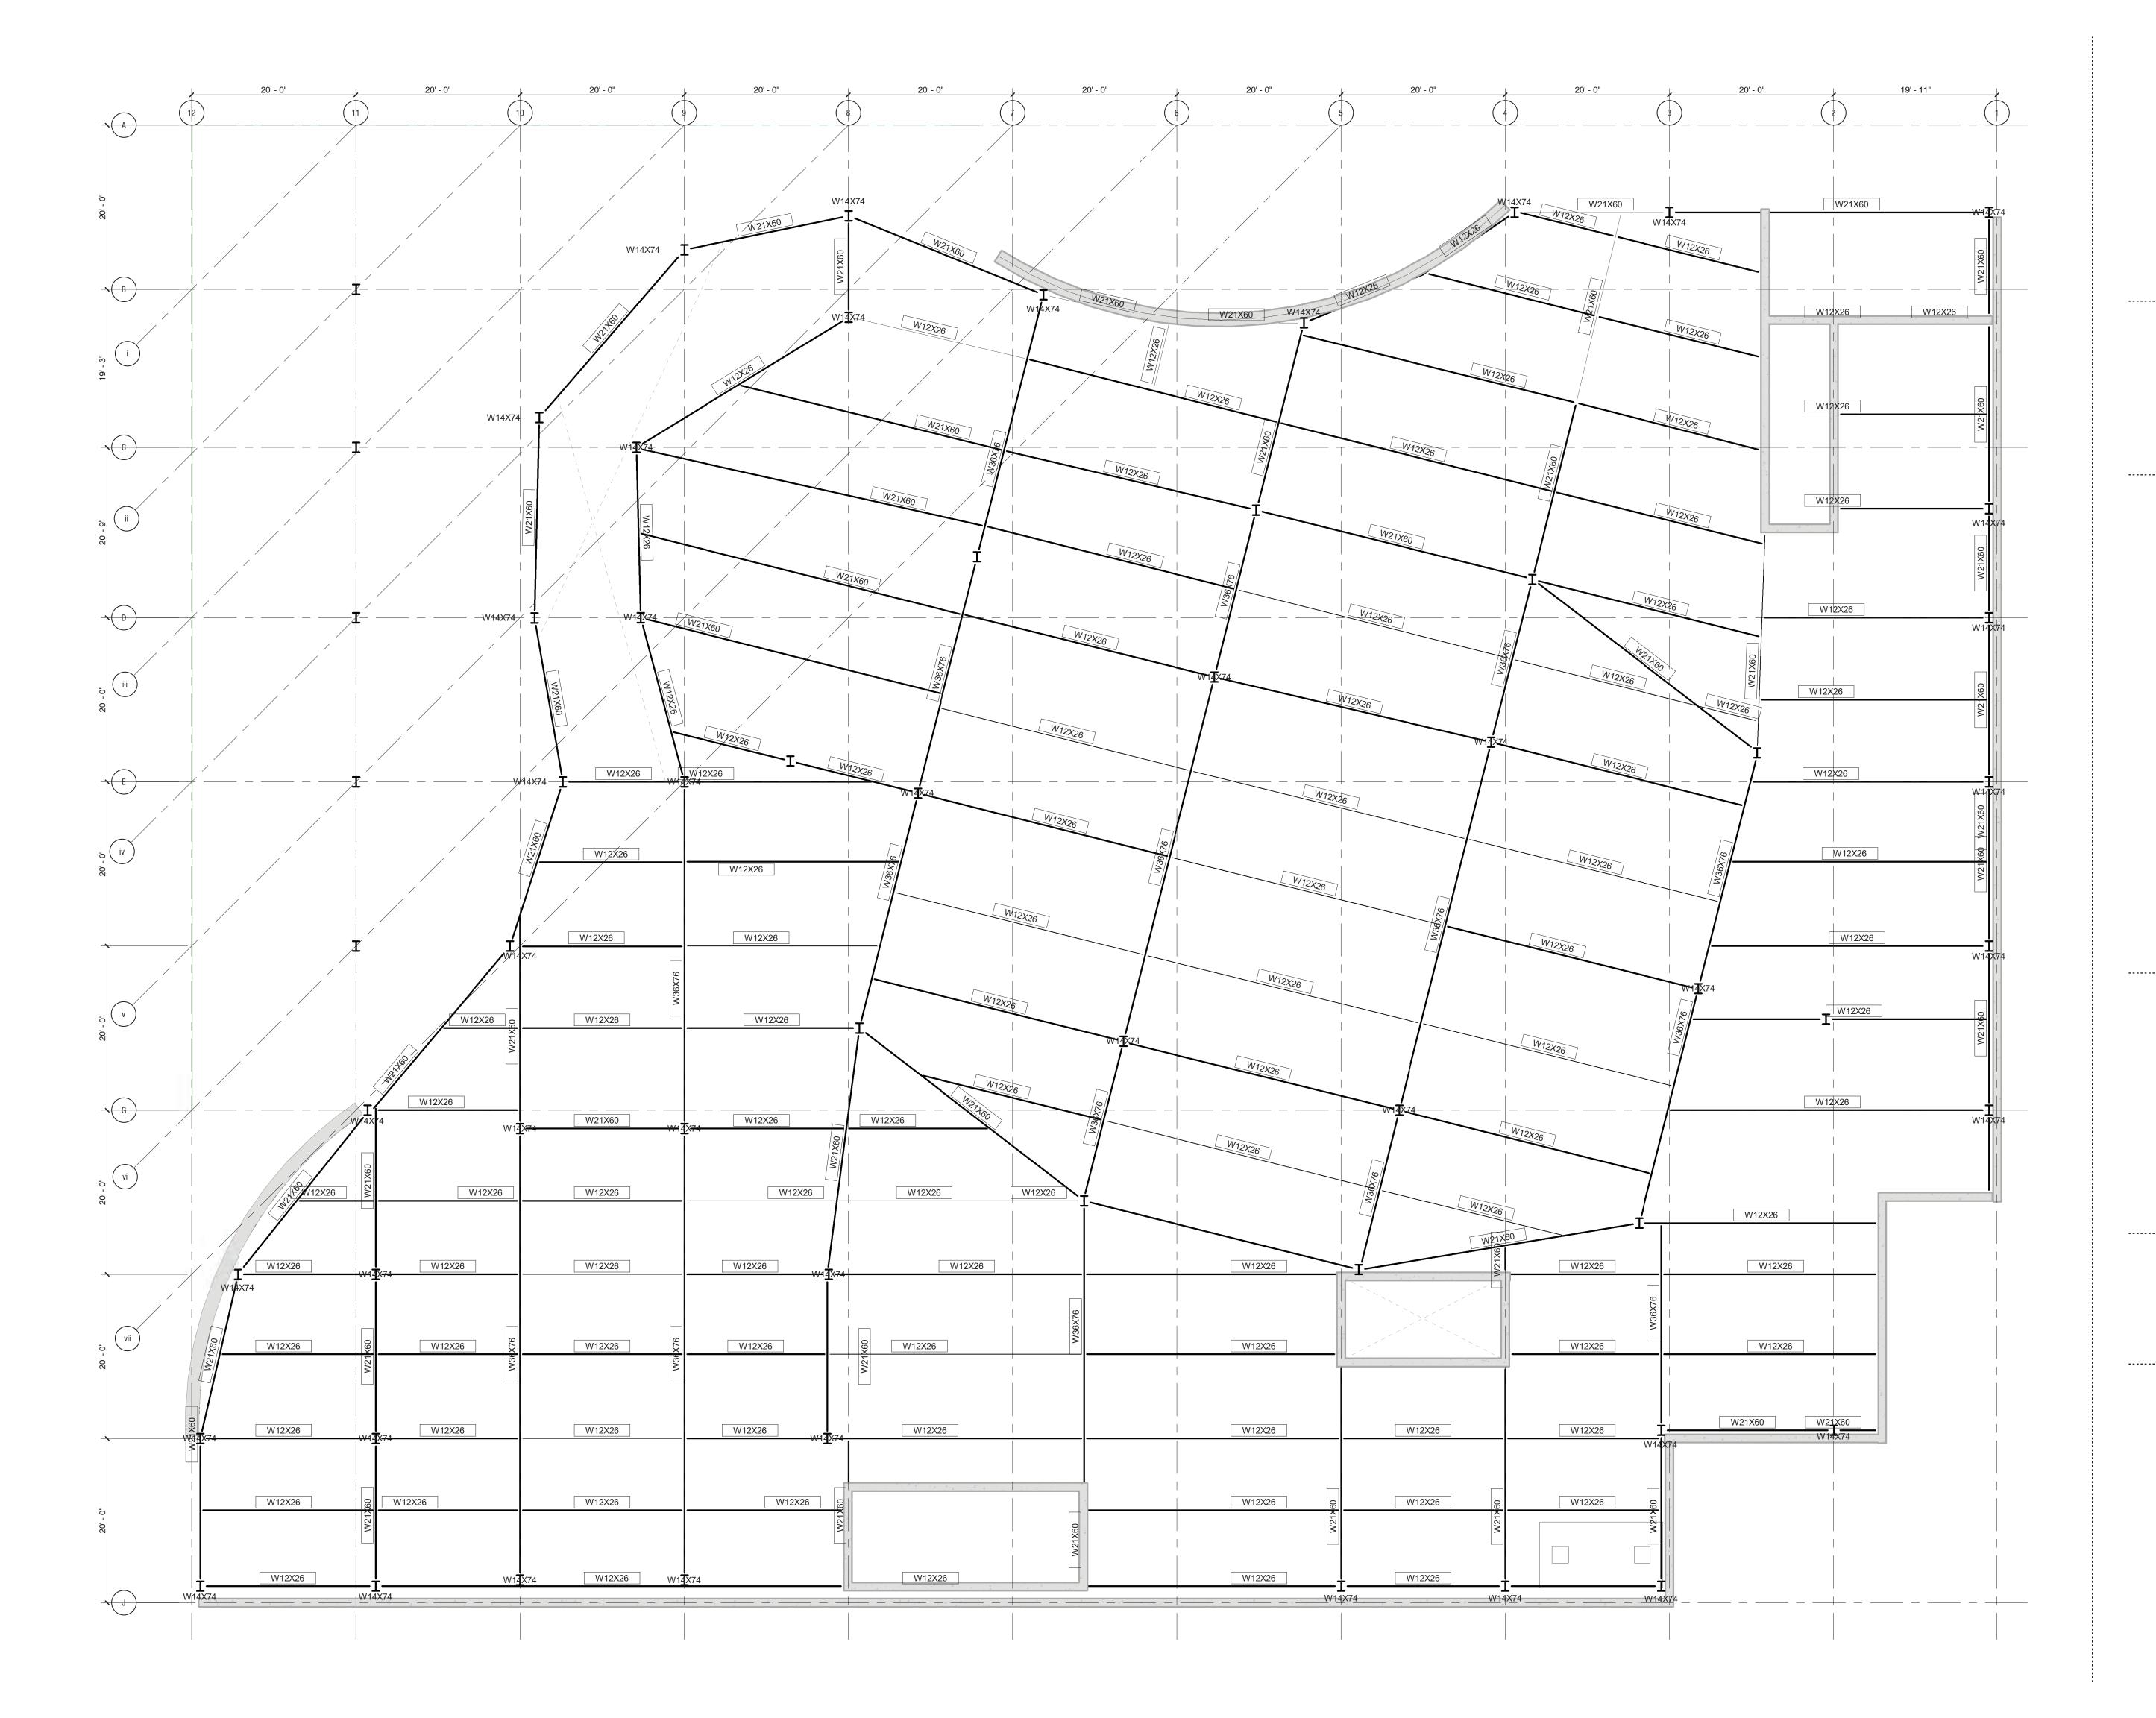
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> **PROJECT** Greenpoint Theater 18 Greenpoint Ave. Brooklyn, NY 11222

DRAWING TITLE Second Floor Structural Plan

> **DRAWING SCALE** 1/8": 1'-0"

S102





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ADDRESS

Columbia University Graduate School of Architecture, Planning and Preservation 1172 Amsterdam Ave New York, NY 10027

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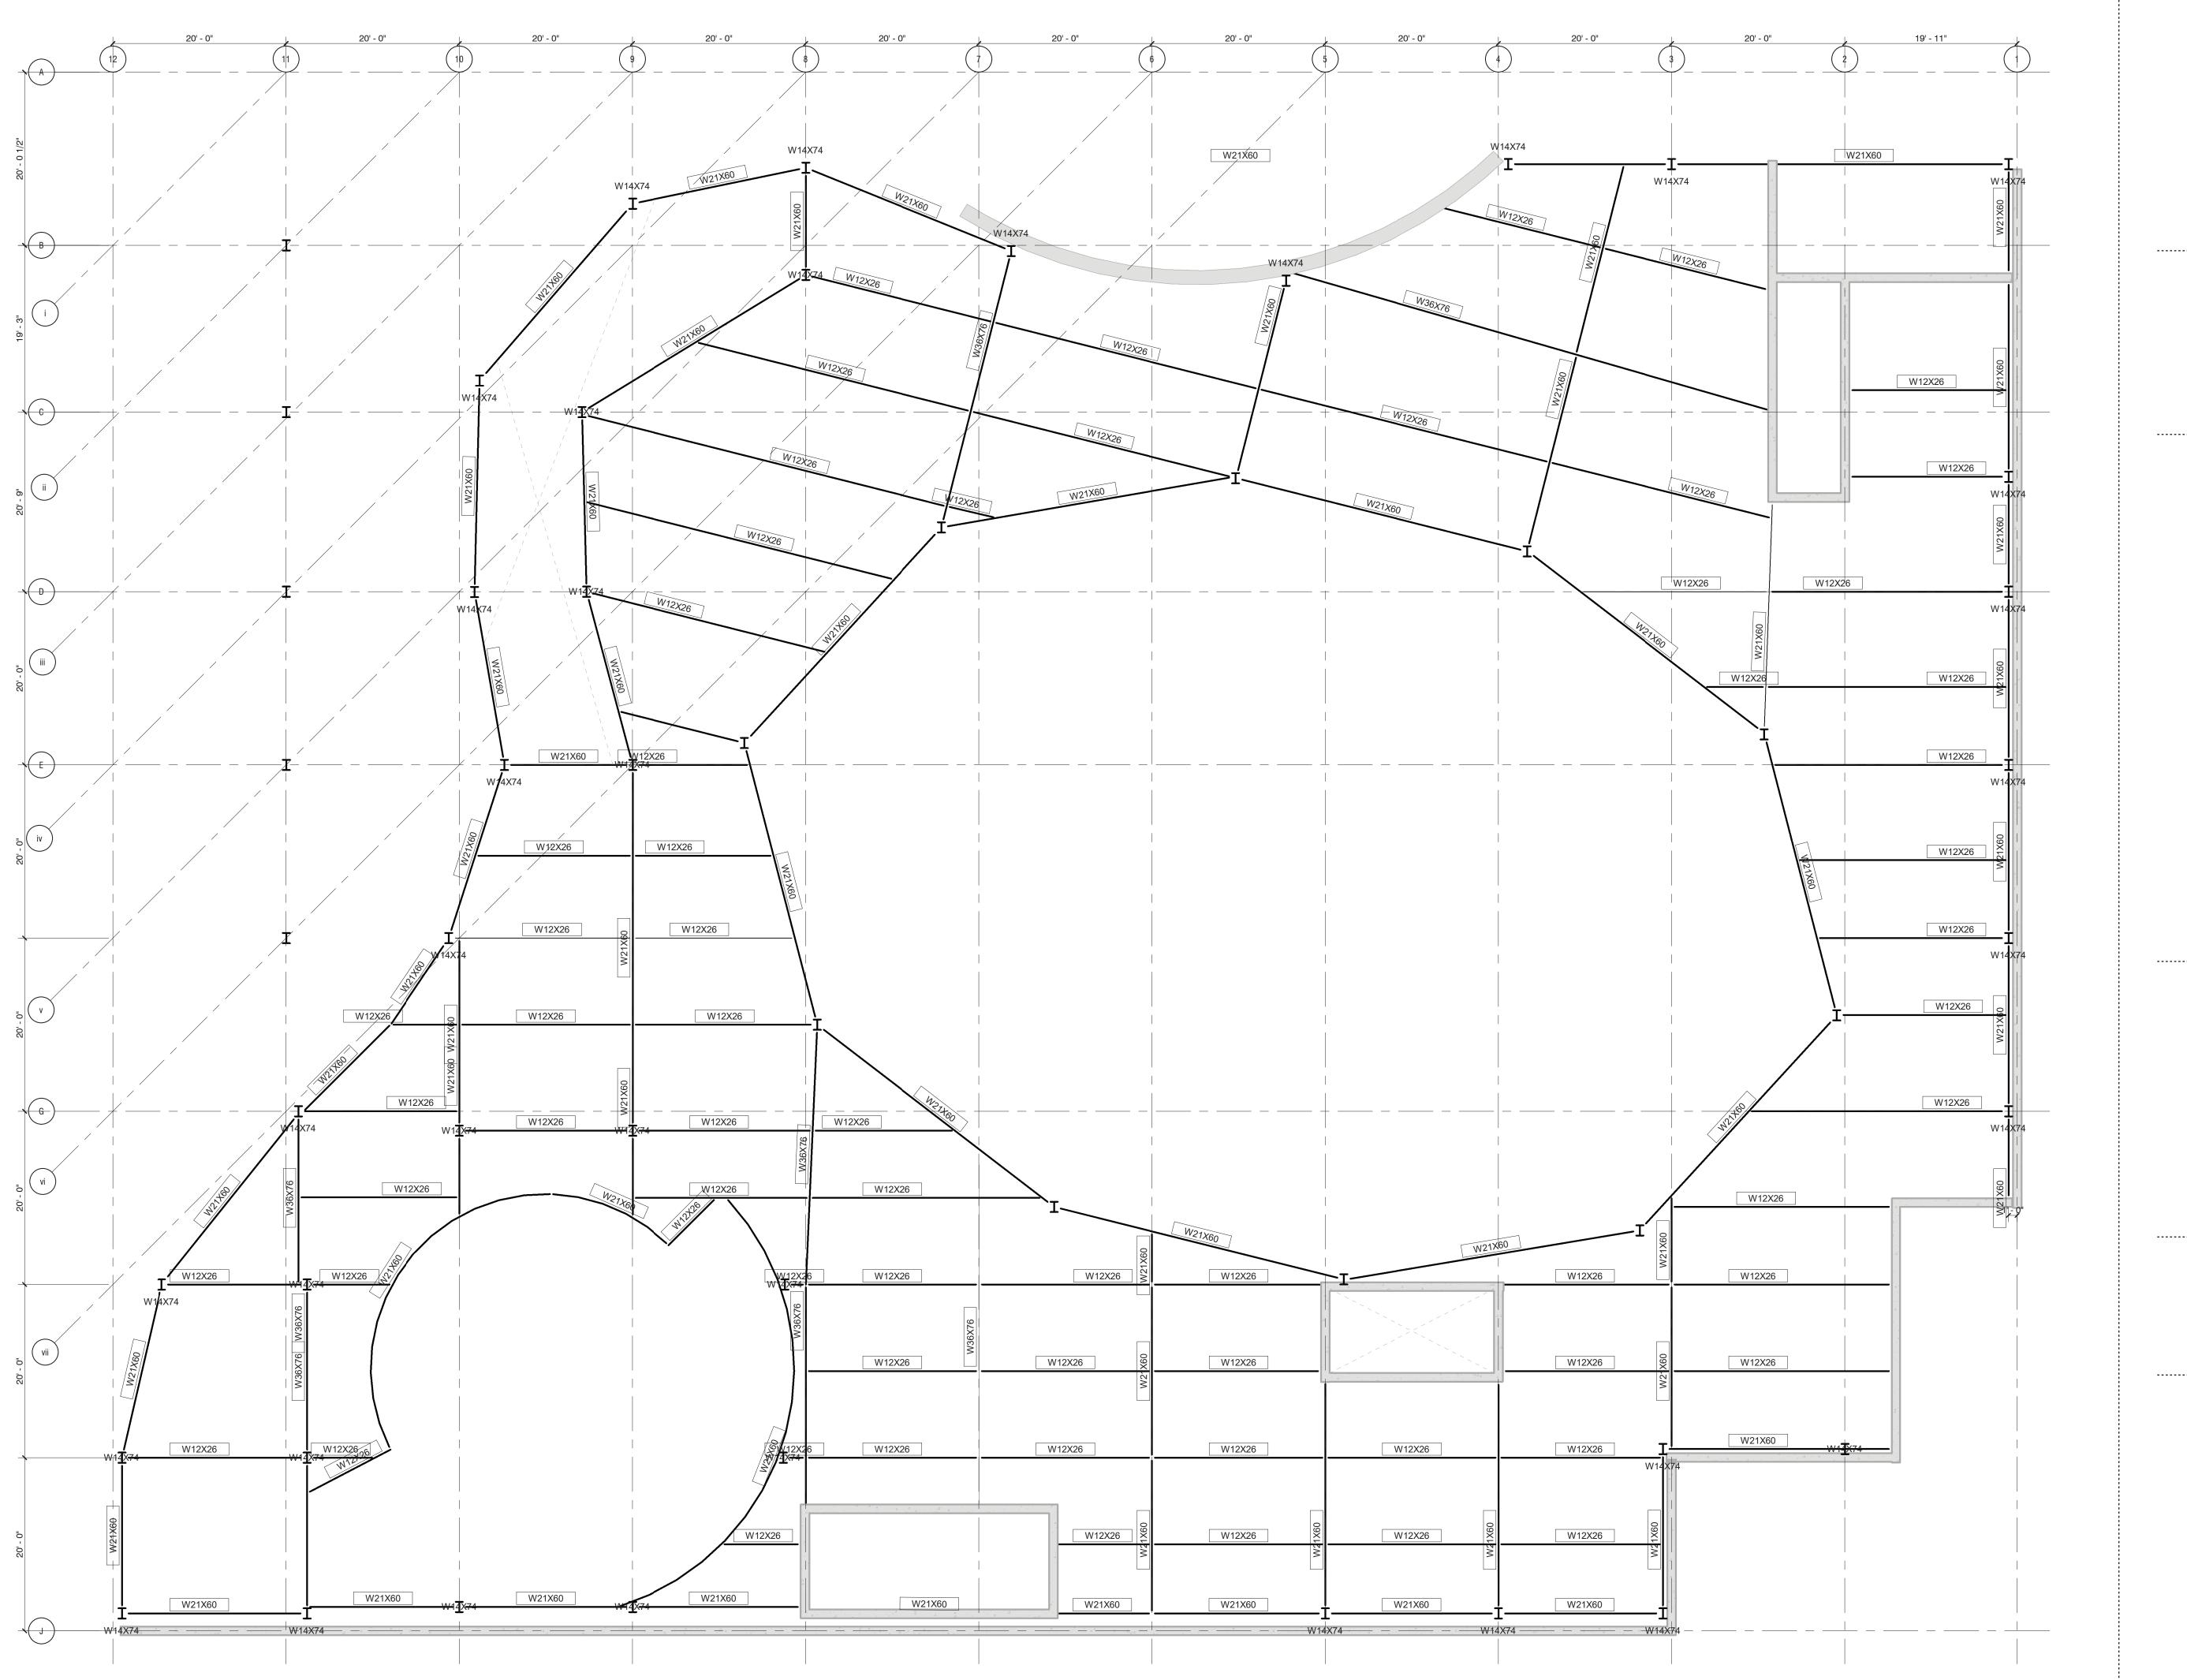
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> **PROJECT** Greenpoint Theater 18 Greenpoint Ave. Brooklyn, NY 11222

DRAWING TITLE Third Floor Structural Plan

> **DRAWING SCALE** 1/8": 1'-0"

S103





DAVID MUSA - LUIS MIGUEL PIZANO - TIANYU YANG - REEM YASSIN

ADDRESS

Columbia University Graduate School of Architecture, Planning and Preservation 1172 Amsterdam Ave New York, NY 10027

PROJECT TEAM

ARCHITECTURE TECHNICAL CONSULTING

JOSEPH HAND Shop Architects 233 Broadway 11th Floor New York, NY 10279

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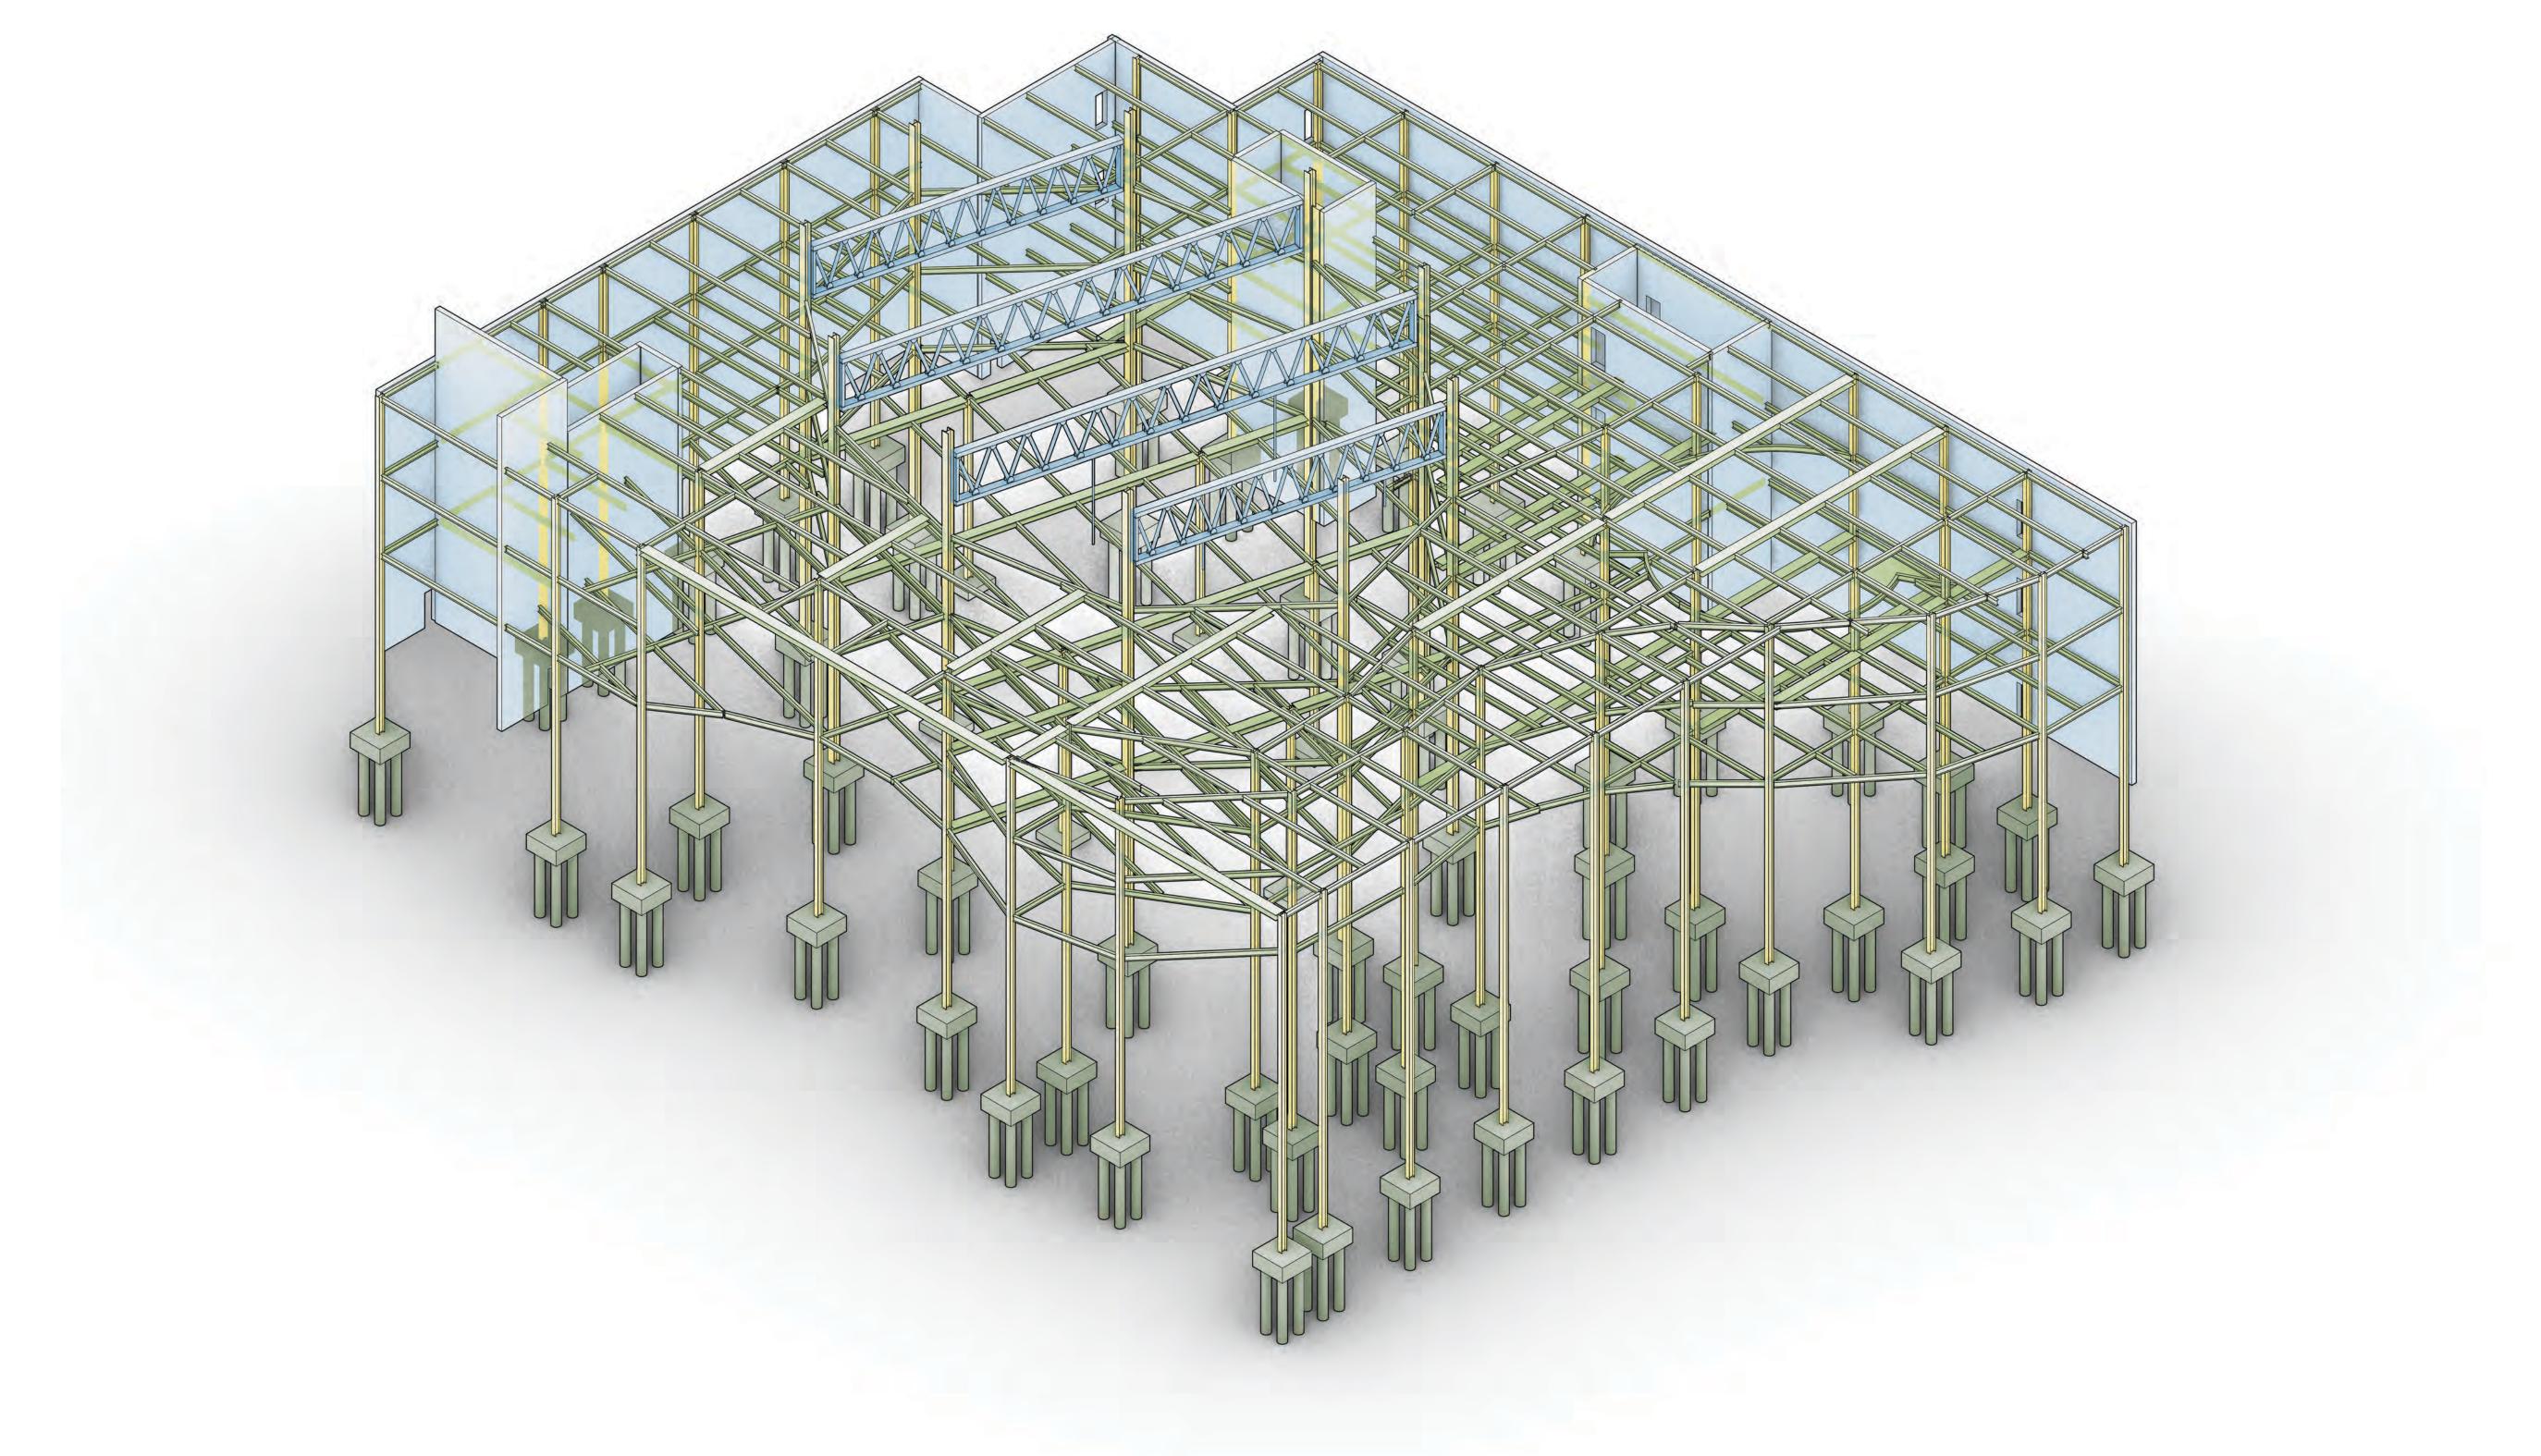
PROJECT Greenpoint Theater 18 Greenpoint Ave

18 Greenpoint Ave. Brooklyn, NY 11222

DRAWING TITLE Roof Structural Plan

DRAWING SCALE 1/8": 1'-0"

S104



BUILDING STRUCTURE & REINFORCEMENT SYSTEMS



THE CEILING-TO-FLOOR DESIGN GROUP

DAVID MUSA - LUIS MIGUEL PIZANO - TIANYU YANG - REEM YASSIN

ADDRESS

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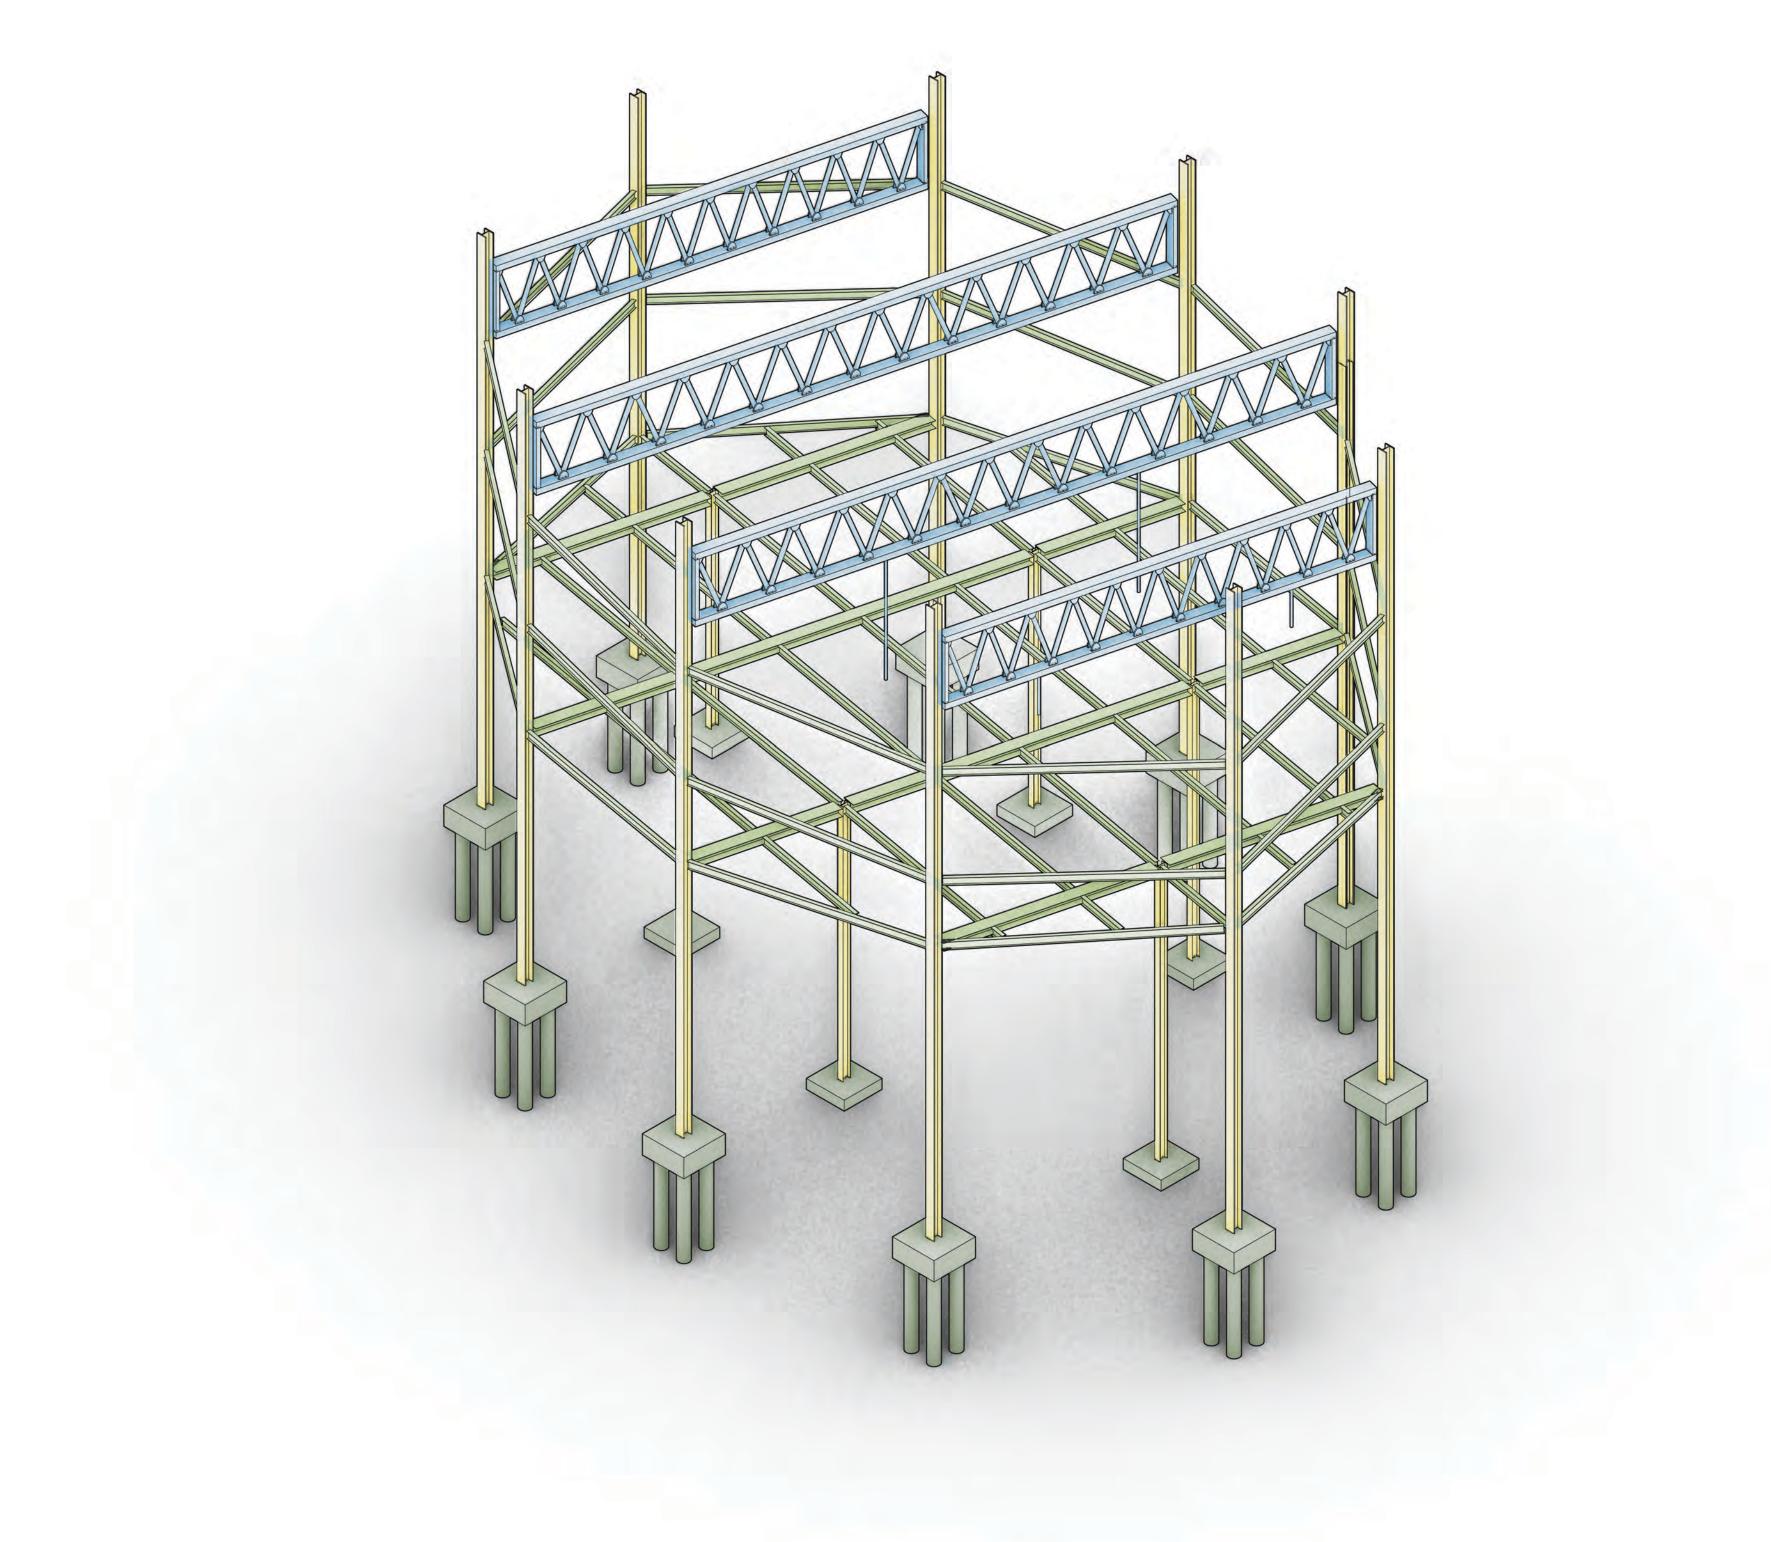
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> **PROJECT** Greenpoint Theater 18 Greenpoint Ave. Brooklyn, NY 11222

DRAWING TITLE Structural Exploded Axonometric

DRAWING SCALE

ISSUE DATE December 13, 2019 **S110**



THEATER STRUCTURE & REINFORCEMENT SYSTEMS



THE CEILING-TO-FLOOR DESIGN GROUP

DAVID MUSA - LUIS MIGUEL PIZANO - TIANYU YANG - REEM YASSIN

ADDRESS

Columbia University Graduate School of Architecture, Planning and Preservation 1172 Amsterdam Ave New York, NY 10027

PROJECT TEAM

ARCHITECTURE TECHNICAL CONSULTING

JOSEPH HAND Shop Architects 233 Broadway 11th Floor New York, NY 10279

STRUCTURAL AMY HARRINGTON PE Silman 32 Old Slip New York, NY 10005

MECHANICAL & SUSTAINABILITY

JONCE WALKER LEED AP CSBA Thornton Tomasetti, Inc. 51 Madison Ave New York, NY 10010

ENCLOSURE

KATHERINE CHAN Walter P Moore 180 Maiden Ln #803 New York, NY 10038

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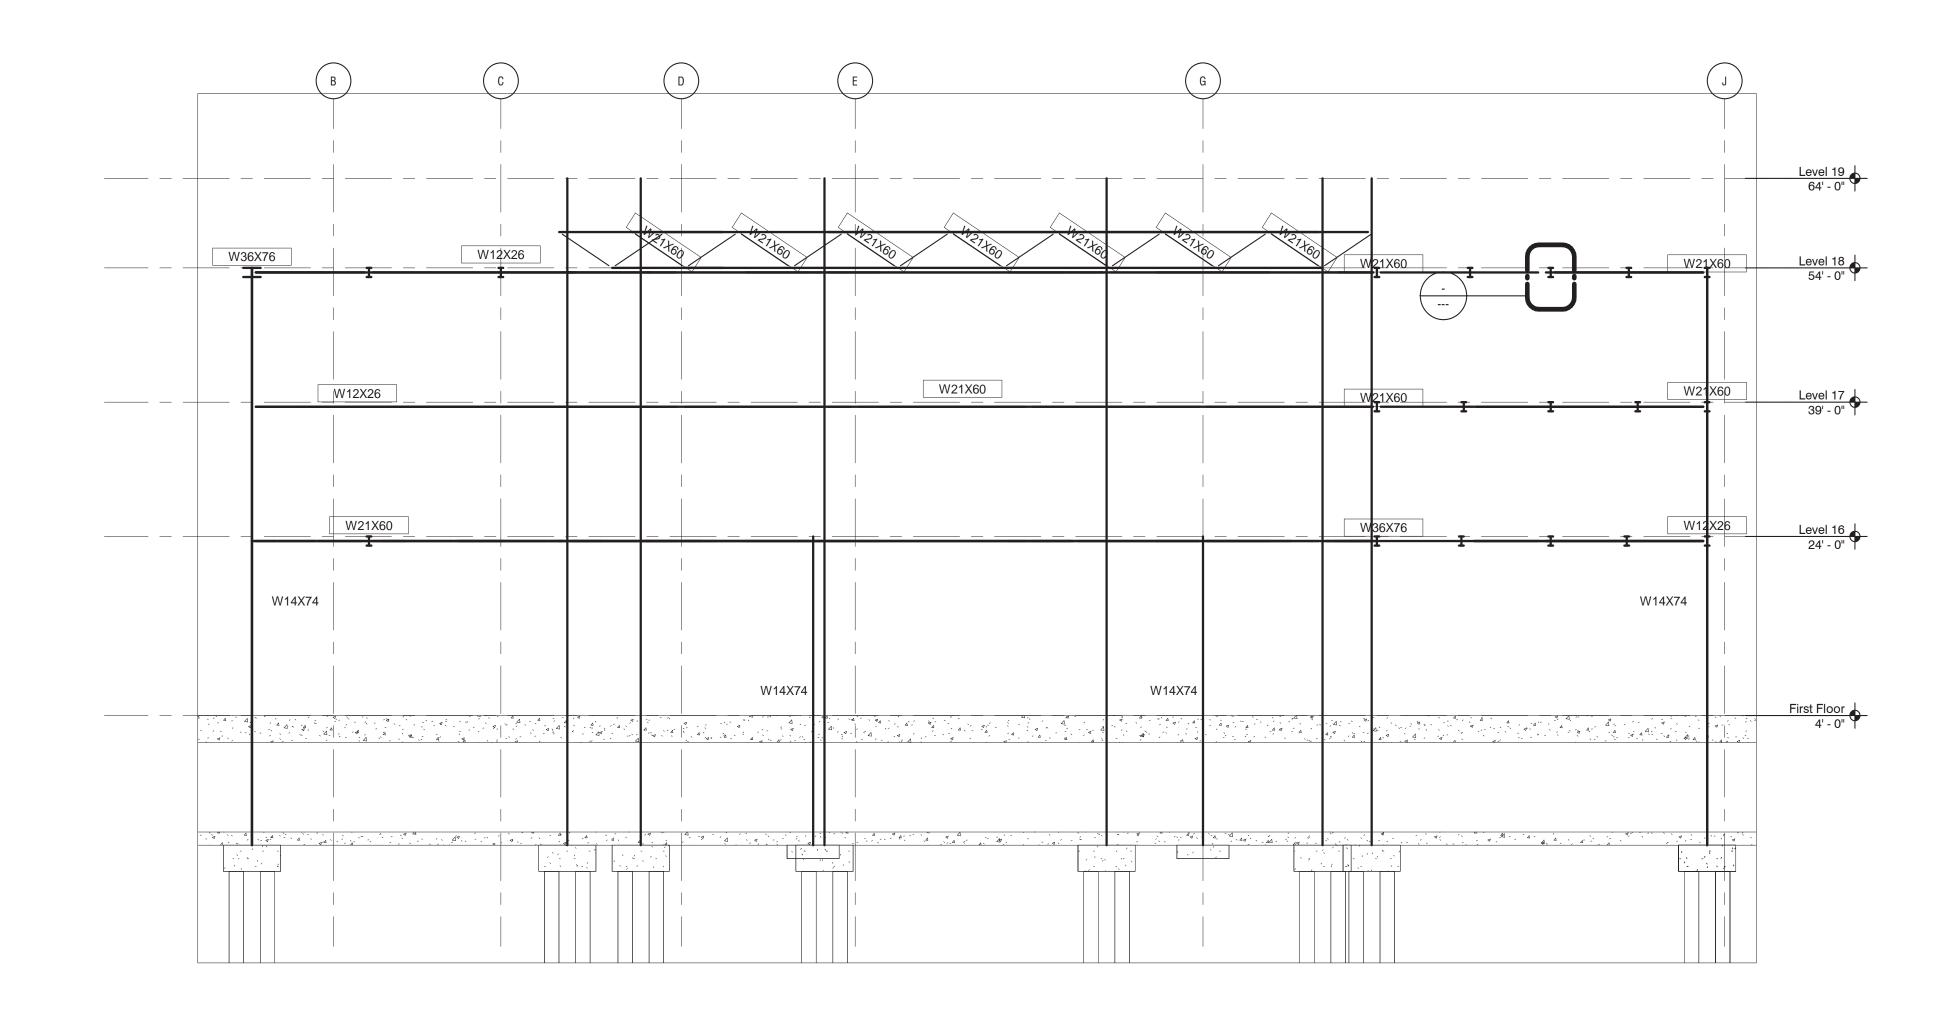
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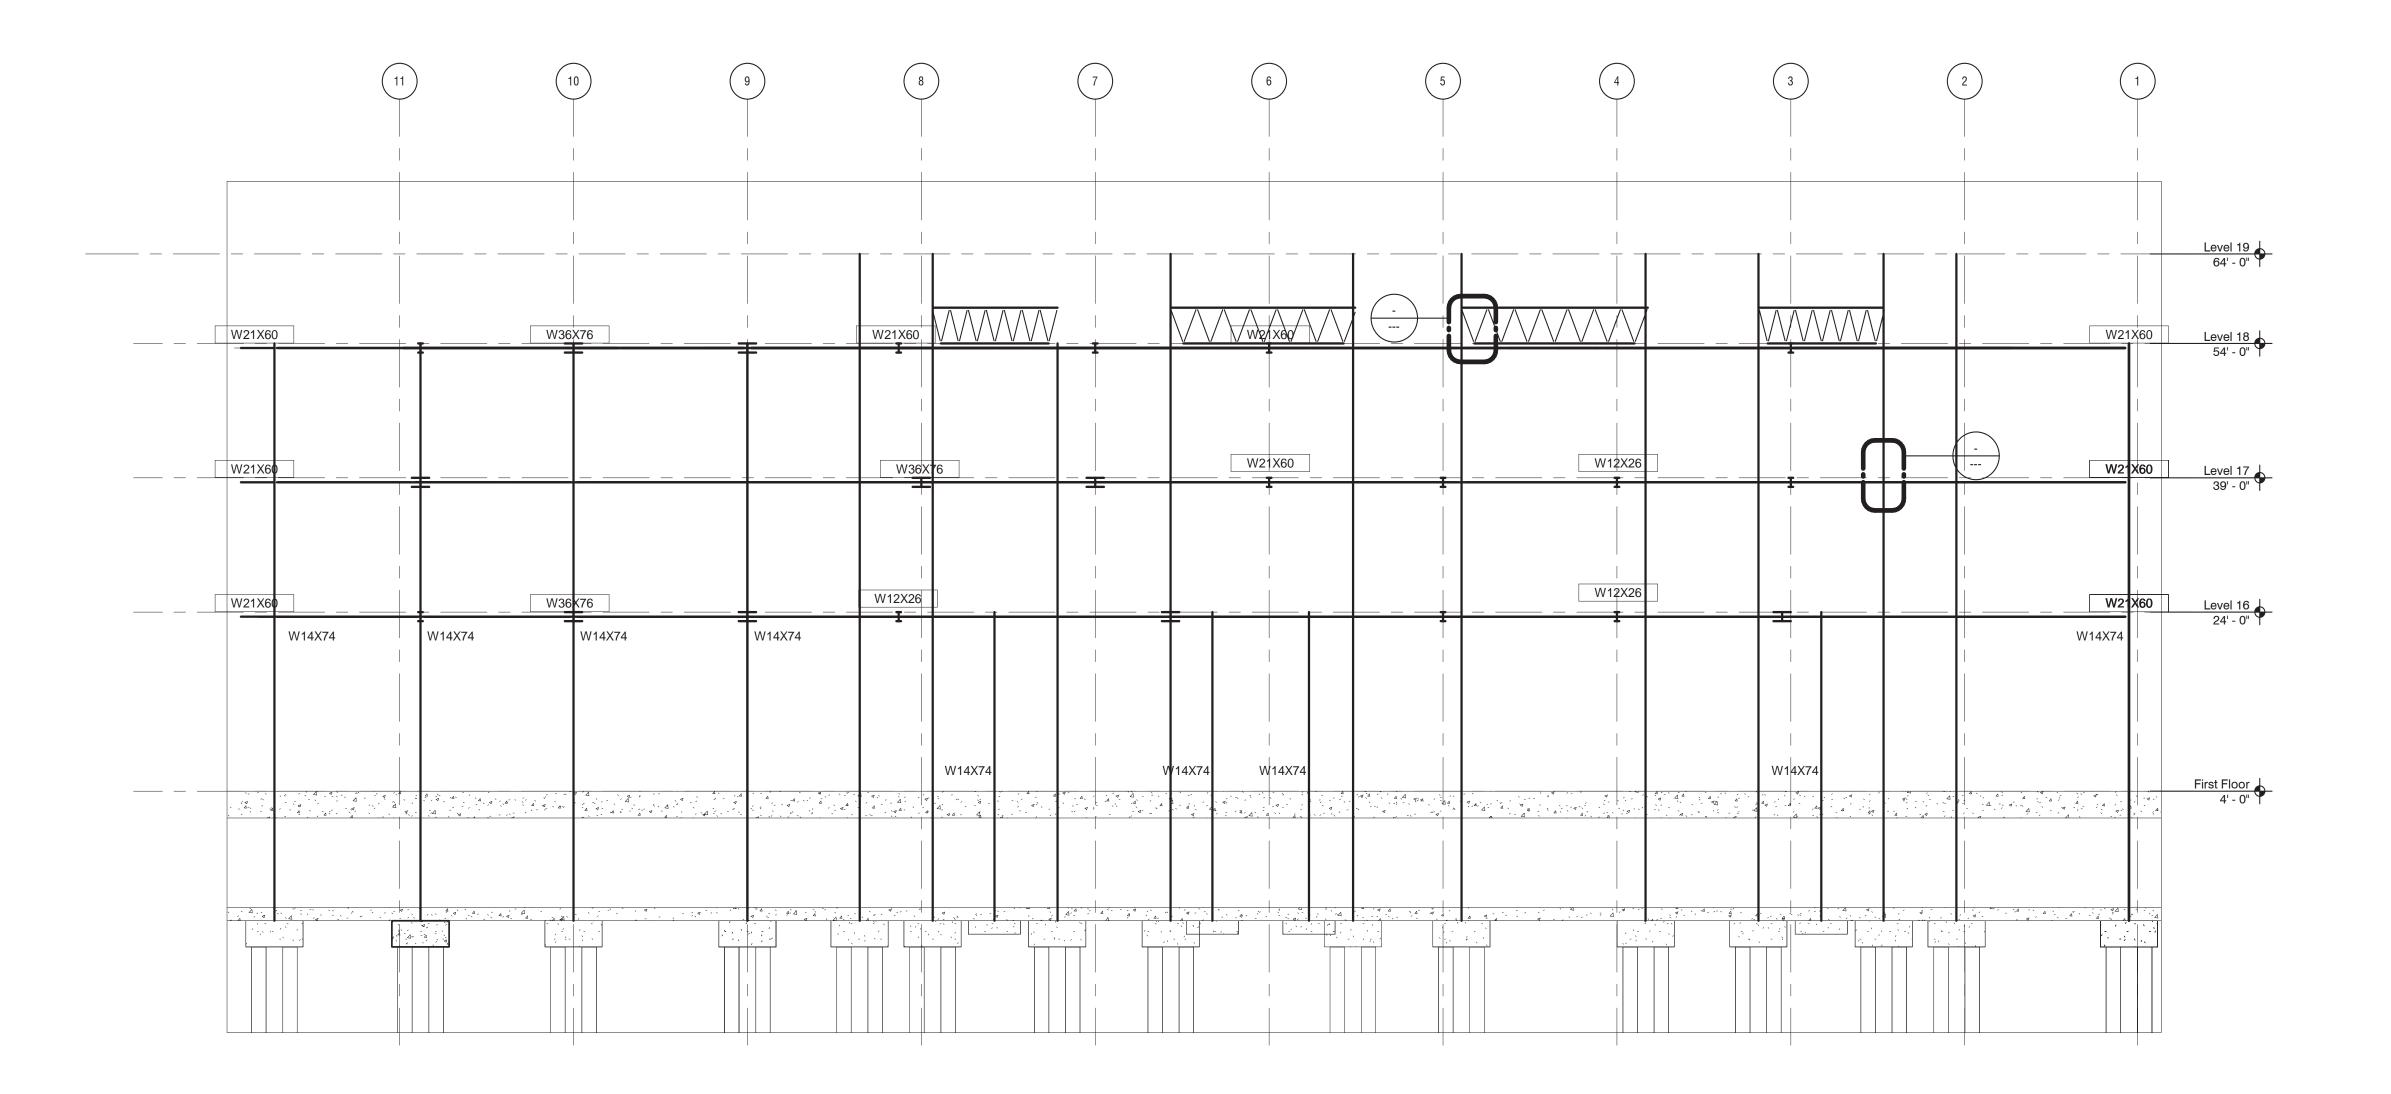
> **PROJECT** Greenpoint Theater 18 Greenpoint Ave. Brooklyn, NY 11222

DRAWING TITLE Structural Exploded Axonometric

DRAWING SCALE

S







DAVID MUSA - LUIS MIGUEL PIZANO - TIANYU YANG - REEM YASSIN

ADDRESS

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PROJECT TEAM

ARCHITECTURE TECHNICAL CONSULTING

JOSEPH HAND Shop Architects 233 Broadway 11th Floor New York, NY 10279

STRUCTURAL AMY HARRINGTON PE Silman 32 Old Slip New York, NY 10005

MECHANICAL & SUSTAINABILITY

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ENCLOSURE

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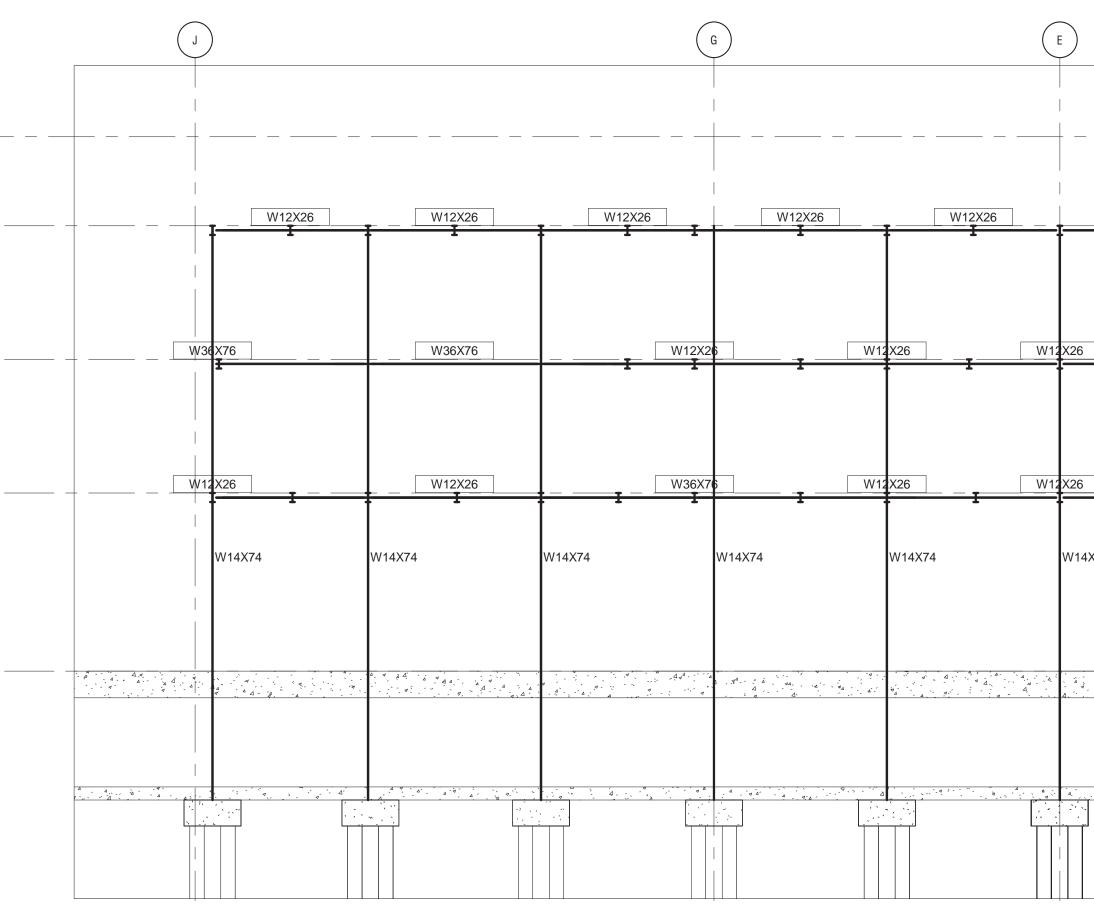
PROJECT


Greenpoint Theater 18 Greenpoint Ave. Brooklyn, NY 11222

DRAWING TITLE Structural Section

DRAWING SCALE 3/32" = 1' - 0"

S201



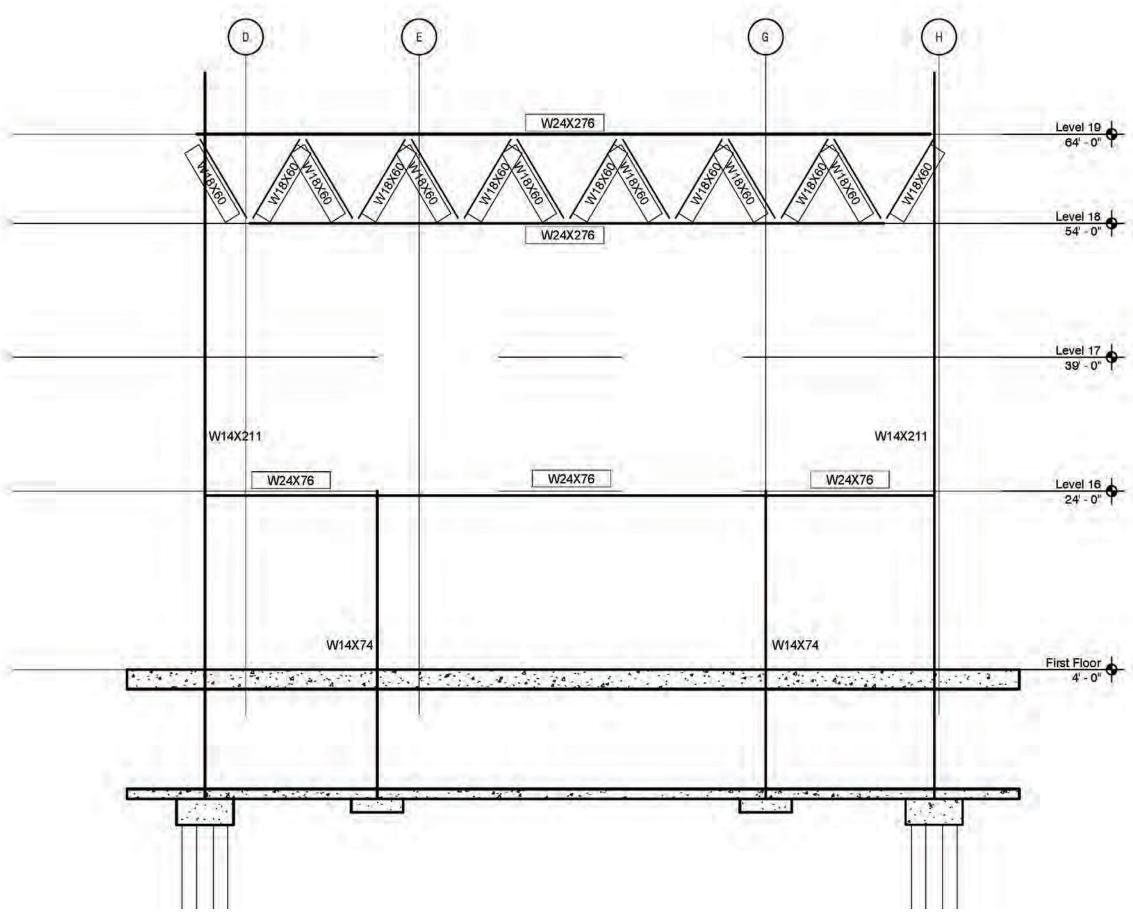

				A	
	 	 	 		Level 19 64' - 0"
W12X26	W12X26		W36X76		Level 18 54' - 0"
	W21X60	W21X60			Level 17 39' - 0"
					39' - 0"
<u></u>	W12X26	W21X60	<u></u>		Level 16 24' - 0"
IX74	W14X74	W14X74	W14X74		
					First Floor 4' - 0"
			а Д-лая Х. Х. , , , , , , , , , , , , , , , , , , ,		
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DAVID MUSA - LUIS MIGUEL PIZANO - TIANYU YANG - REEM YASSIN

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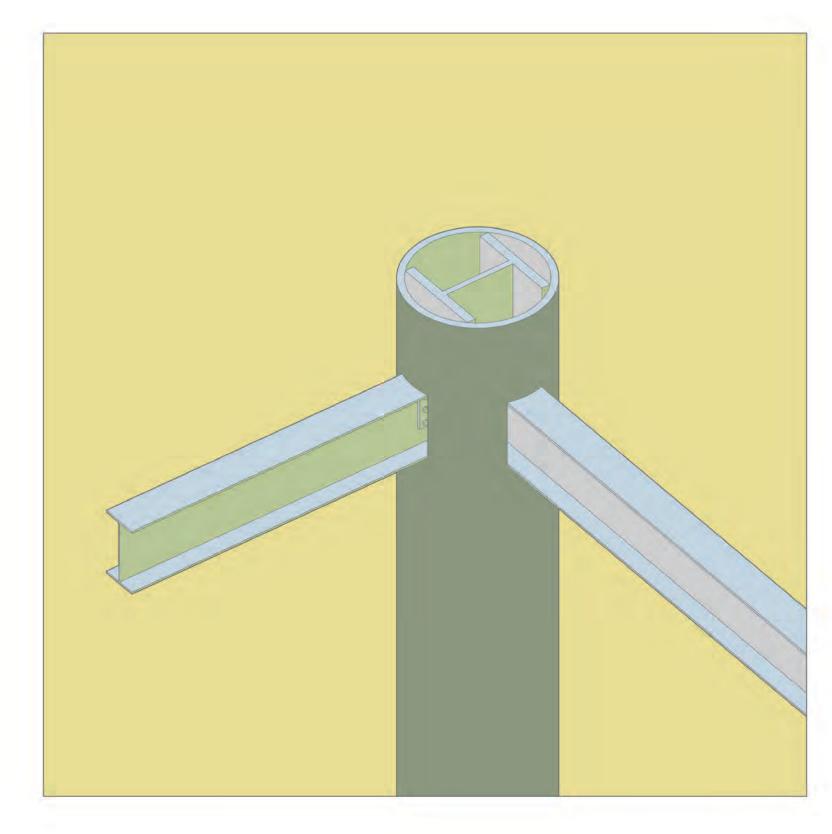
PROJECT

Greenpoint Theater 18 Greenpoint Ave. Brooklyn, NY 11222


DRAWING TITLE Structural Section

DRAWING SCALE 3/32" = 1' - 0"


S 202




1: REINFORCED STEEL COLUMN

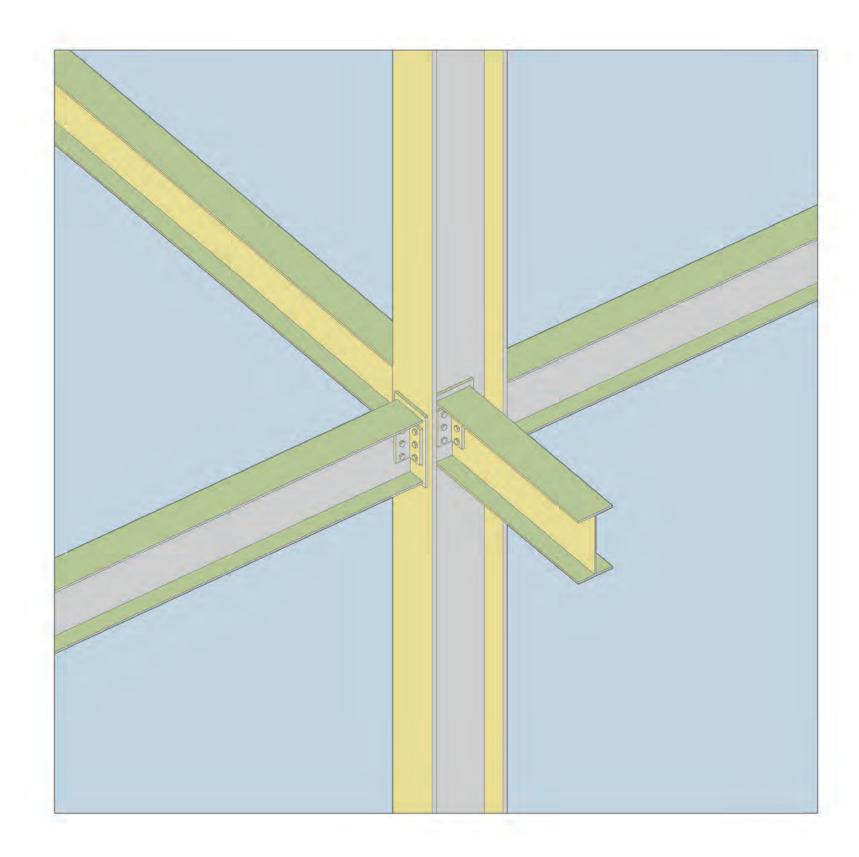

3: BEAM-STEEL COLUMN CONNECTION

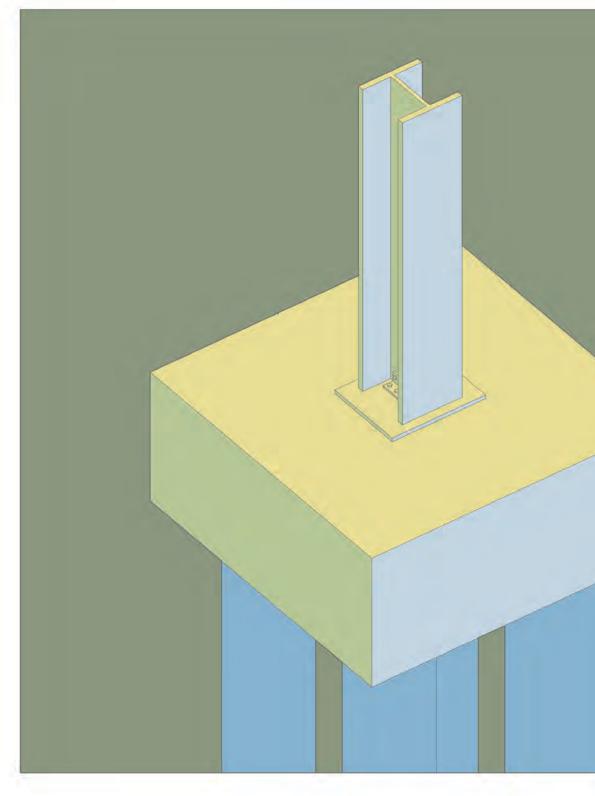

2: CONCRETE PILE CAP WITH STEEL COLUMN

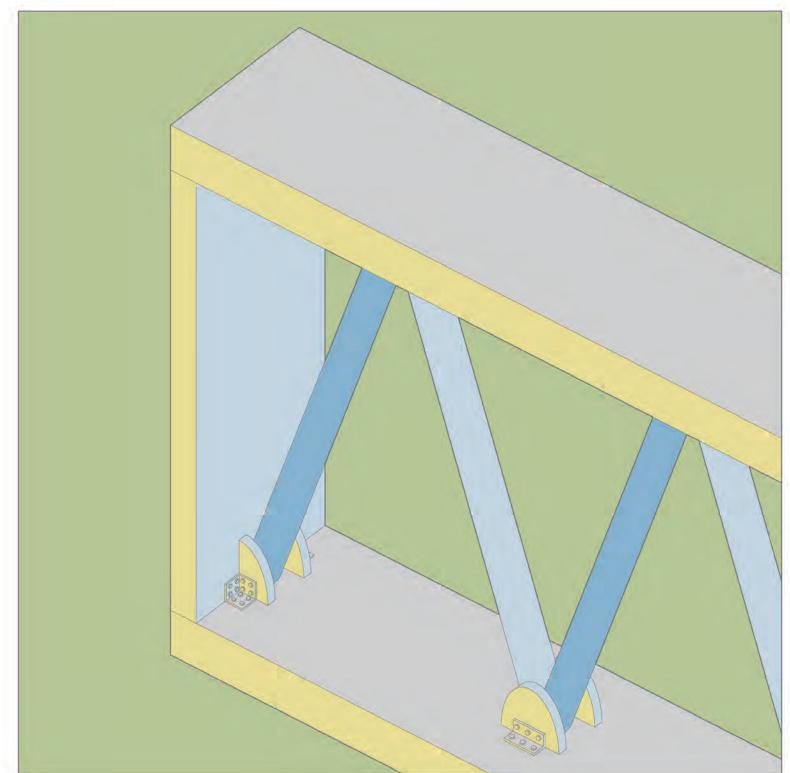

4: STEEL TRUSS FOR THEATER REINFORCEMENT



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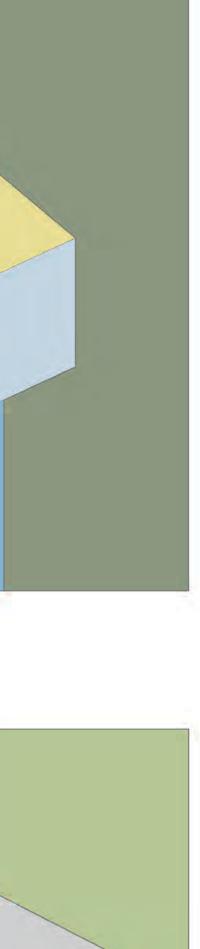
PROJECT Greenpoint Theater


18 Greenpoint Ave. Brooklyn, NY 11222

DRAWING TITLE Structural Details

DRAWING SCALE

S301



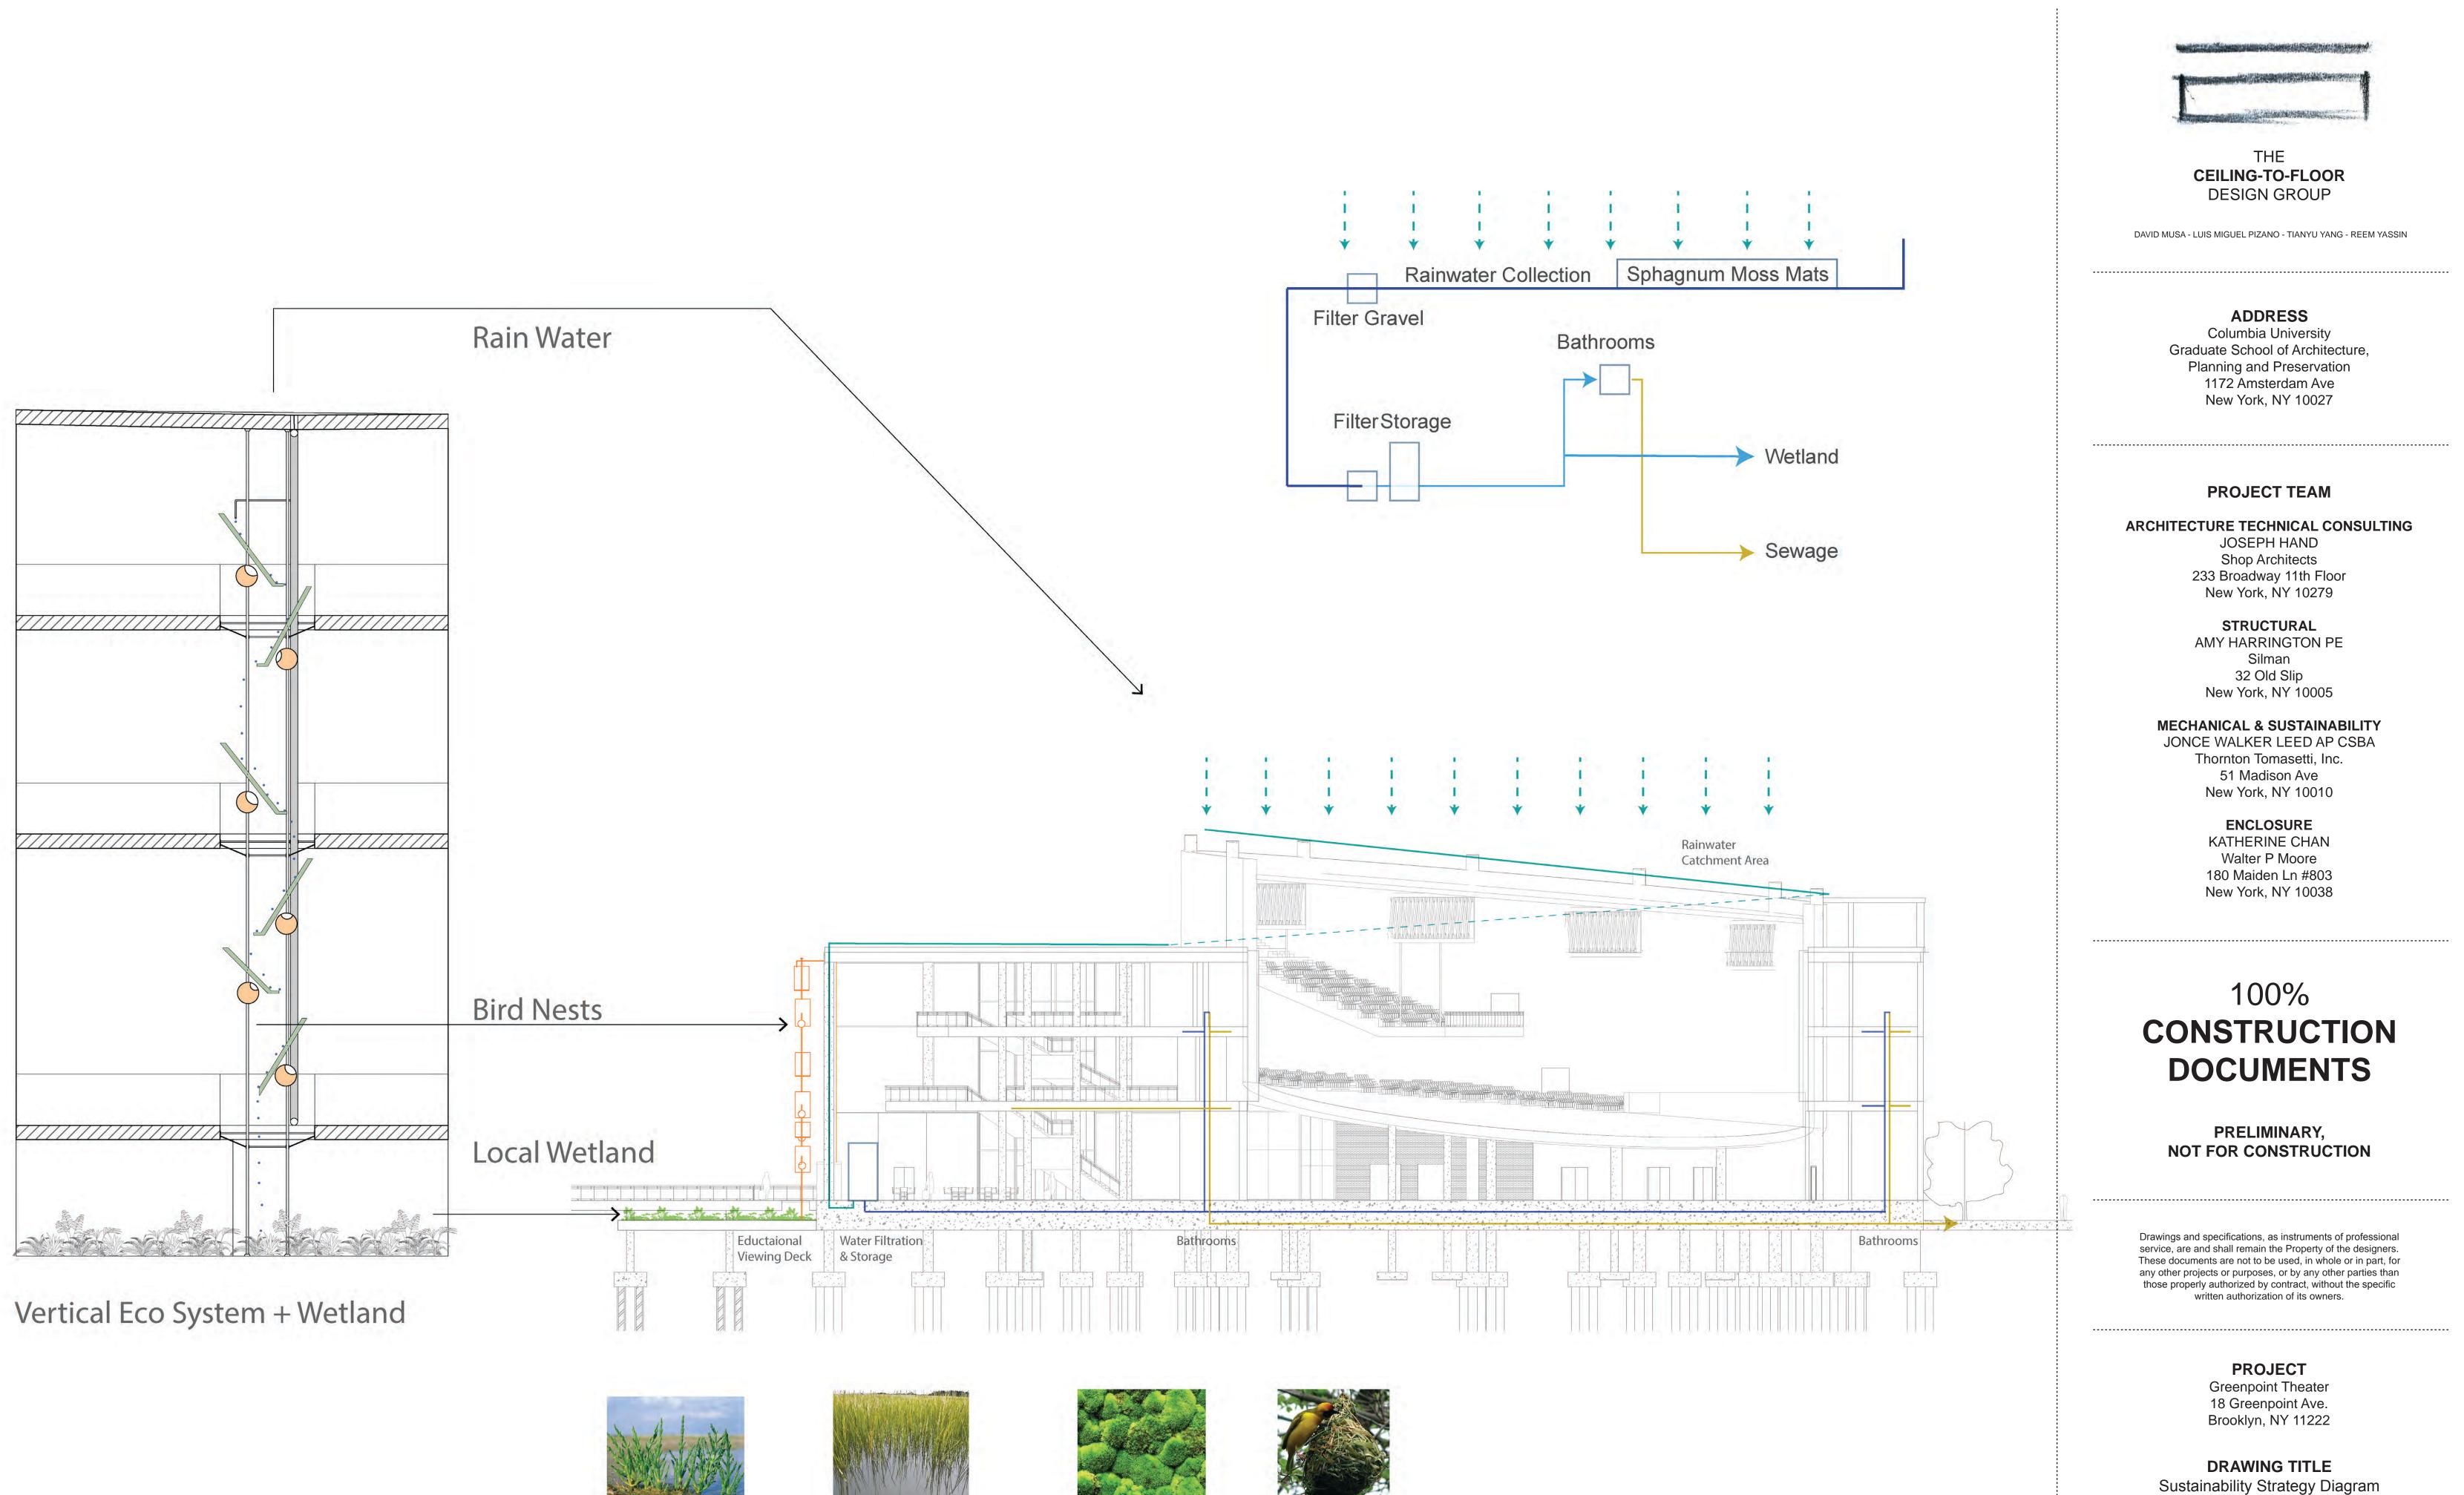



Glasswort



Smooth Cordgrass


Sphagnum Moss




Moss Bird Nest

DRAWING SCALE

MOO

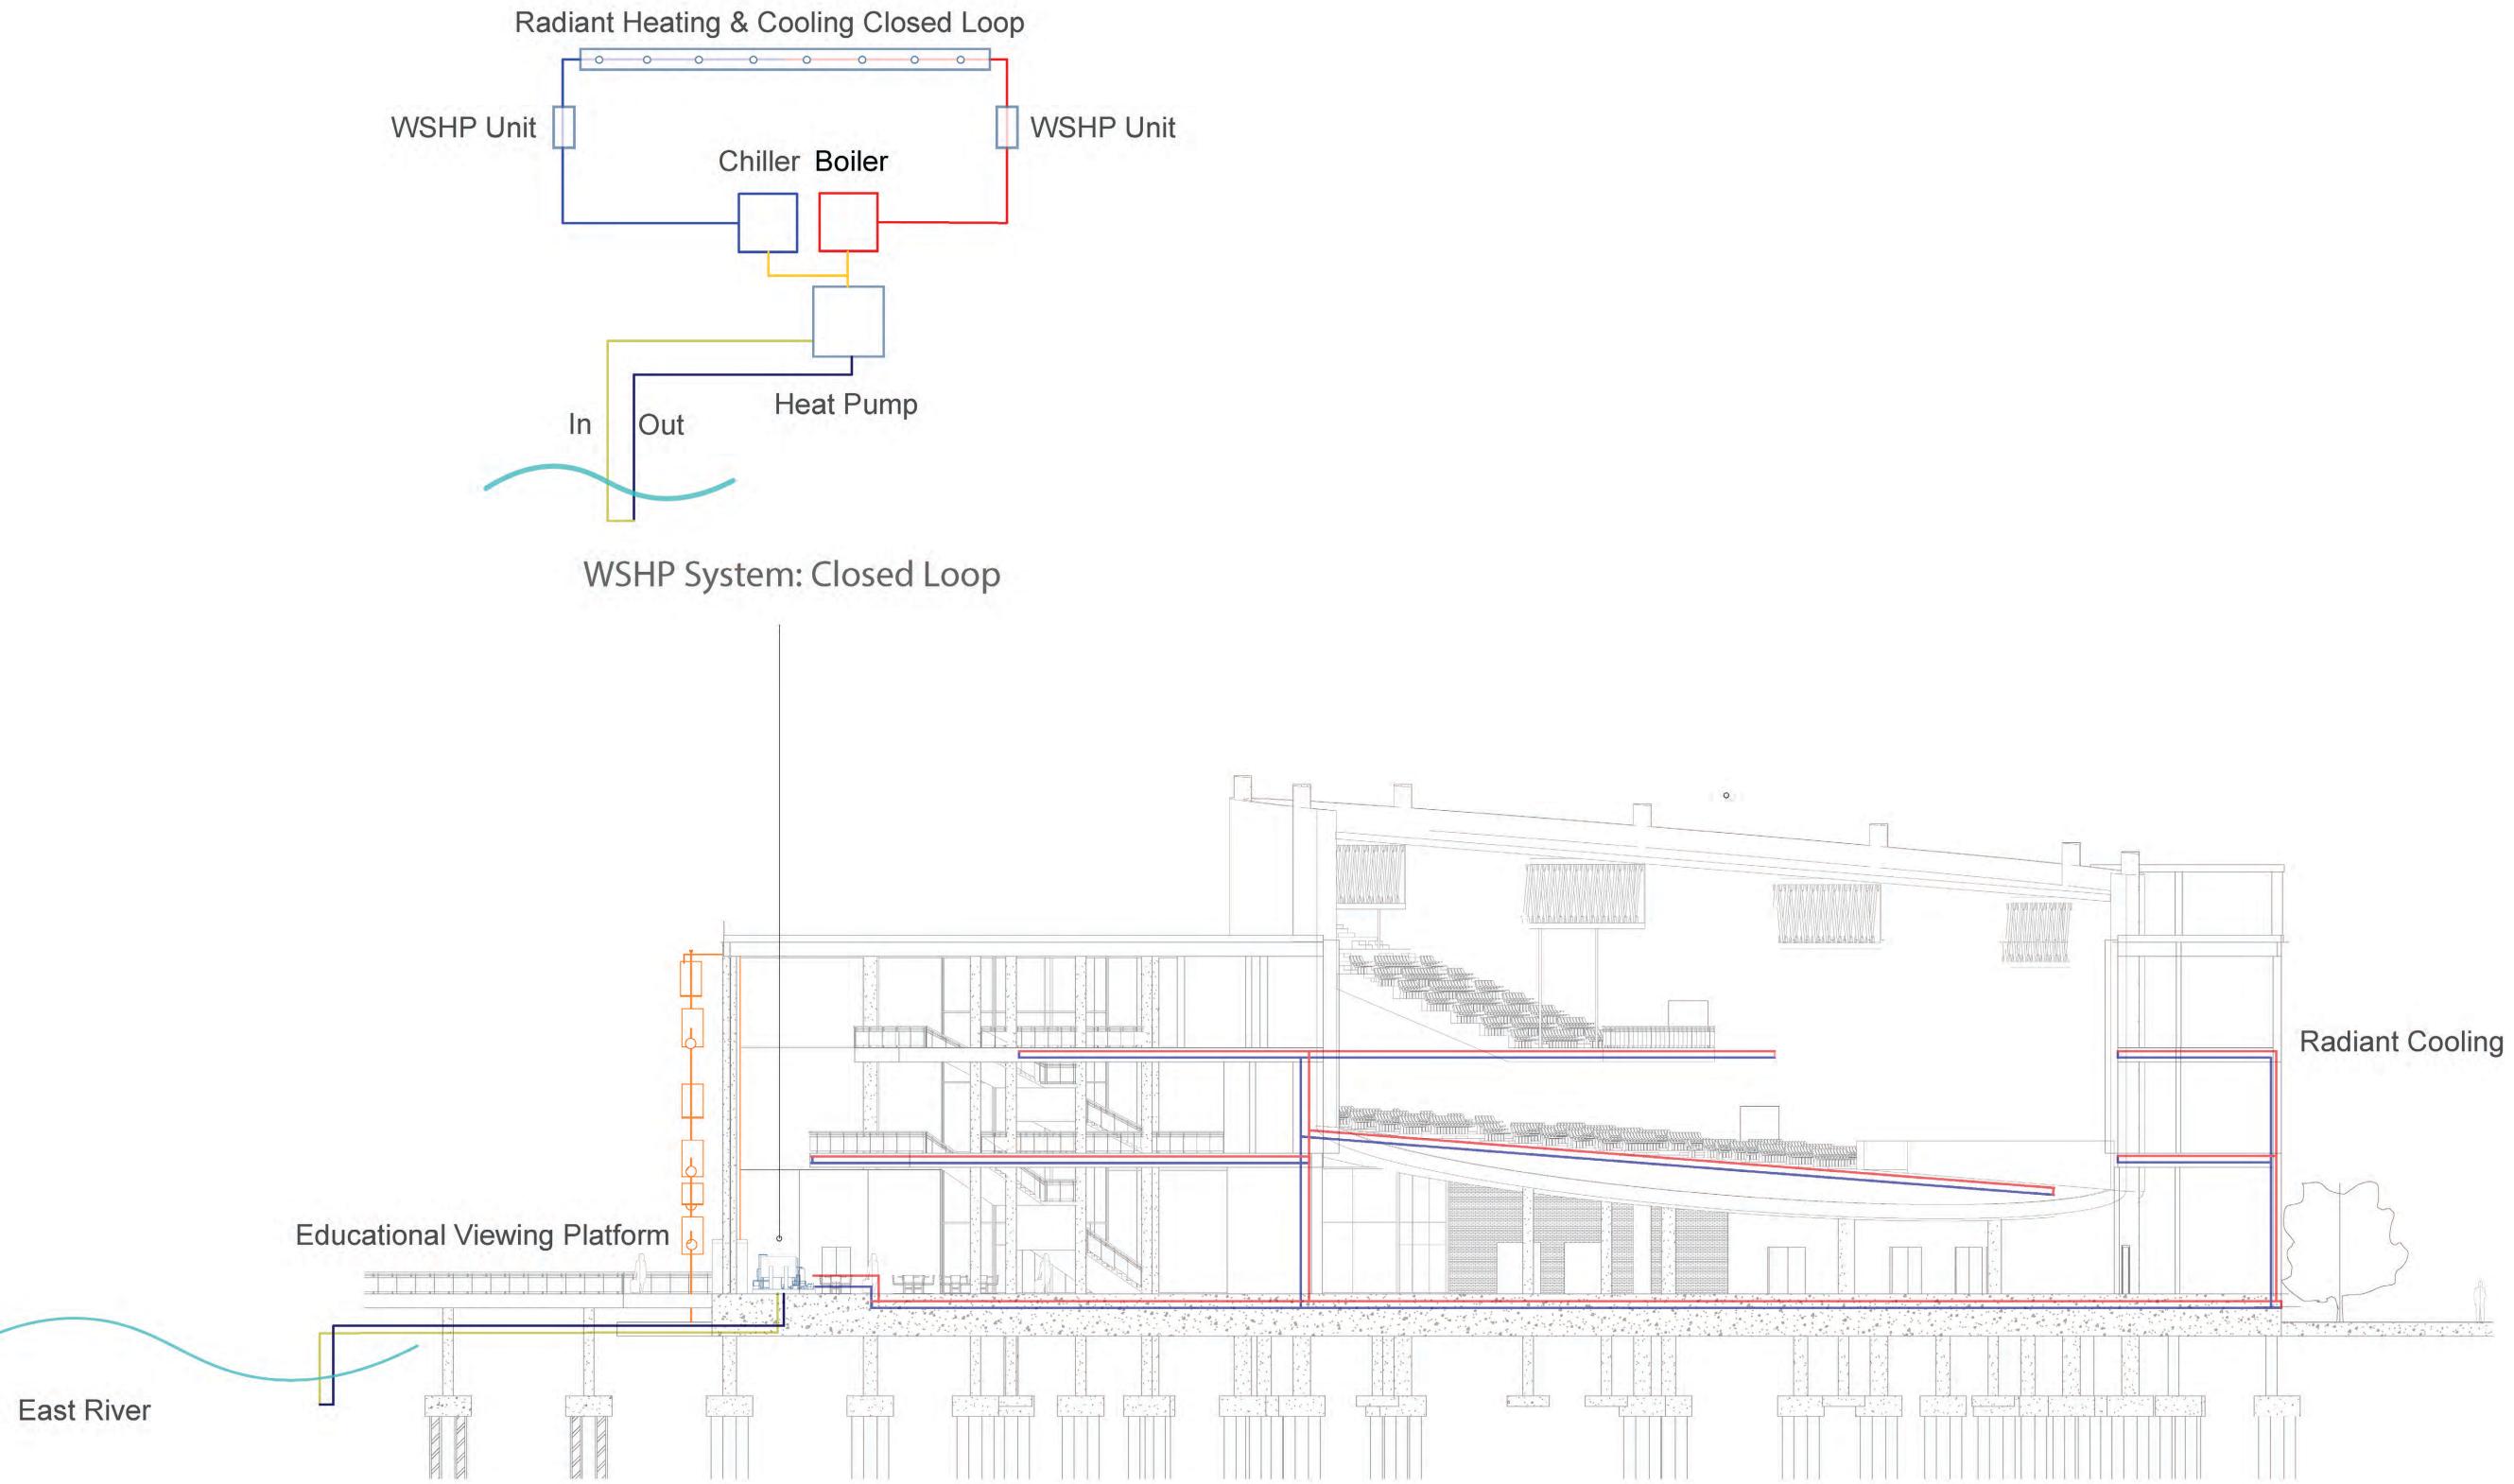

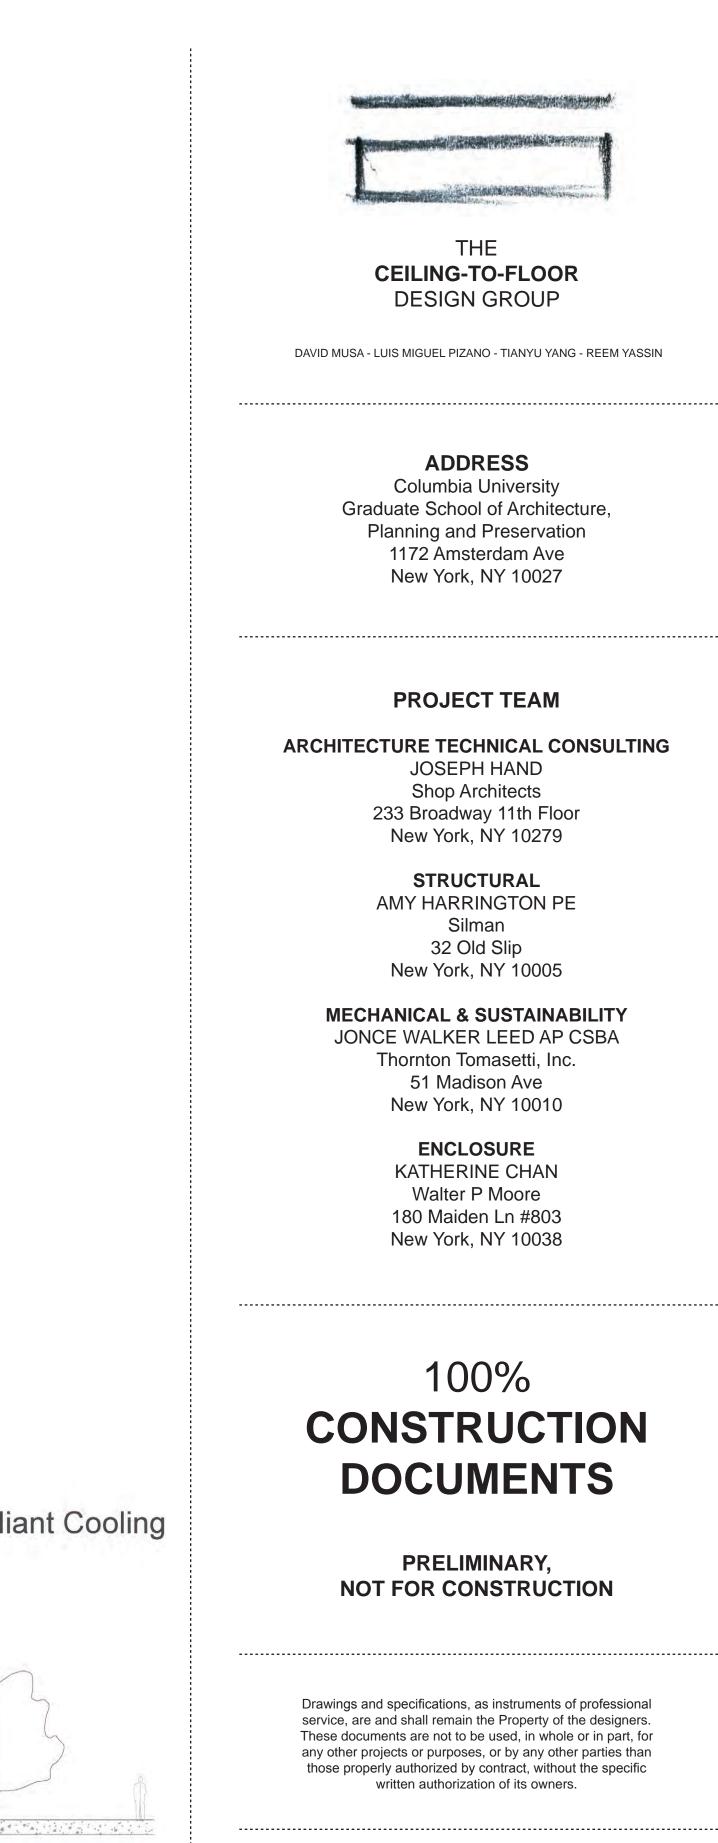


PROJECT Greenpoint Theater 18 Greenpoint Ave. Brooklyn, NY 11222


DRAWING TITLE Sustainability Strategy Diagram


DRAWING SCALE

M002

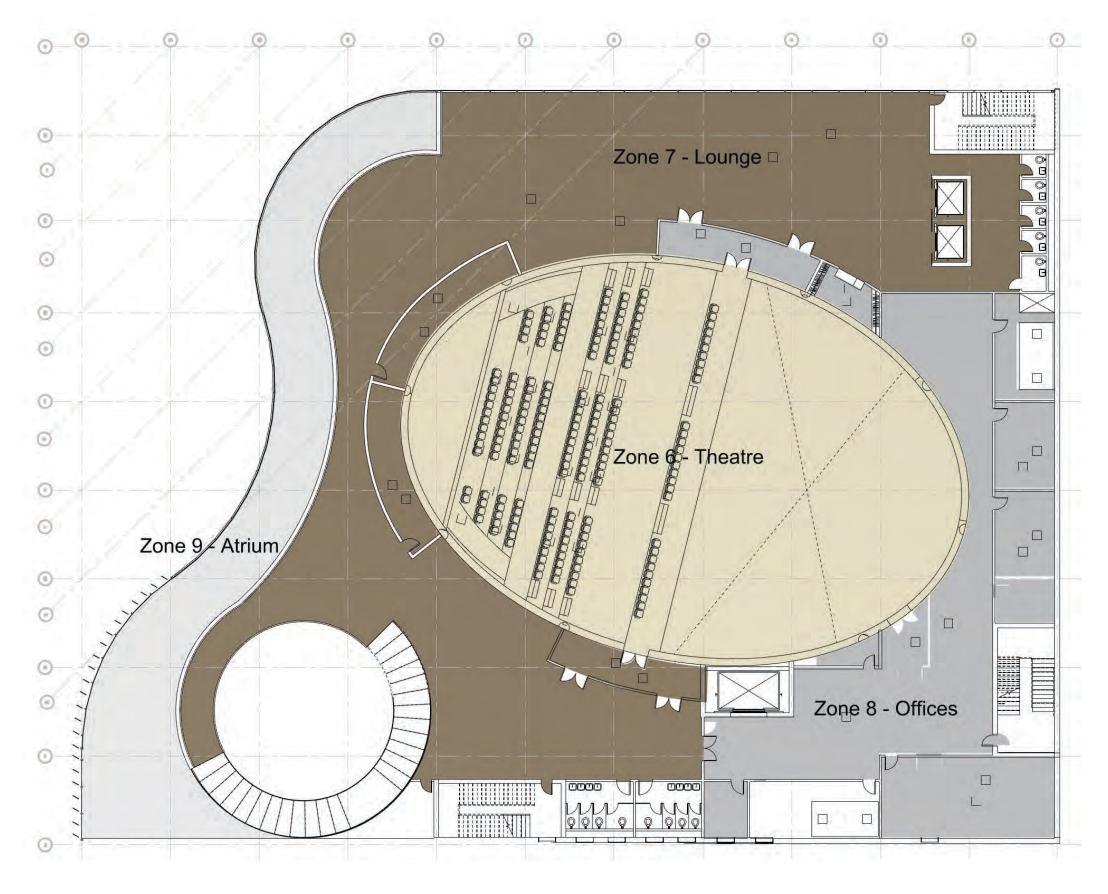


3: THIRD FLOOR PLAN HVAC ZONES

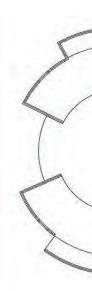

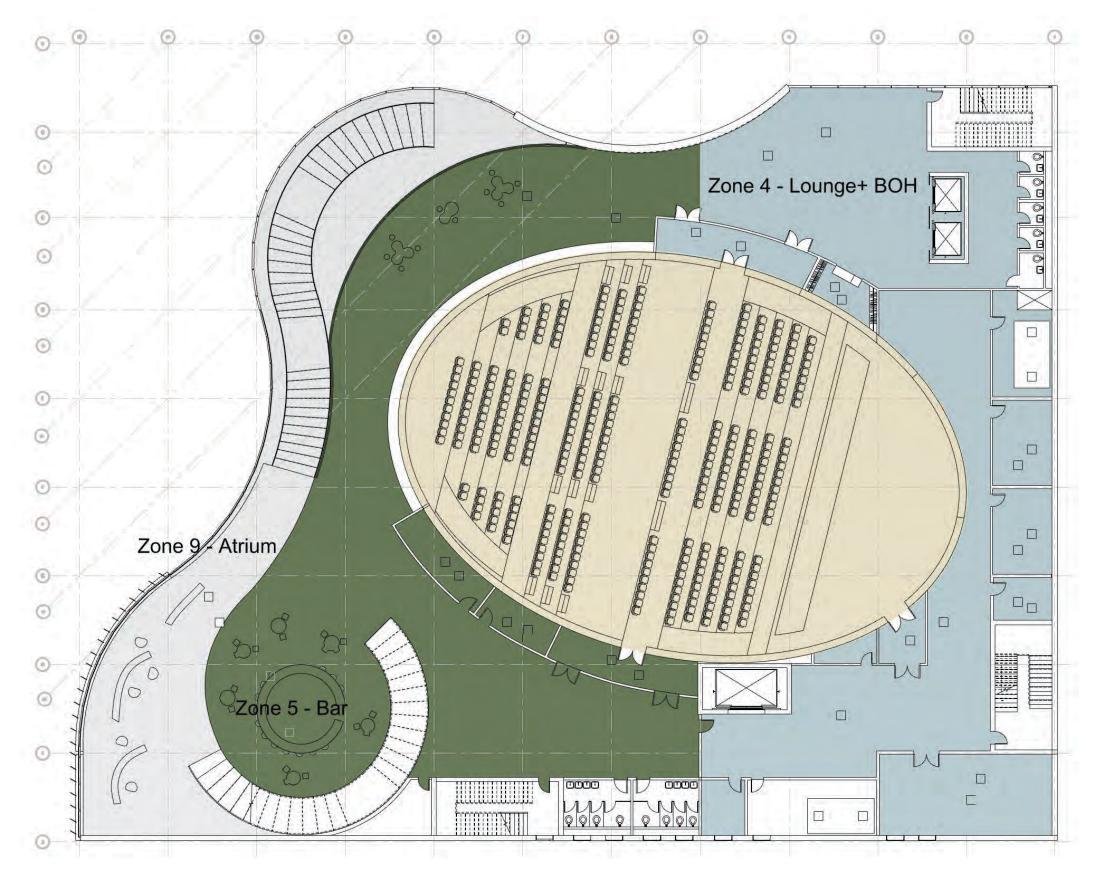

2: SECOND FLOOR PLAN HVAC ZONES

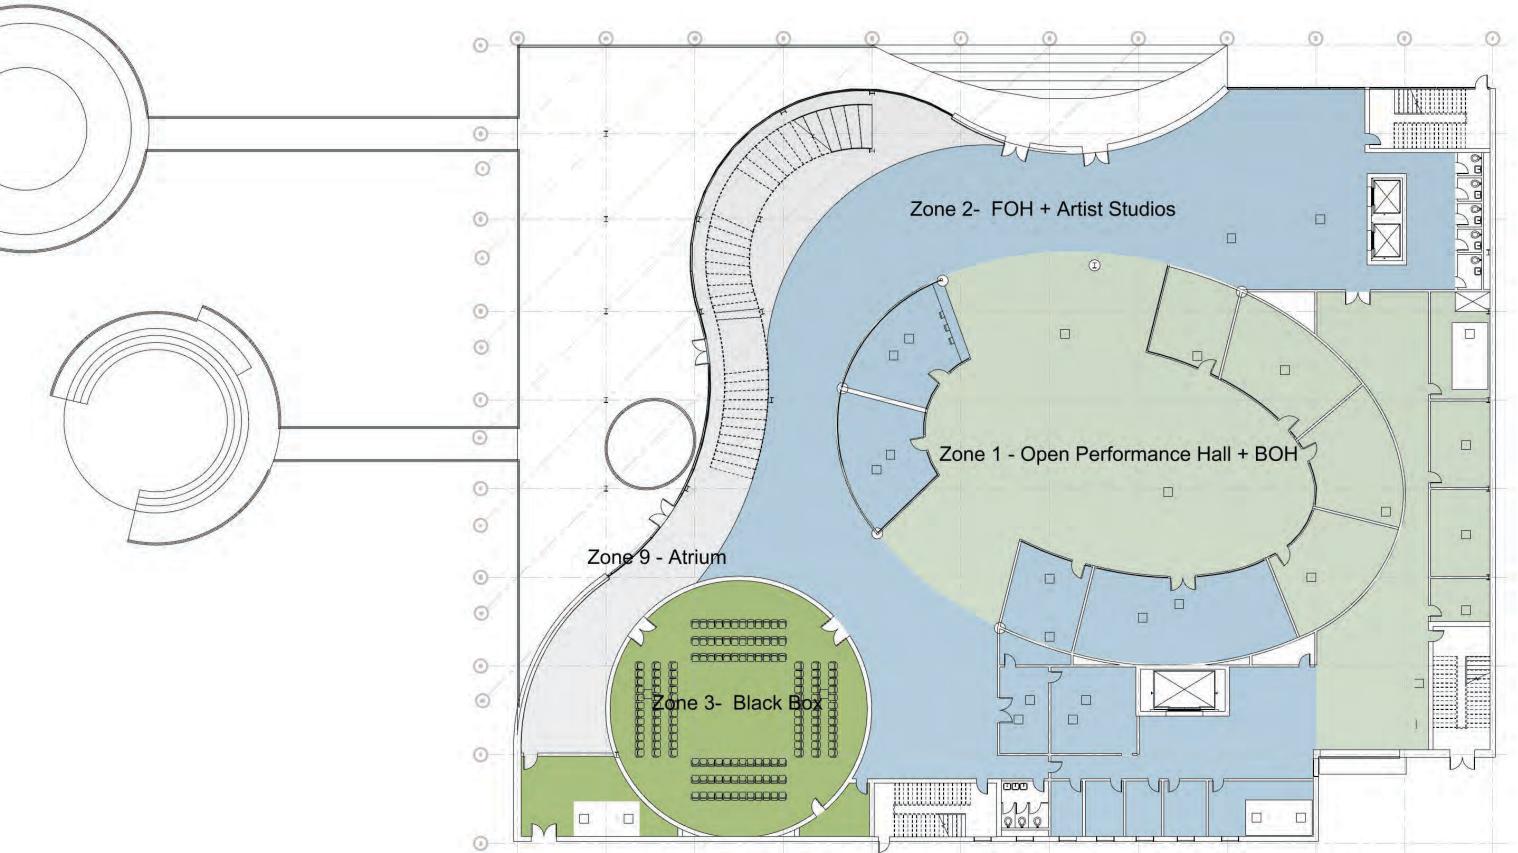

1: GROUND FLOOR PLAN HVAC ZONES



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MECHANICAL & SUSTAINABILITY

JONCE WALKER LEED AP CSBA Thornton Tomasetti, Inc. 51 Madison Ave New York, NY 10010

ENCLOSURE

KATHERINE CHAN Walter P Moore 180 Maiden Ln #803 New York, NY 10038

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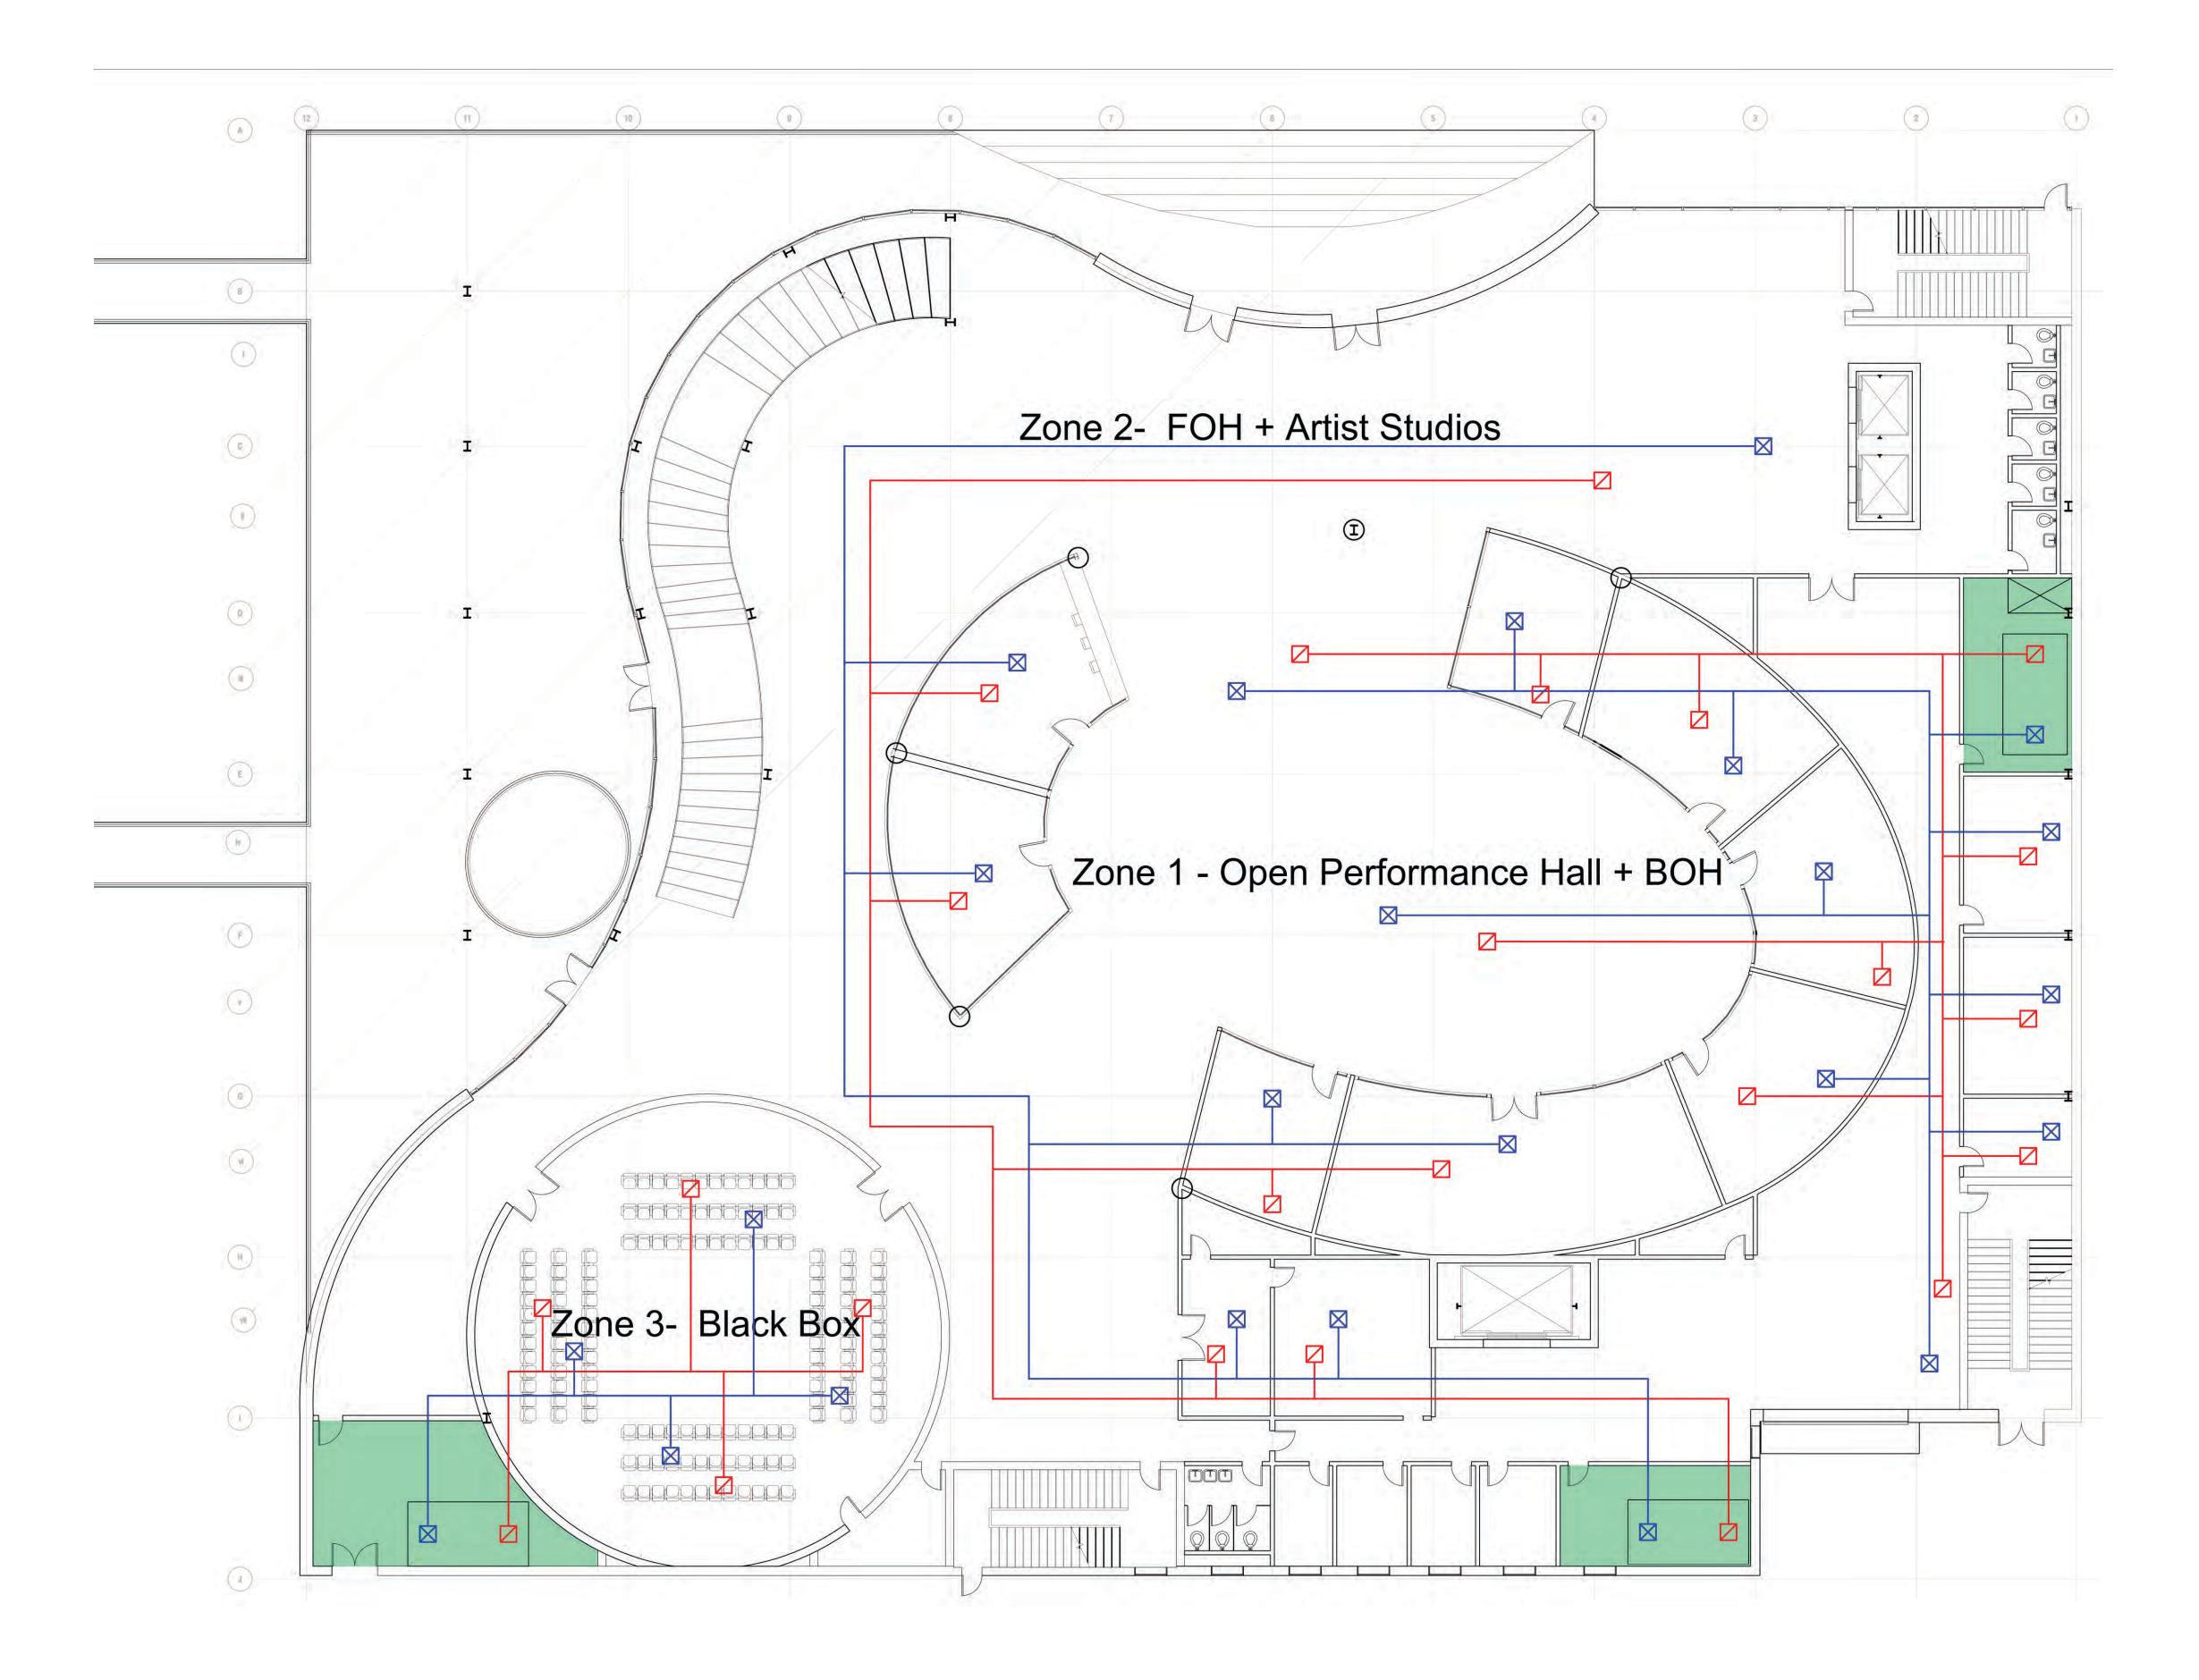
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> **PROJECT** Greenpoint Theater 18 Greenpoint Ave. Brooklyn, NY 11222

DRAWING TITLE HVAC Zone Diagrams

DRAWING SCALE

M101





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ADDRESS

Columbia University Graduate School of Architecture, Planning and Preservation 1172 Amsterdam Ave New York, NY 10027

PROJECT TEAM

ARCHITECTURE TECHNICAL CONSULTING

JOSEPH HAND Shop Architects 233 Broadway 11th Floor New York, NY 10279

STRUCTURAL AMY HARRINGTON PE Silman 32 Old Slip New York, NY 10005

MECHANICAL & SUSTAINABILITY

JONCE WALKER LEED AP CSBA Thornton Tomasetti, Inc. 51 Madison Ave New York, NY 10010

ENCLOSURE

KATHERINE CHAN Walter P Moore 180 Maiden Ln #803 New York, NY 10038

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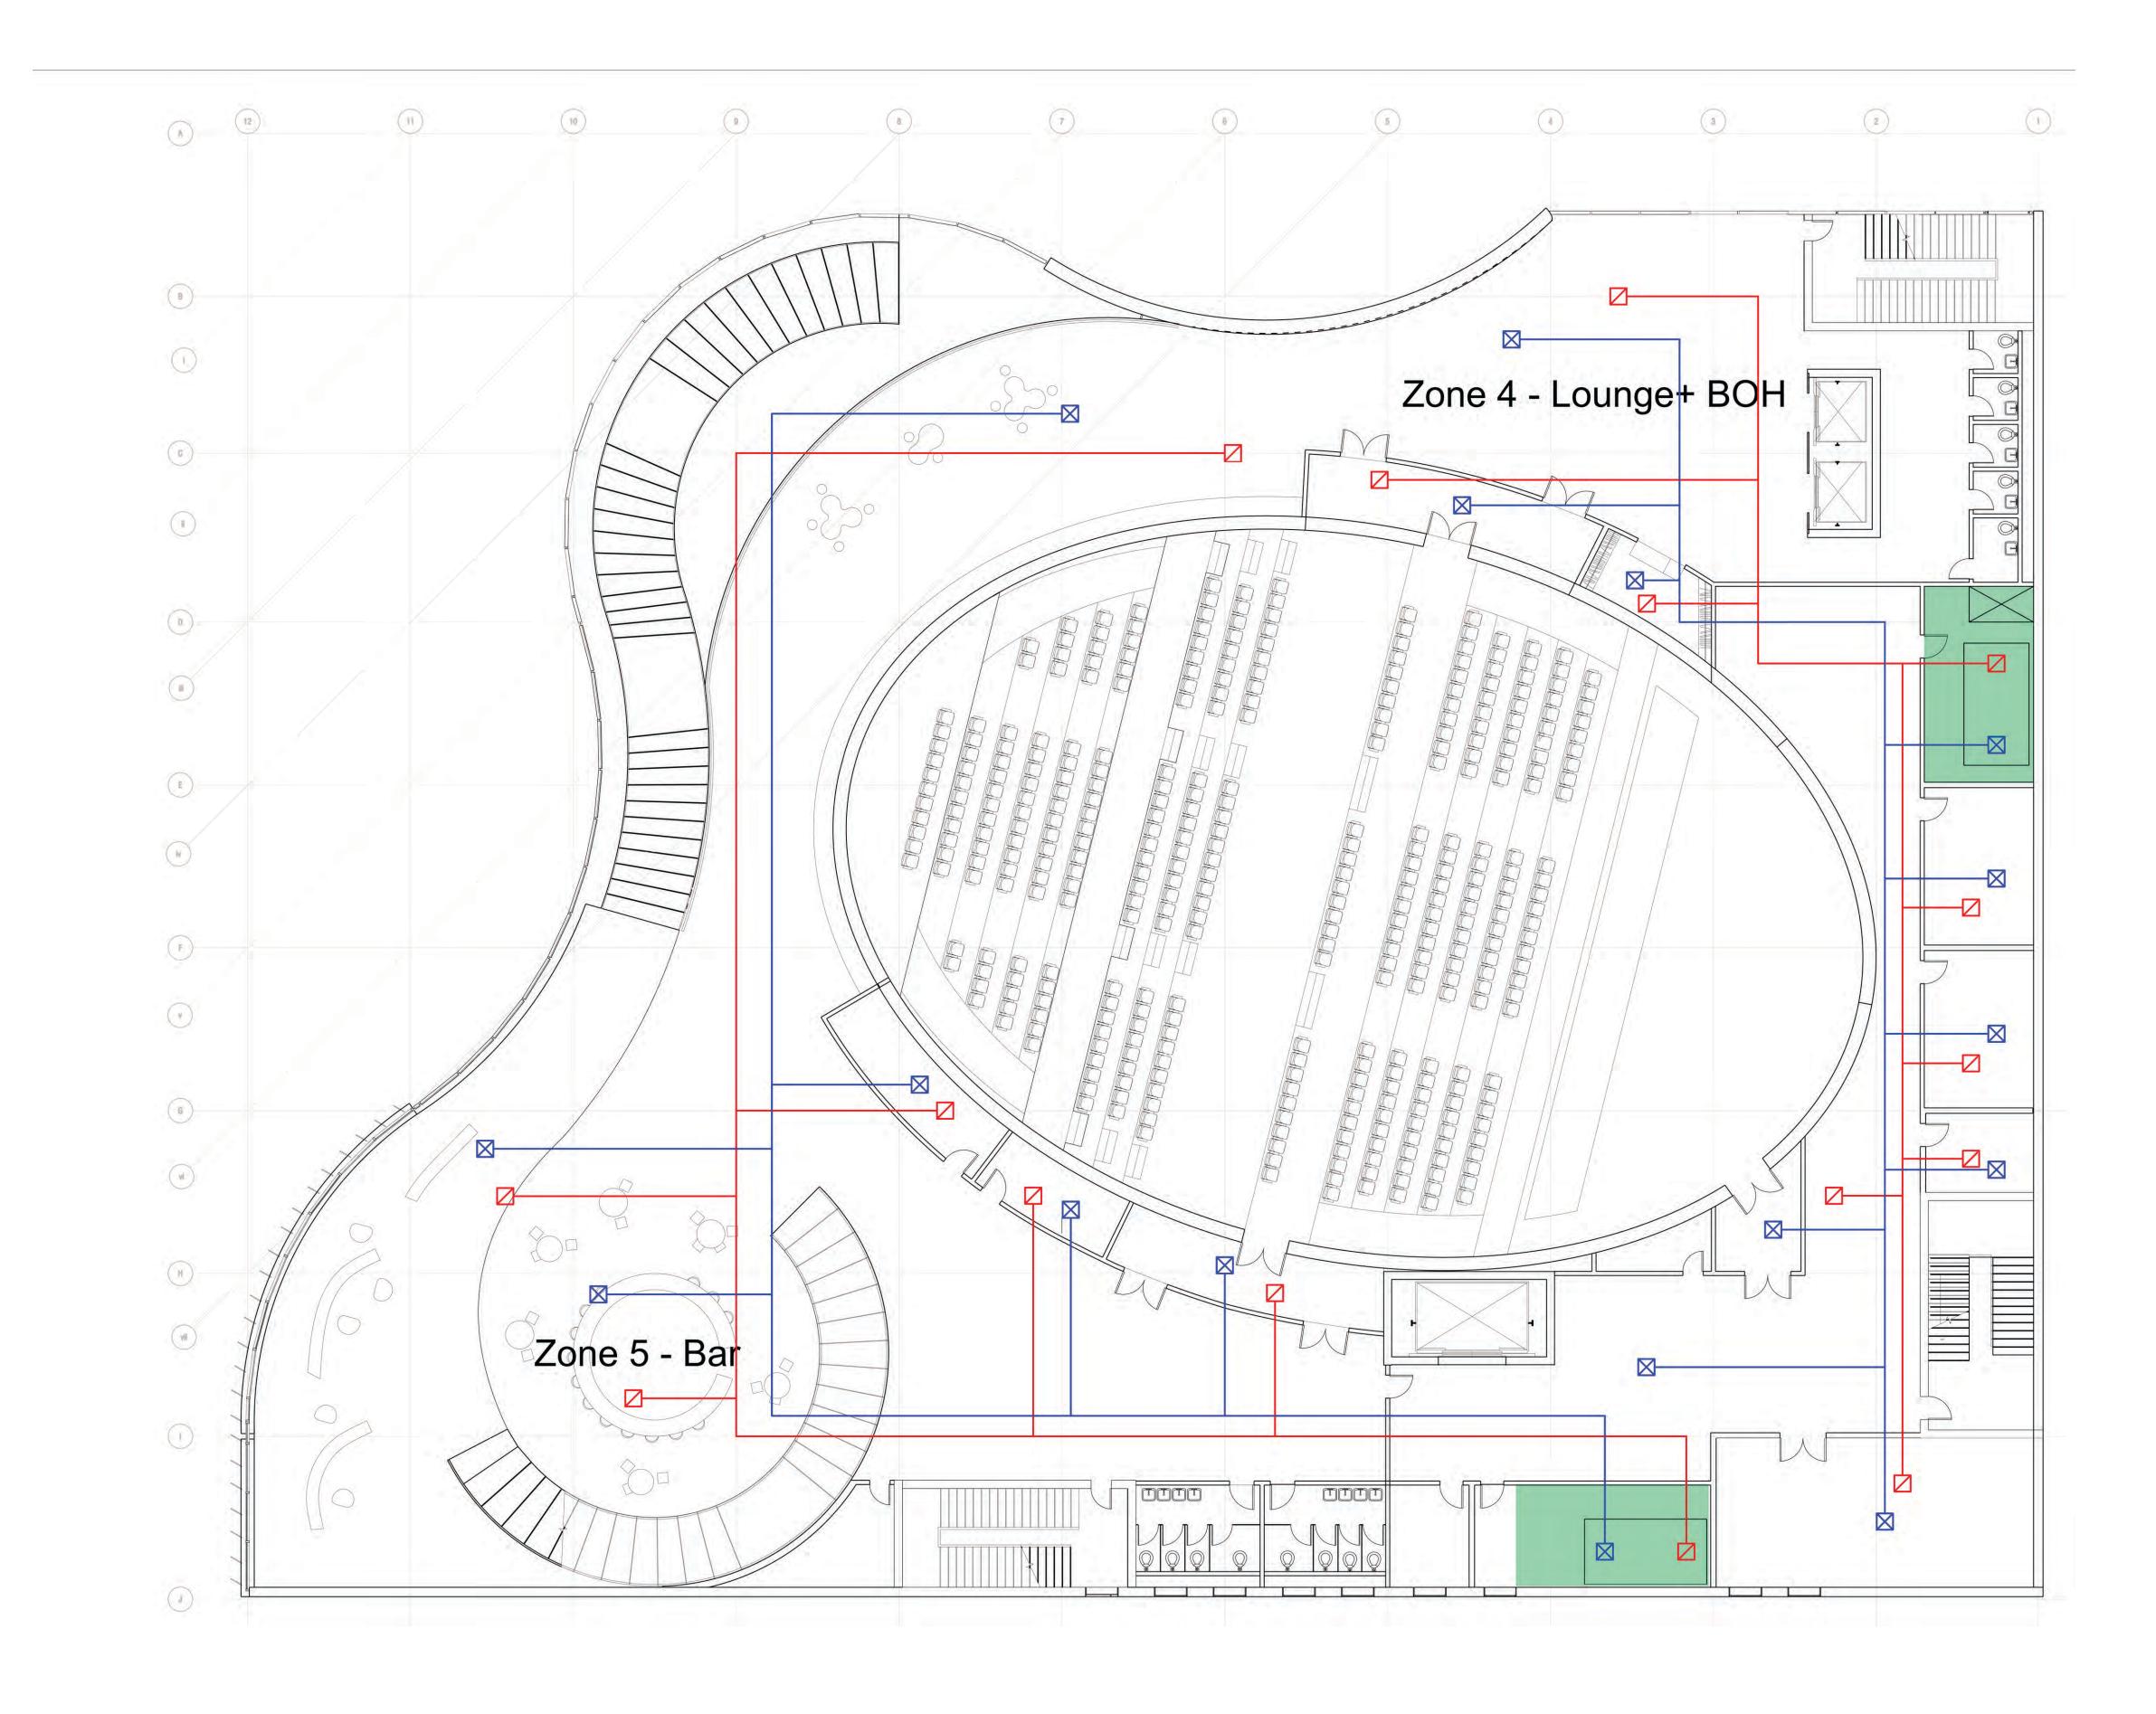
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> **PROJECT** Greenpoint Theater 18 Greenpoint Ave. Brooklyn, NY 11222

DRAWING TITLE Mechical Ground Floor Plan

> **DRAWING SCALE** 1' - 0" : 1/8"

M102





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ADDRESS

Columbia University Graduate School of Architecture, Planning and Preservation 1172 Amsterdam Ave New York, NY 10027

PROJECT TEAM

ARCHITECTURE TECHNICAL CONSULTING

JOSEPH HAND Shop Architects 233 Broadway 11th Floor New York, NY 10279

STRUCTURAL AMY HARRINGTON PE Silman 32 Old Slip New York, NY 10005

MECHANICAL & SUSTAINABILITY

JONCE WALKER LEED AP CSBA Thornton Tomasetti, Inc. 51 Madison Ave New York, NY 10010

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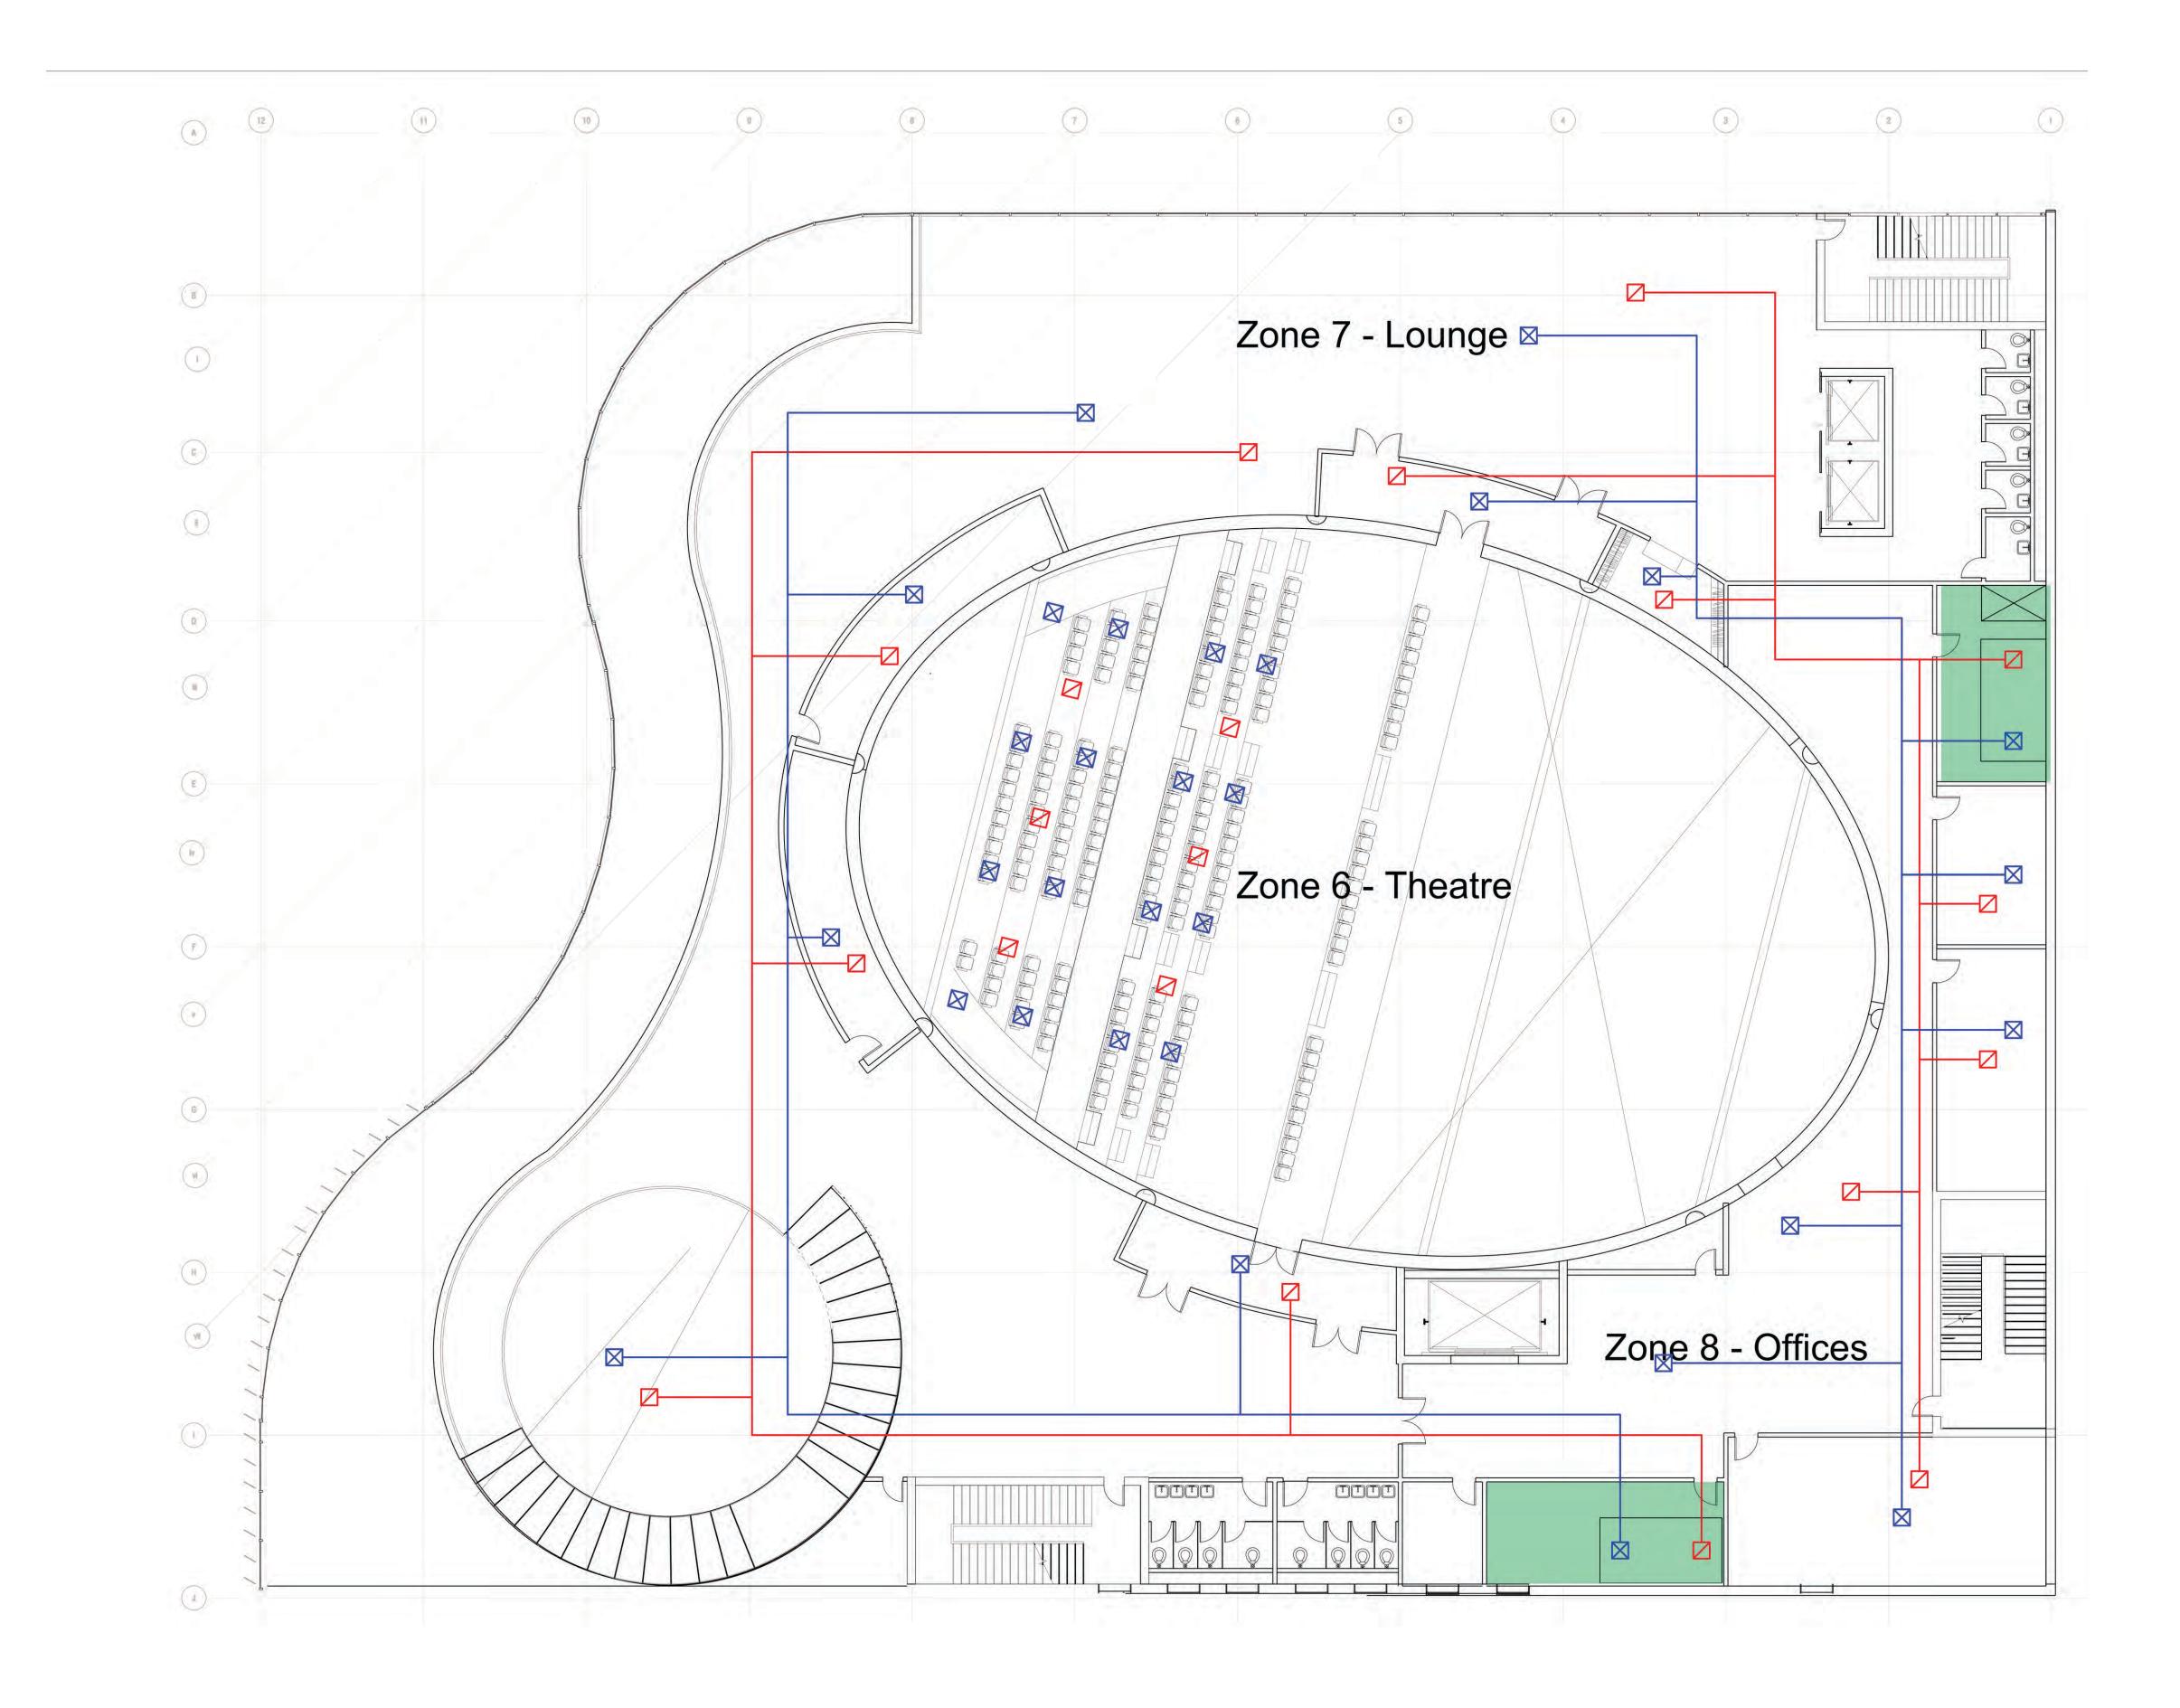
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> **PROJECT** Greenpoint Theater 18 Greenpoint Ave. Brooklyn, NY 11222

DRAWING TITLE Mechical Second Floor Plan

> **DRAWING SCALE** 1' - 0" : 1/8"

M103





DAVID MUSA - LUIS MIGUEL PIZANO - TIANYU YANG - REEM YASSIN

ADDRESS

Columbia University Graduate School of Architecture, Planning and Preservation 1172 Amsterdam Ave New York, NY 10027

PROJECT TEAM

ARCHITECTURE TECHNICAL CONSULTING

JOSEPH HAND Shop Architects 233 Broadway 11th Floor New York, NY 10279

STRUCTURAL AMY HARRINGTON PE Silman 32 Old Slip New York, NY 10005

MECHANICAL & SUSTAINABILITY

JONCE WALKER LEED AP CSBA Thornton Tomasetti, Inc. 51 Madison Ave New York, NY 10010

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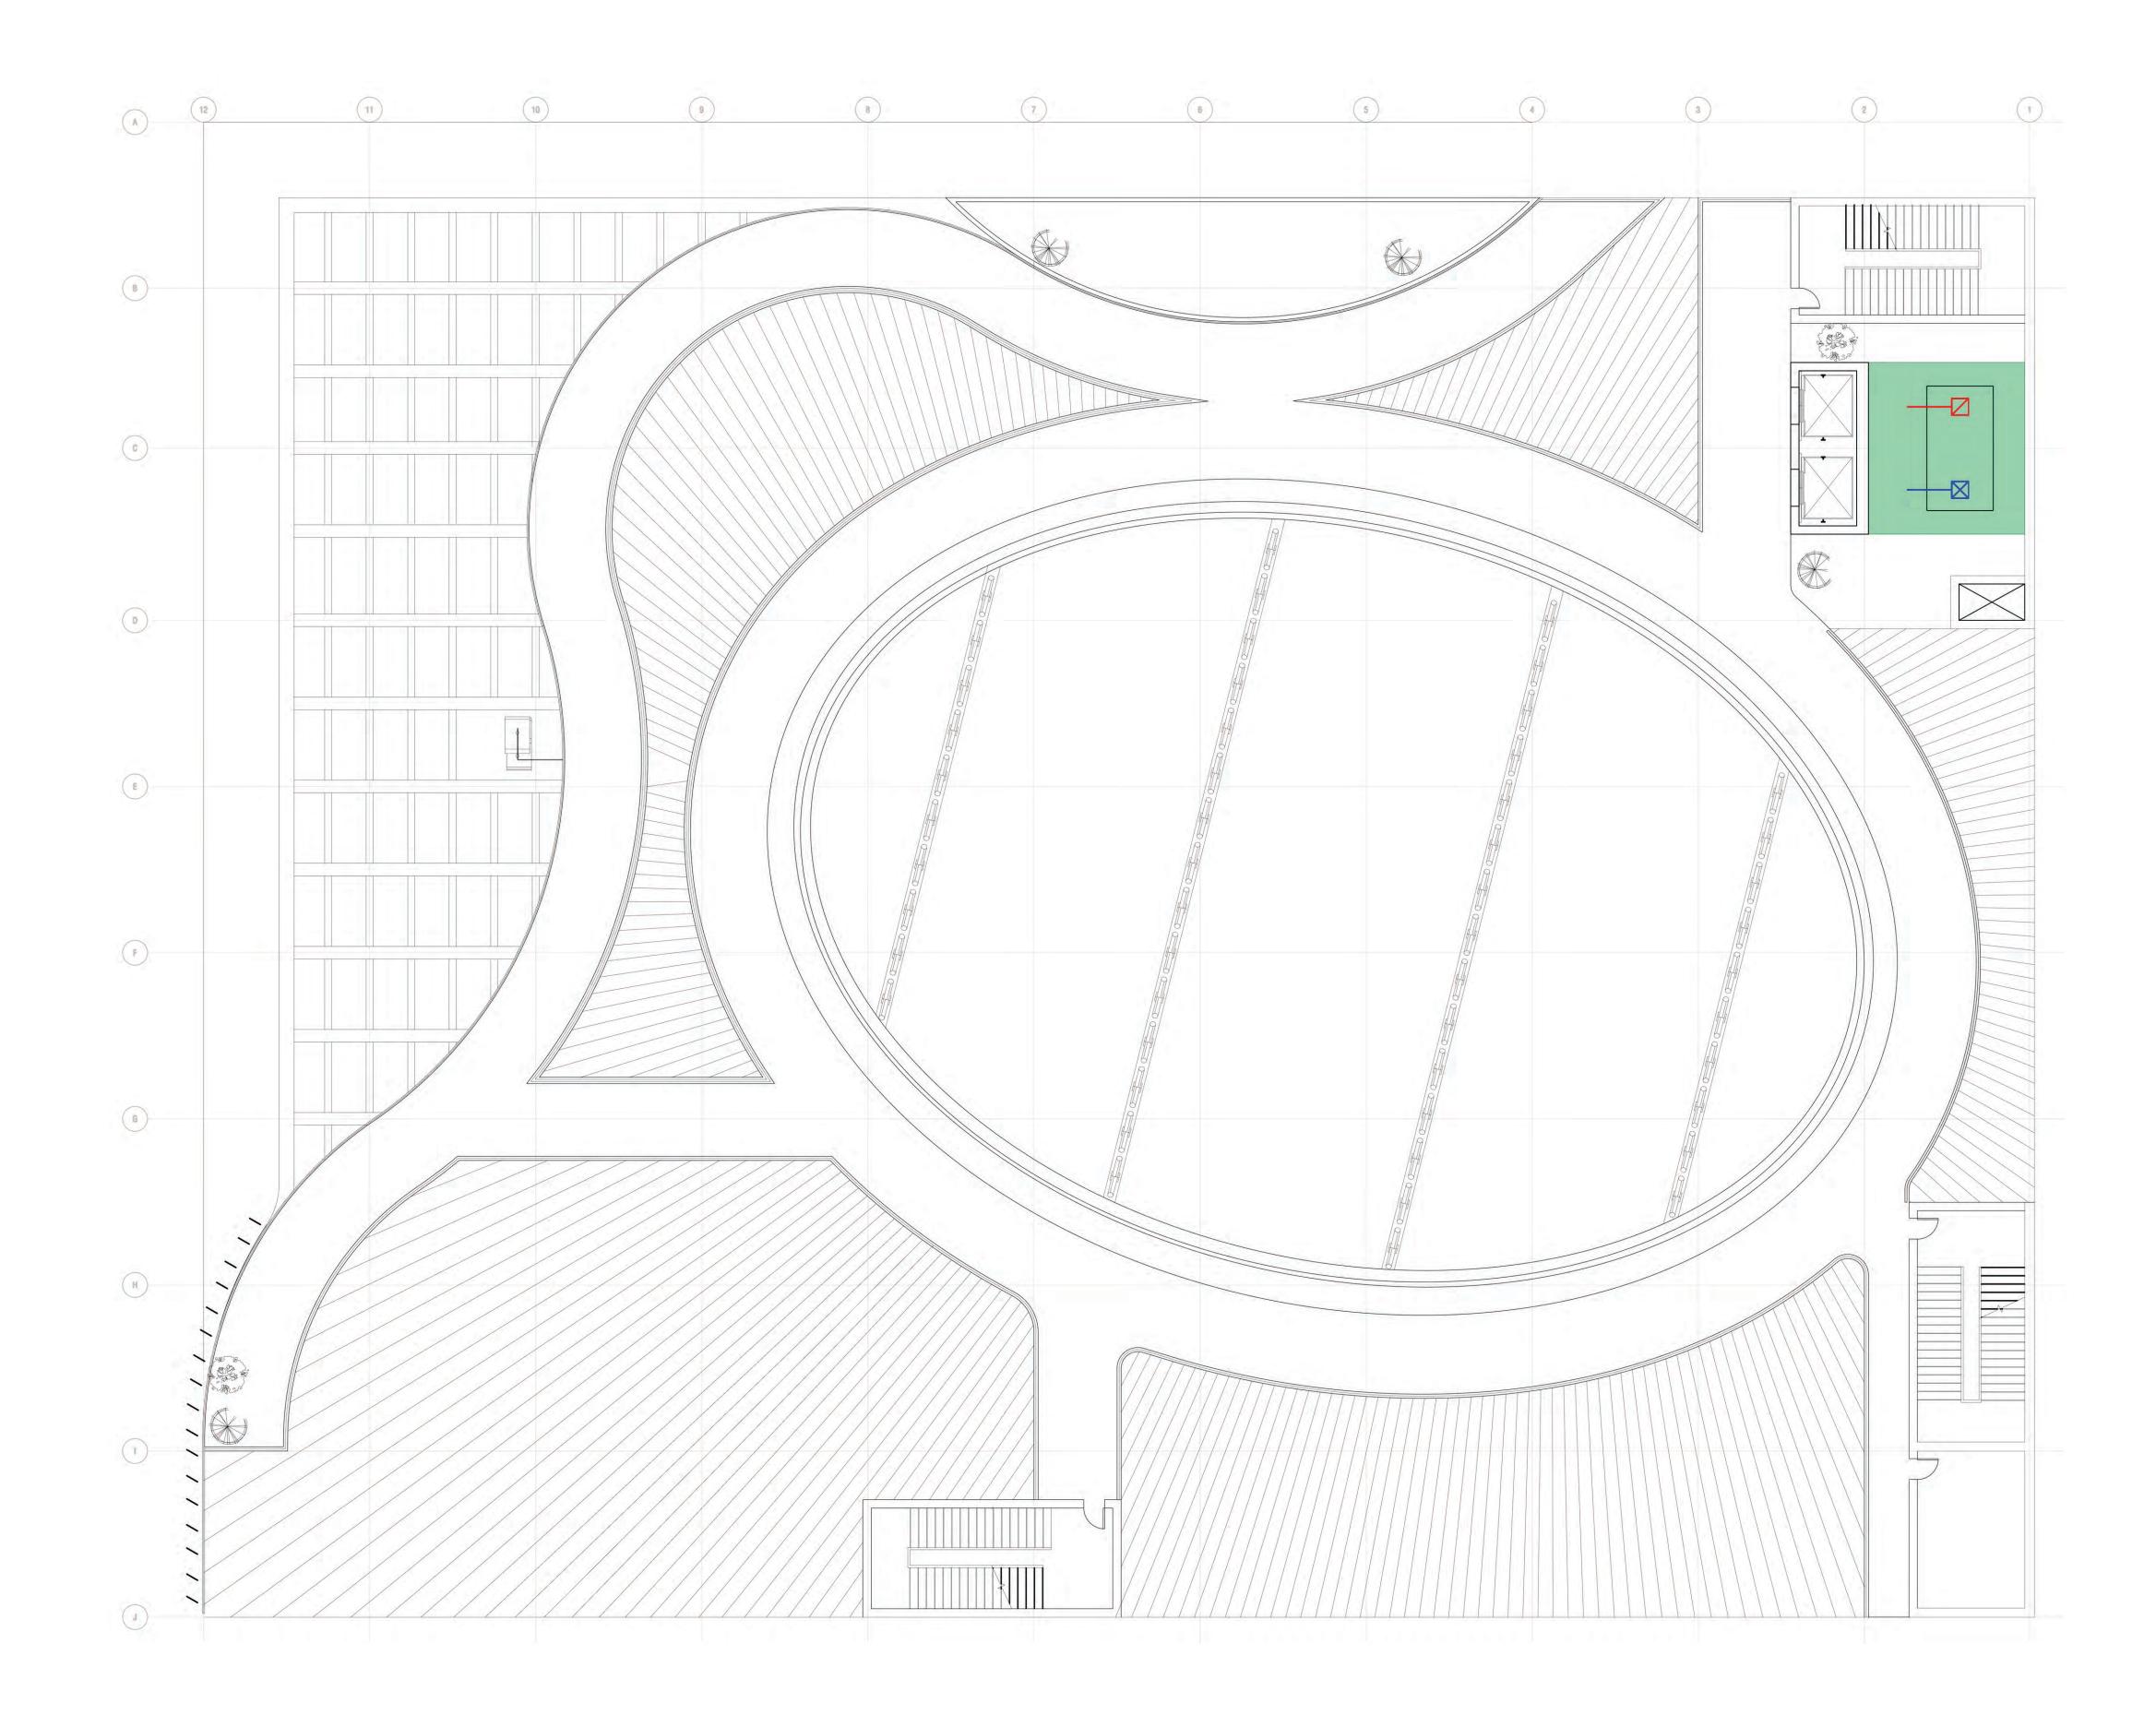
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> **PROJECT** Greenpoint Theater 18 Greenpoint Ave. Brooklyn, NY 11222

DRAWING TITLE Mechical Third Floor Plan

> **DRAWING SCALE** 1' - 0" : 1/8"

M104



()



THE CEILING-TO-FLOOR DESIGN GROUP

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ADDRESS

Columbia University Graduate School of Architecture, Planning and Preservation 1172 Amsterdam Ave New York, NY 10027

PROJECT TEAM

ARCHITECTURE TECHNICAL CONSULTING

JOSEPH HAND Shop Architects 233 Broadway 11th Floor New York, NY 10279

STRUCTURAL AMY HARRINGTON PE Silman 32 Old Slip New York, NY 10005

MECHANICAL & SUSTAINABILITY

JONCE WALKER LEED AP CSBA Thornton Tomasetti, Inc. 51 Madison Ave New York, NY 10010

ENCLOSURE KATHERINE CHAN

Walter P Moore 180 Maiden Ln #803 New York, NY 10038

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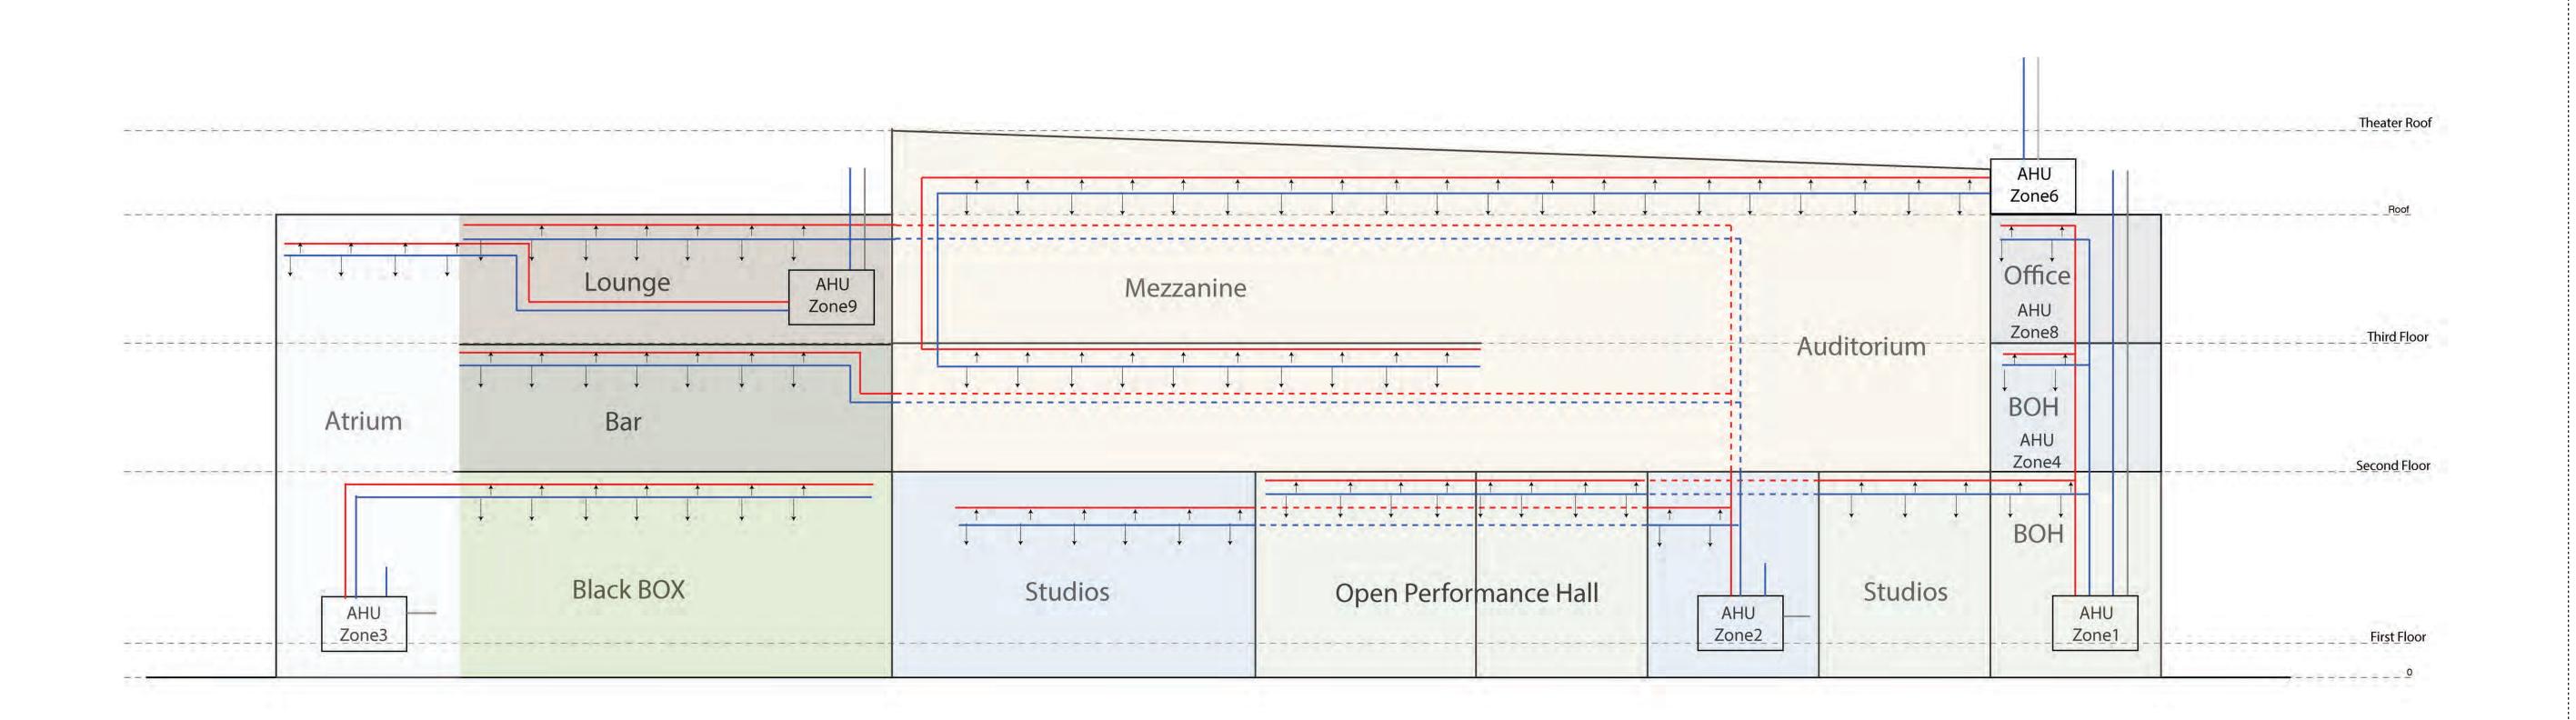
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PROJECT Greenpoint Theater

18 Greenpoint Ave. Brooklyn, NY 11222

DRAWING TITLE Mechical Roof Plan

DRAWING SCALE 1' - 0" : 1/8" M105





Air	AHU	



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ADDRESS

Columbia University Graduate School of Architecture, Planning and Preservation 1172 Amsterdam Ave New York, NY 10027

PROJECT TEAM

ARCHITECTURE TECHNICAL CONSULTING

JOSEPH HAND Shop Architects 233 Broadway 11th Floor New York, NY 10279

STRUCTURAL AMY HARRINGTON PE Silman 32 Old Slip New York, NY 10005

MECHANICAL & SUSTAINABILITY

JONCE WALKER LEED AP CSBA Thornton Tomasetti, Inc. 51 Madison Ave New York, NY 10010

ENCLOSURE KATHERINE CHAN

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PROJECT

Greenpoint Theater 18 Greenpoint Ave. Brooklyn, NY 11222

DRAWING TITLE Air Riser Diagram

DRAWING SCALE 1' - 0" : 1/8" M106

		Filtered Rainwater					Domestic Water Heating
	Lounge		Mezzanine	RR		Auditovium	Office
Atriu	F	Bar Kitchen		RR		Auditorium	BOH RR
	Black BOX		Studios	RR	Open Performance Hall	Studios	BOH
				Bathrooms			Bathroom

(0	old Water	Hot Water	Waste Wate
----	-----------	-----------	------------



DAVID MUSA - LUIS MIGUEL PIZANO - TIANYU YANG - REEM YASSIN

ADDRESS

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MECHANICAL & SUSTAINABILITY JONCE WALKER LEED AP CSBA

Thornton Tomasetti, Inc. 51 Madison Ave New York, NY 10010

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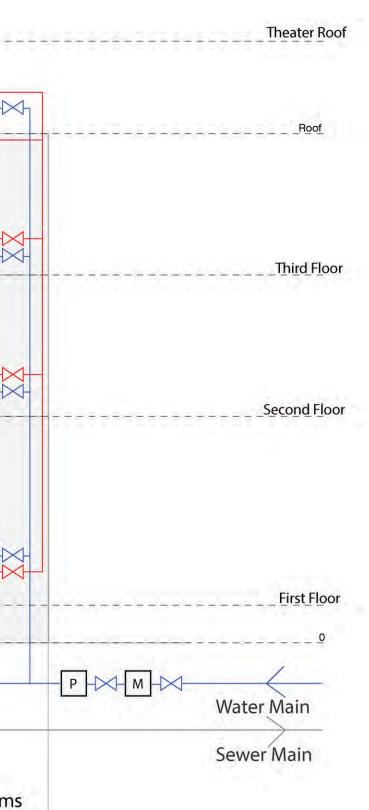
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> **PROJECT** Greenpoint Theater 18 Greenpoint Ave. Brooklyn, NY 11222

DRAWING TITLE Water Riser Diagram, Plumbing

DRAWING SCALE 1' - 0" : 1/8"

ISSUE DATE December 13, 2019 M107



						AHU Domest Zone6 Hea
	Lounge AHU Zone9	Mezzanine				Office AHU Zone8
	Atrium Bar			A	uditorium	BOH AHU Zone4
						вон
East River	AHU Zone3 WSHP	Studios	Open Performance Hall	AHU Zone2	Studios	AHU Zone1





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ENCLOSURE KATHERINE CHAN

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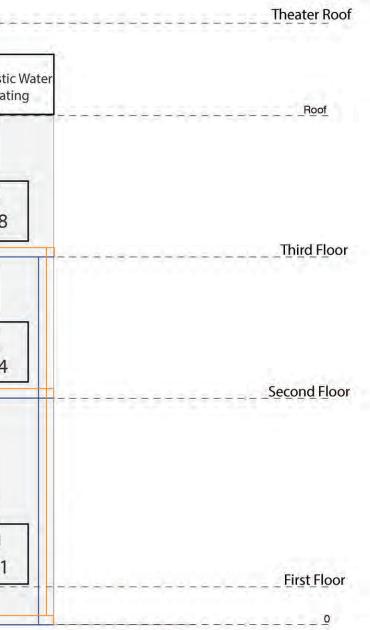
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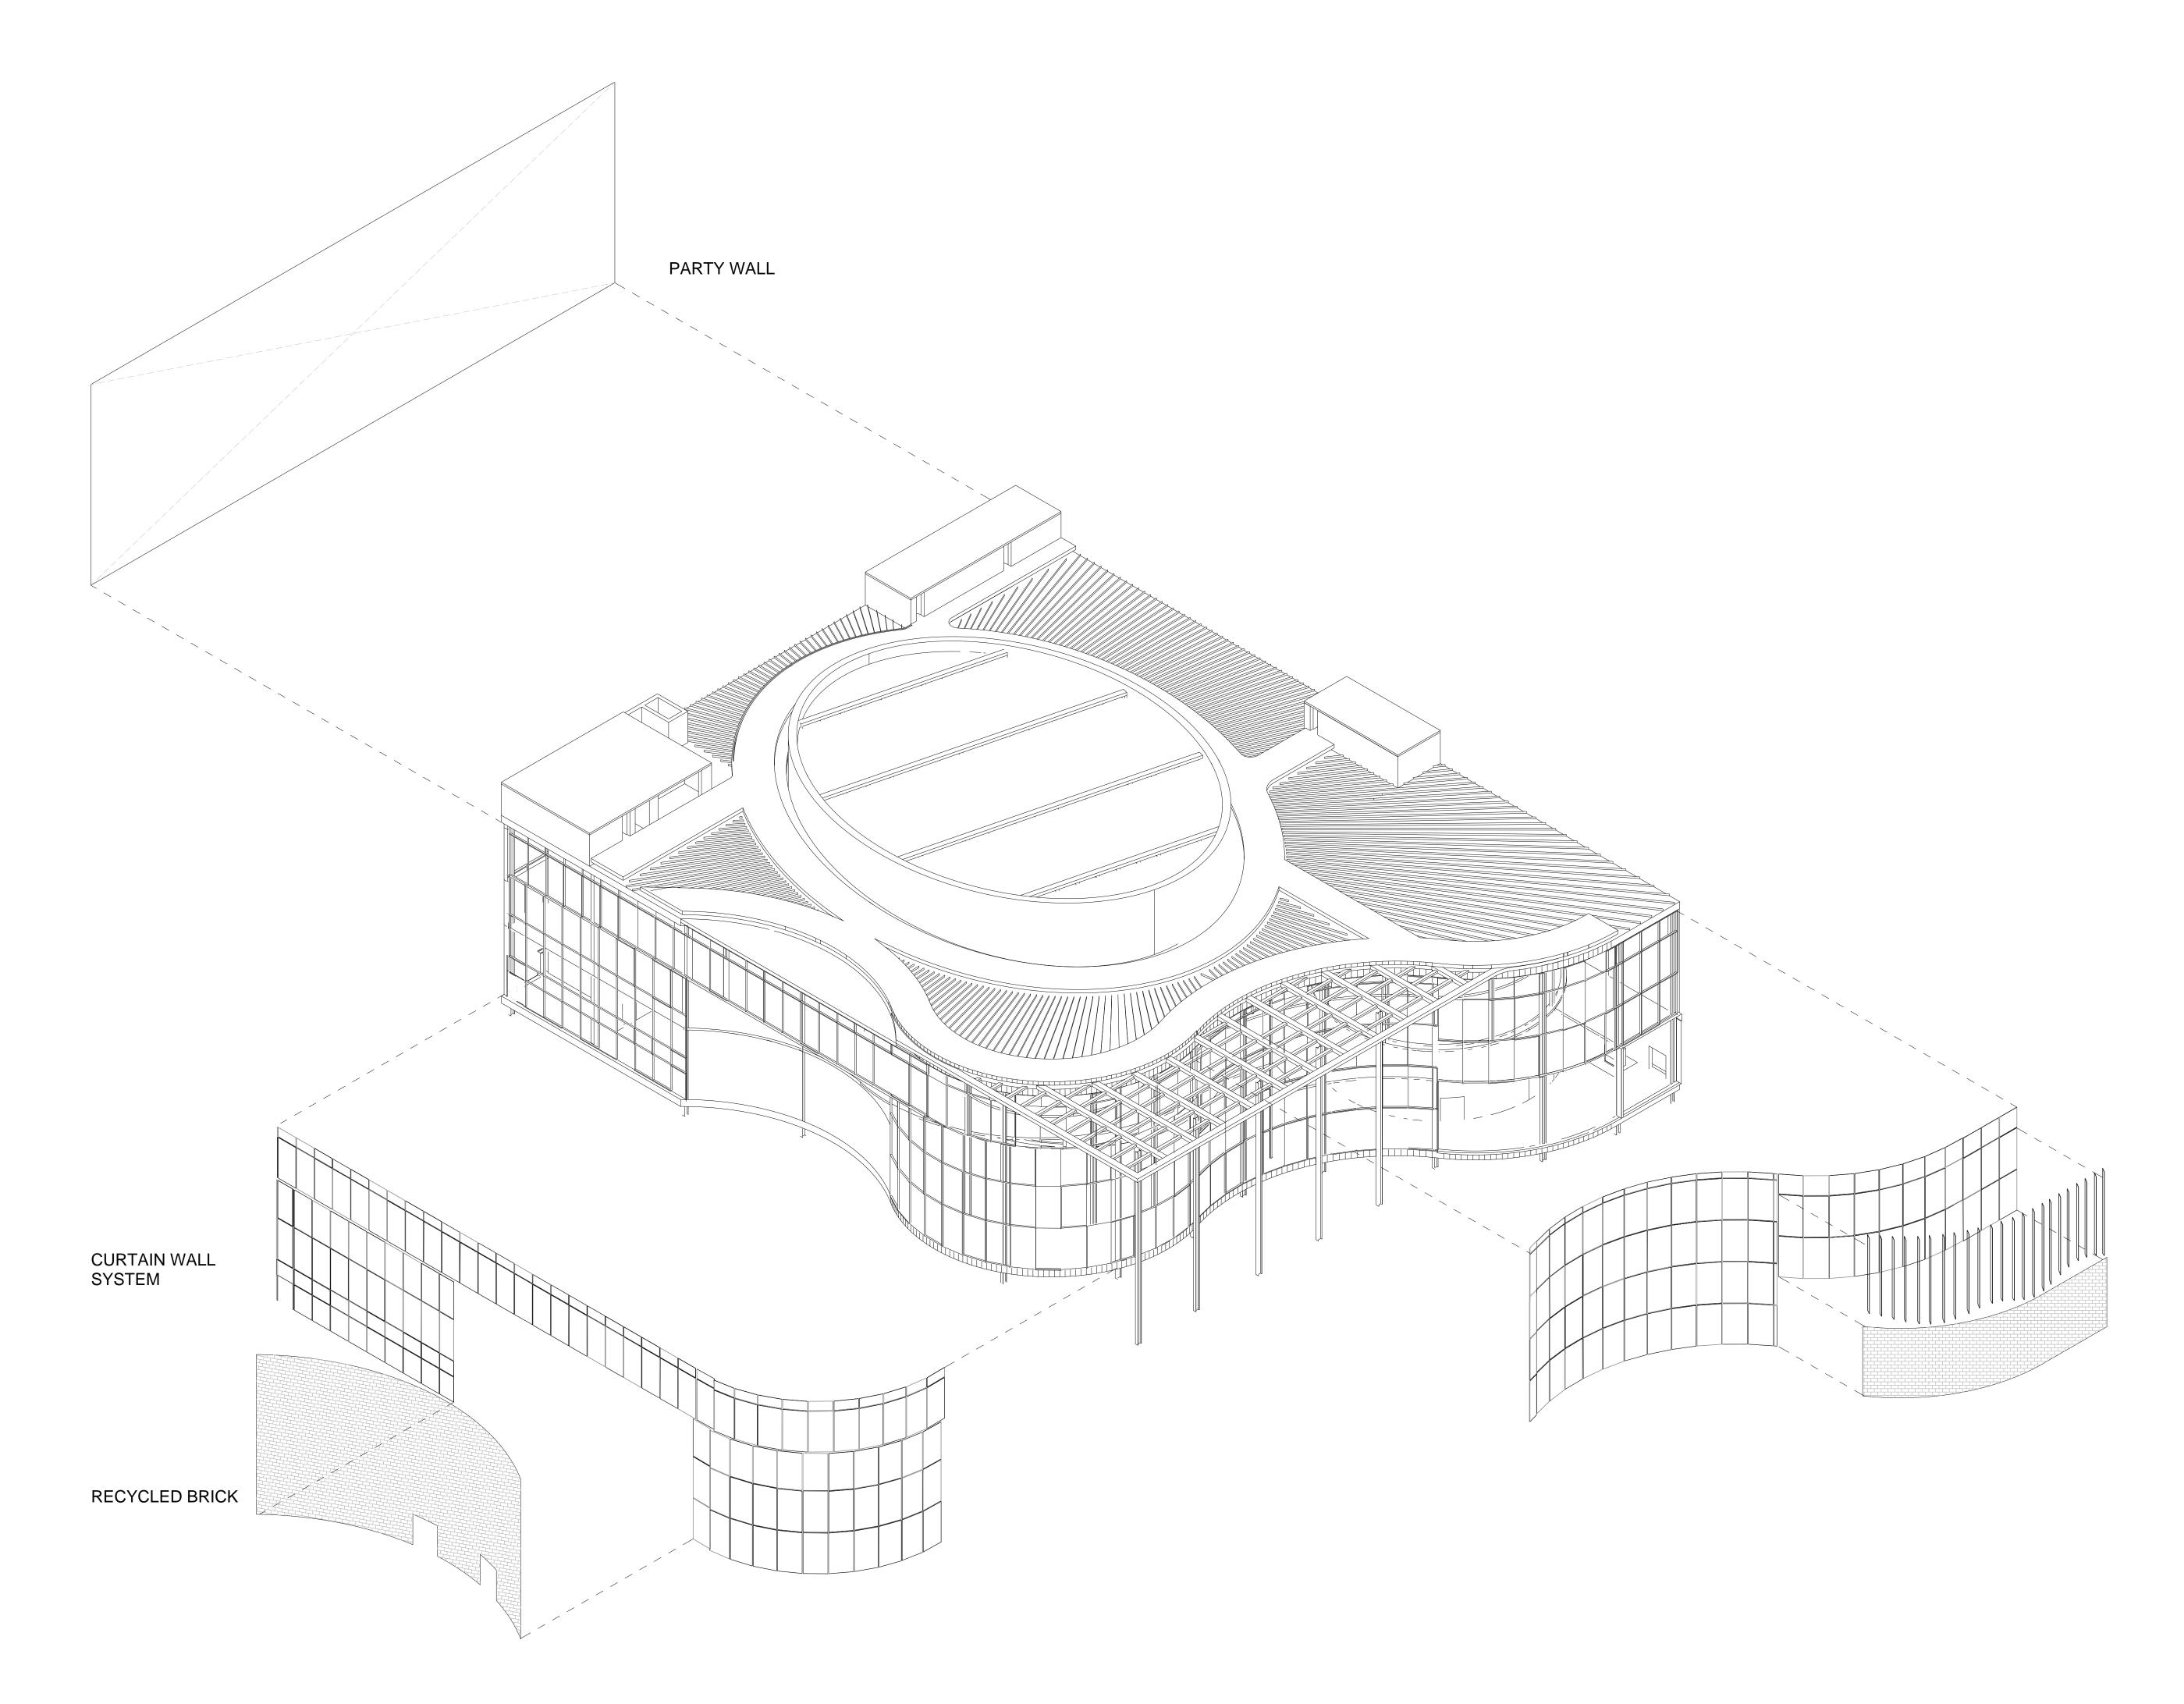
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MECHANICAL & SUSTAINABILITY

JONCE WALKER LEED AP CSBA Thornton Tomasetti, Inc. 51 Madison Ave New York, NY 10010

ENCLOSURE

KATHERINE CHAN Walter P Moore 180 Maiden Ln #803 New York, NY 10038

100% CURTAIN WALL SYSTEM DOCUMENTS

PRELIMINARY, SOLAR SHADIN**GOT FOR CONSTRUCTION** \$YSTEM

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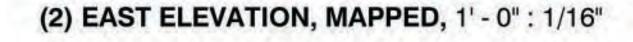
PROJECT Greenpoint Theater 18 Greenpoint Ave. Brooklyn, NY 11222


DRAWING TITLE Enclosure Systems, Axonometric Drawing


DRAWING SCALE Various

ISSUE DATE December 13, 2019

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Schedule - Wall Types Used								
Family	Туре	Width	Count	Area	Length			
Curtain Wall	Curtain Wall - Pods		3	1031.59 SF	58 LF			
Curtain Wall	Curtain Wall - Pods 2		13	4376.84 SF	231 LF			
Basic Wall	Exterior - Brick and CMU on MTL. Stud	1' - 1 7/8"	2	1860.28 SF	19 LF			
Basic Wall	Exterior - Brick on CMU	1' - 7 1/2"	6	15023.42 SF	173 LF			
Basic Wall	Exterior - Brick on CMU THIN	1' - 1 7/8"	5	20643.87 SF	889 LF			
Basic Wall	Exterior - CMU on Mtl. Stud	1' - 5 7/8"	4	679.72 SF	74 LF			
Curtain Wall	Exterior Glazing - Sample		7	13944.10 SF	502 LF			
Basic Wall	Foundation - 12" Concrete	1' - 0"	19	40694.60 SF	636 LF			
Basic Wall	Generic - 2"	0' - 2"	2	125.51 SF	20 LF			
Basic Wall	Generic - 6"	0' - 6"	97	32102.60 SF	1933 LF			
Basic Wall	Generic - 8"	0' - 8"	20	4504.77 SF	315 LF			
Basic Wall	Generic - 12"	1' - 0"	4	1212.92 SF	63 LF			
Basic Wall	Generic - Toilet Partition	0' - 0 3/8"	19	1970.46 SF	163 LF			
Basic Wall	Interior - 12" Partition (2-hr)	1' - 0 1/8"	7	3971.12 SF	204 LF			
Grand total			208	142141.79 SF	5279 LF			

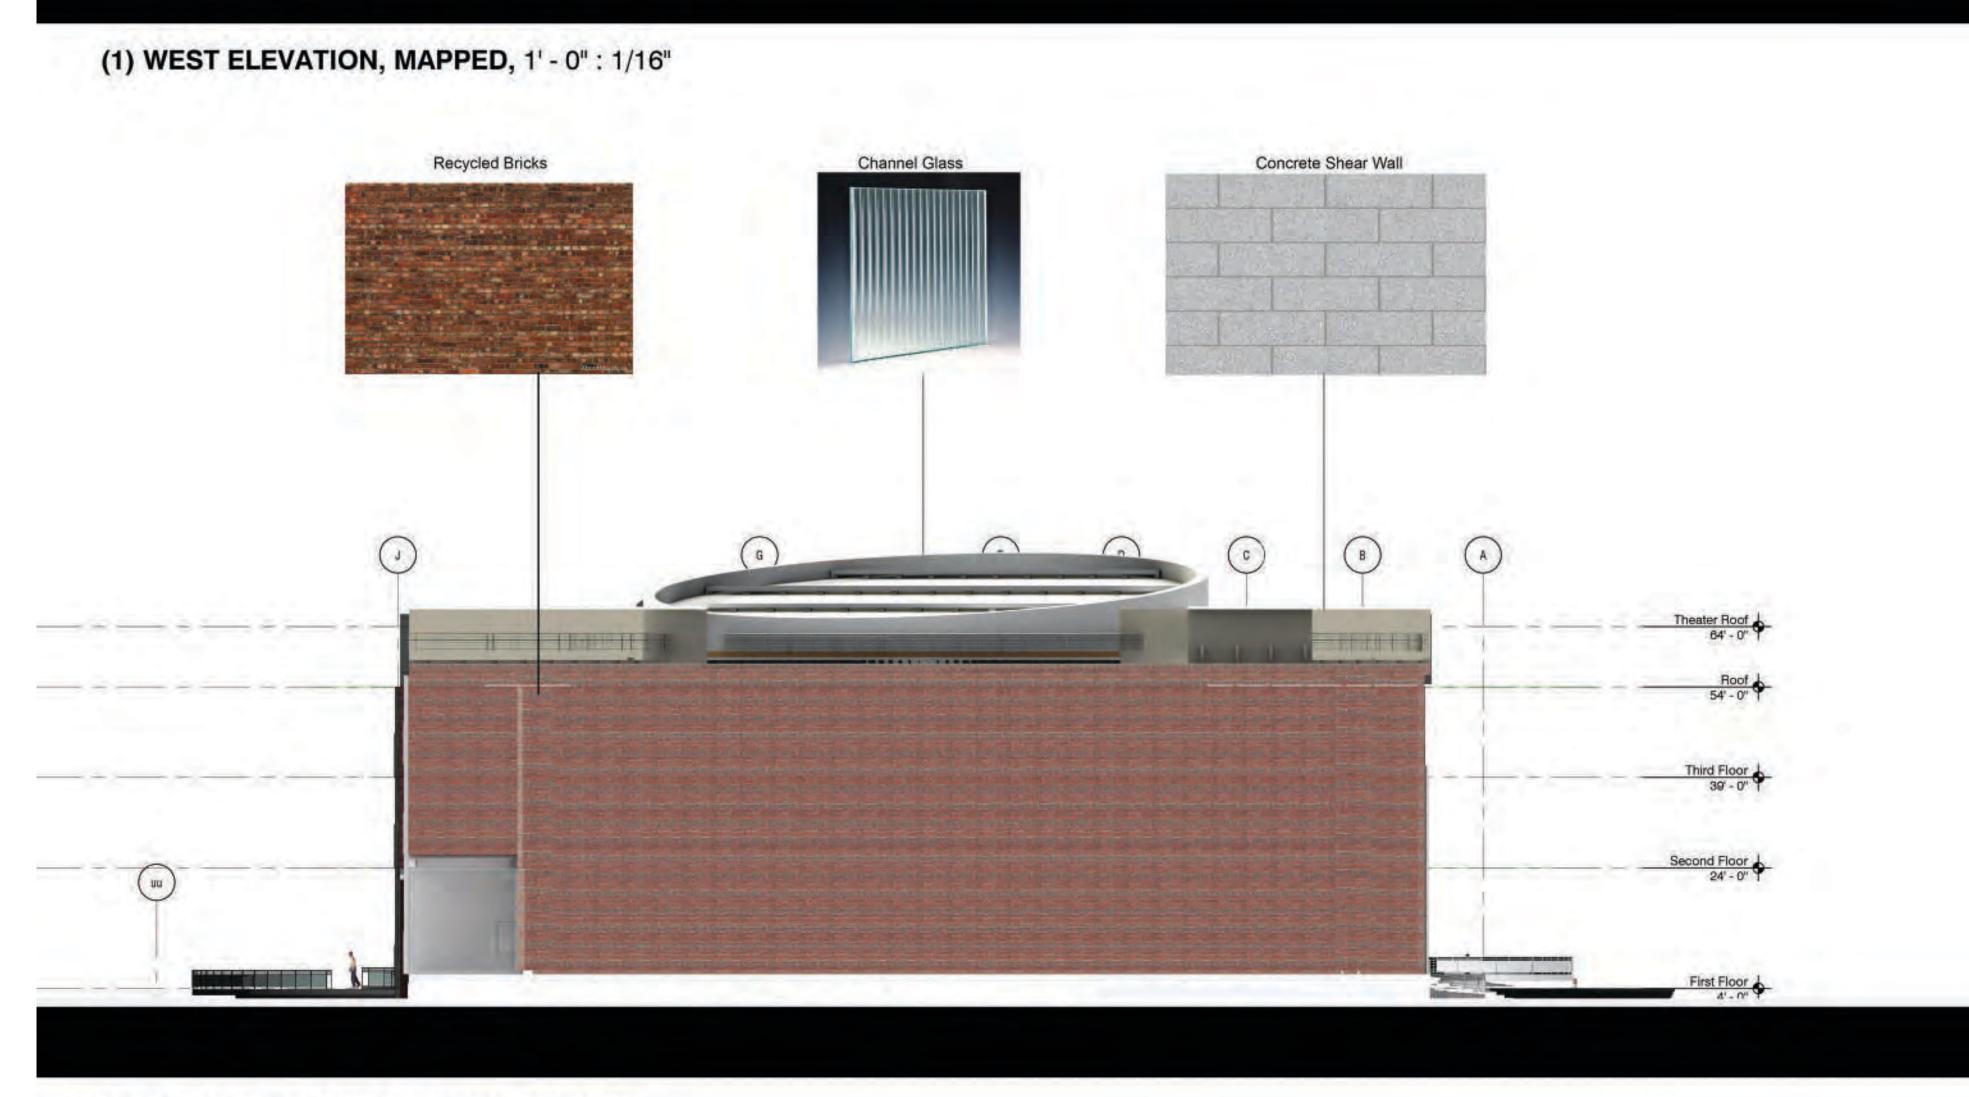

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STRUCTURAL
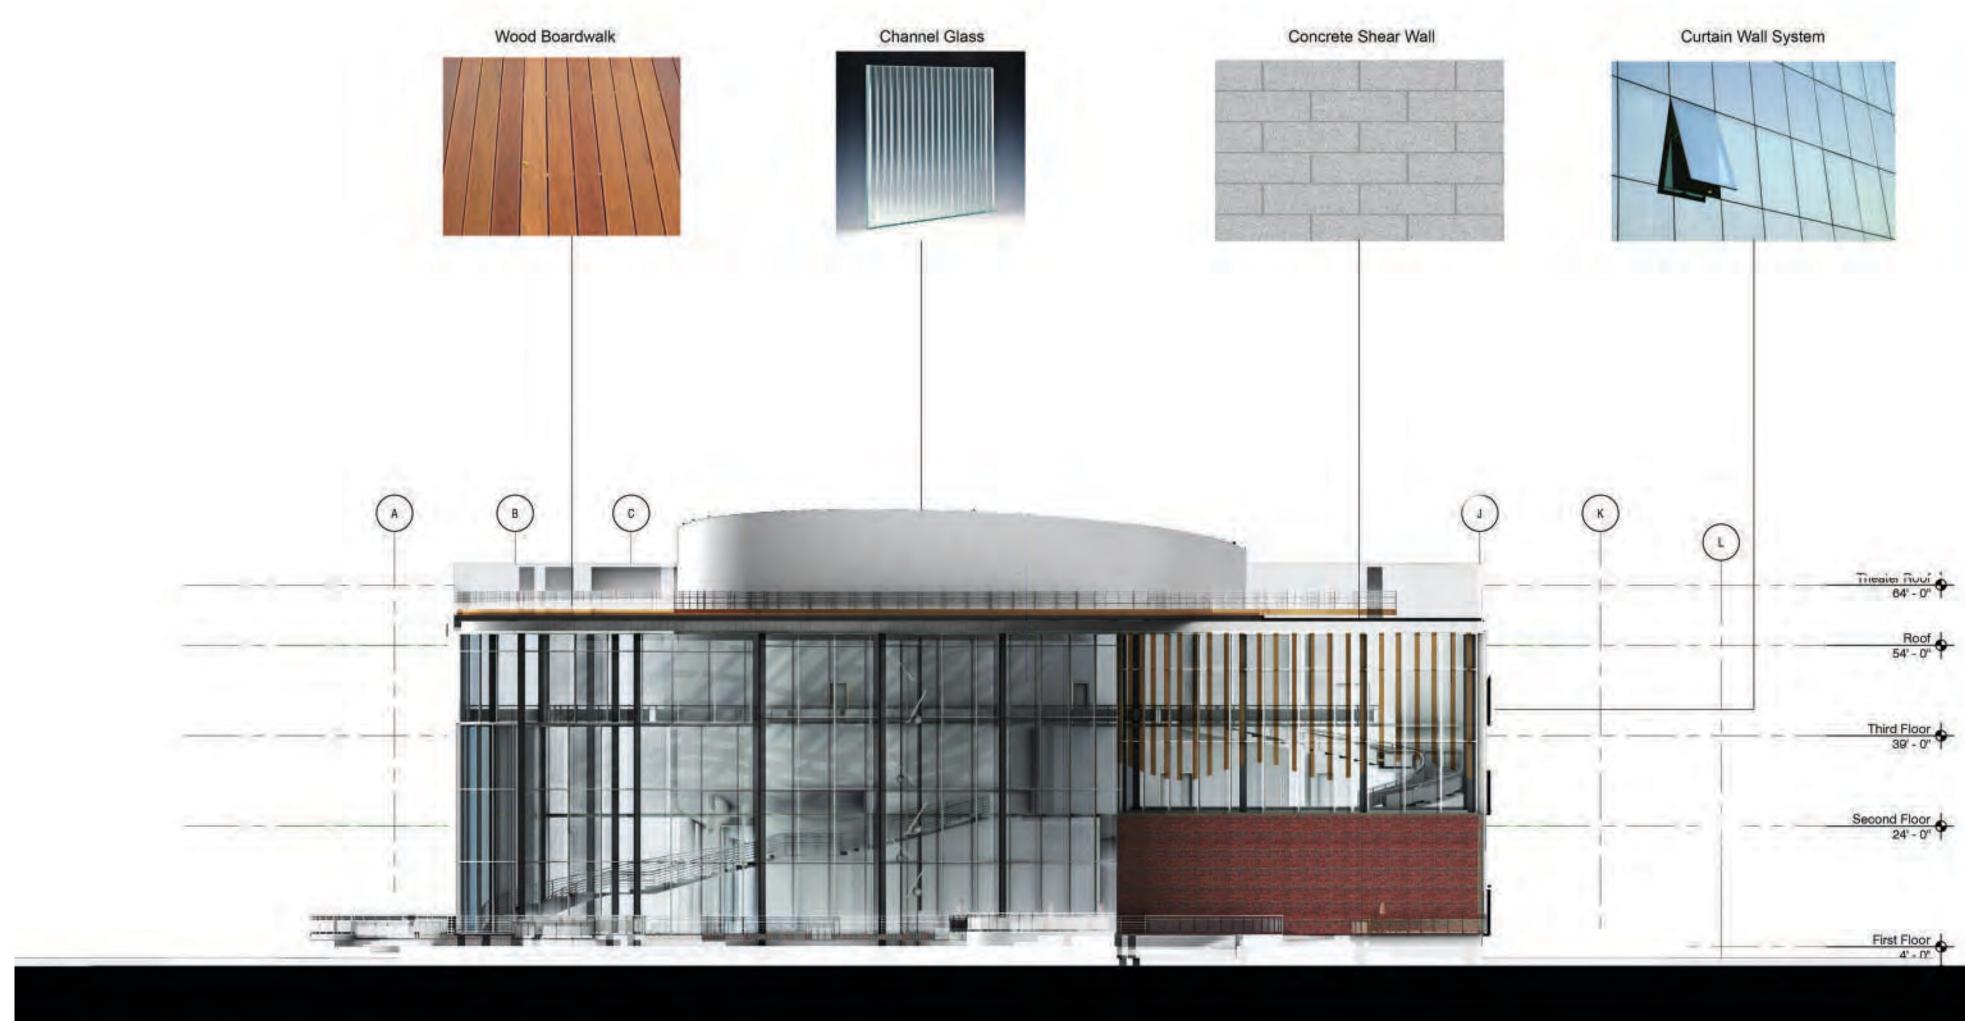
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ENCLOSURE KATHERINE CHAN

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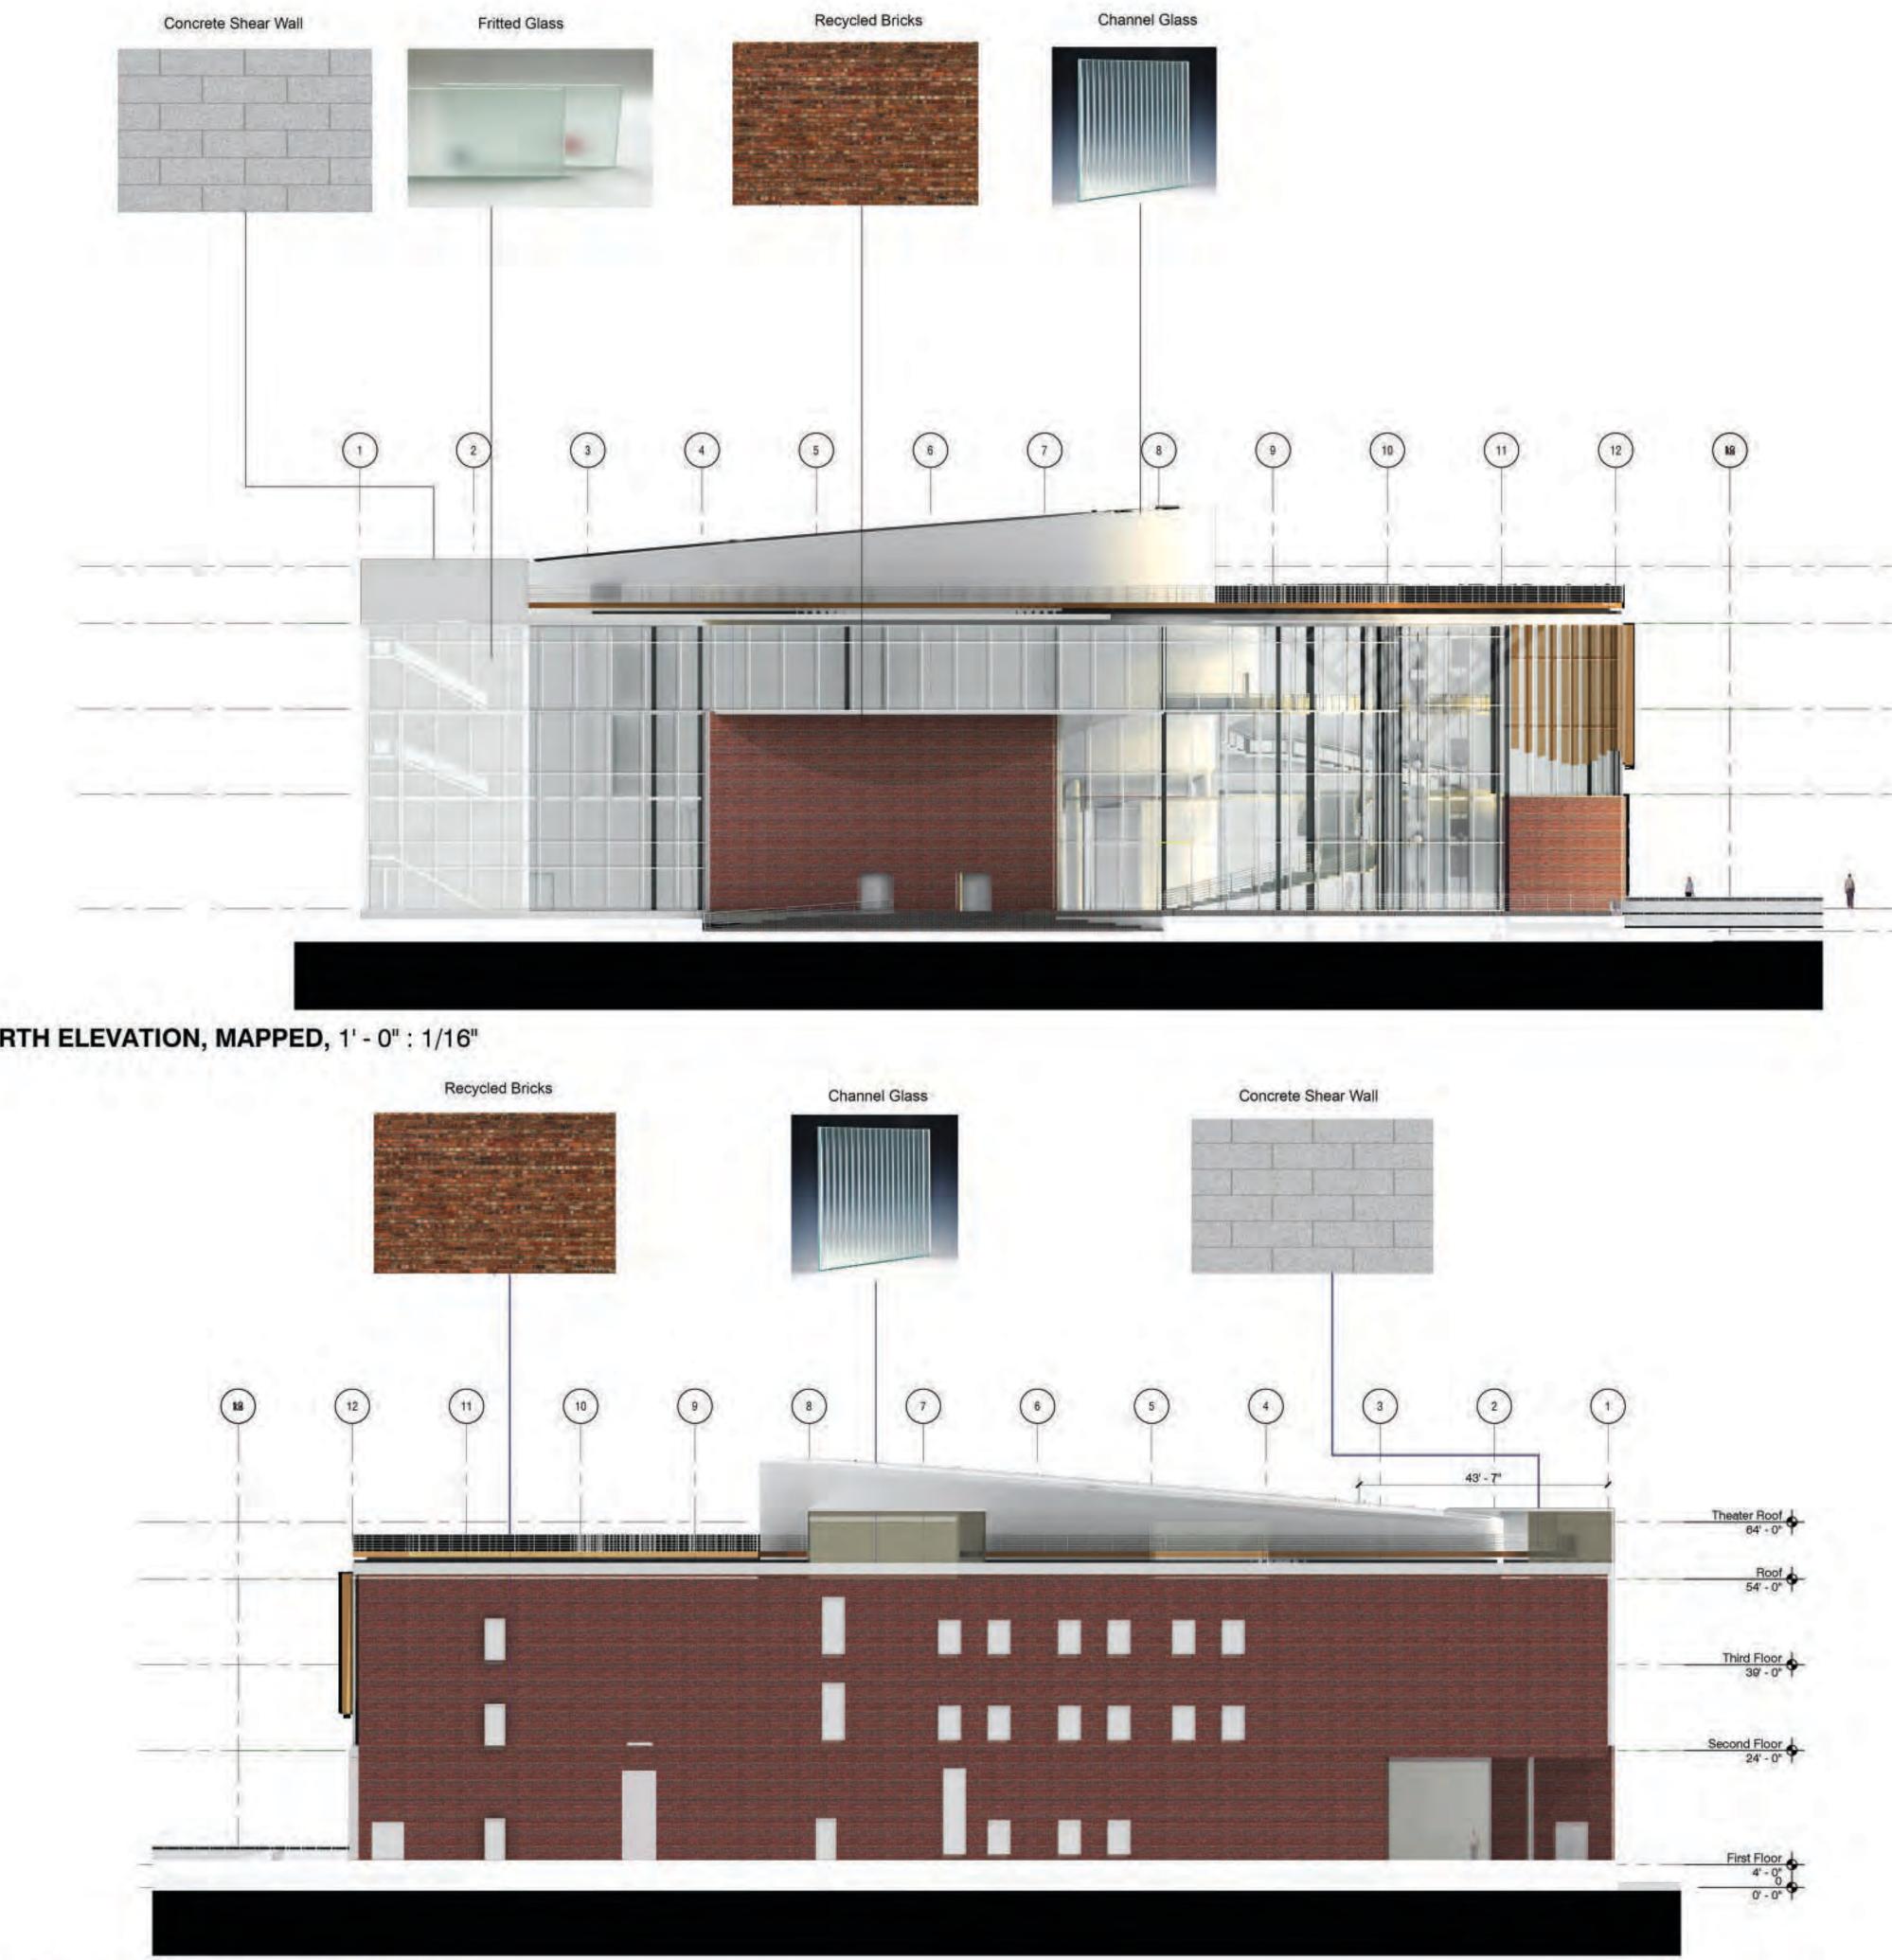
> **PROJECT** Greenpoint Theater 18 Greenpoint Ave. Brooklyn, NY 11222

DRAWING TITLE Enclosure Systems, Mapped Elevations E/W


DRAWING SCALE Various

N102

(1) SOUTH ELEVATION, MAPPED, 1' - 0": 1/16"



(2) NORTH ELEVATION, MAPPED, 1' - 0": 1/16"

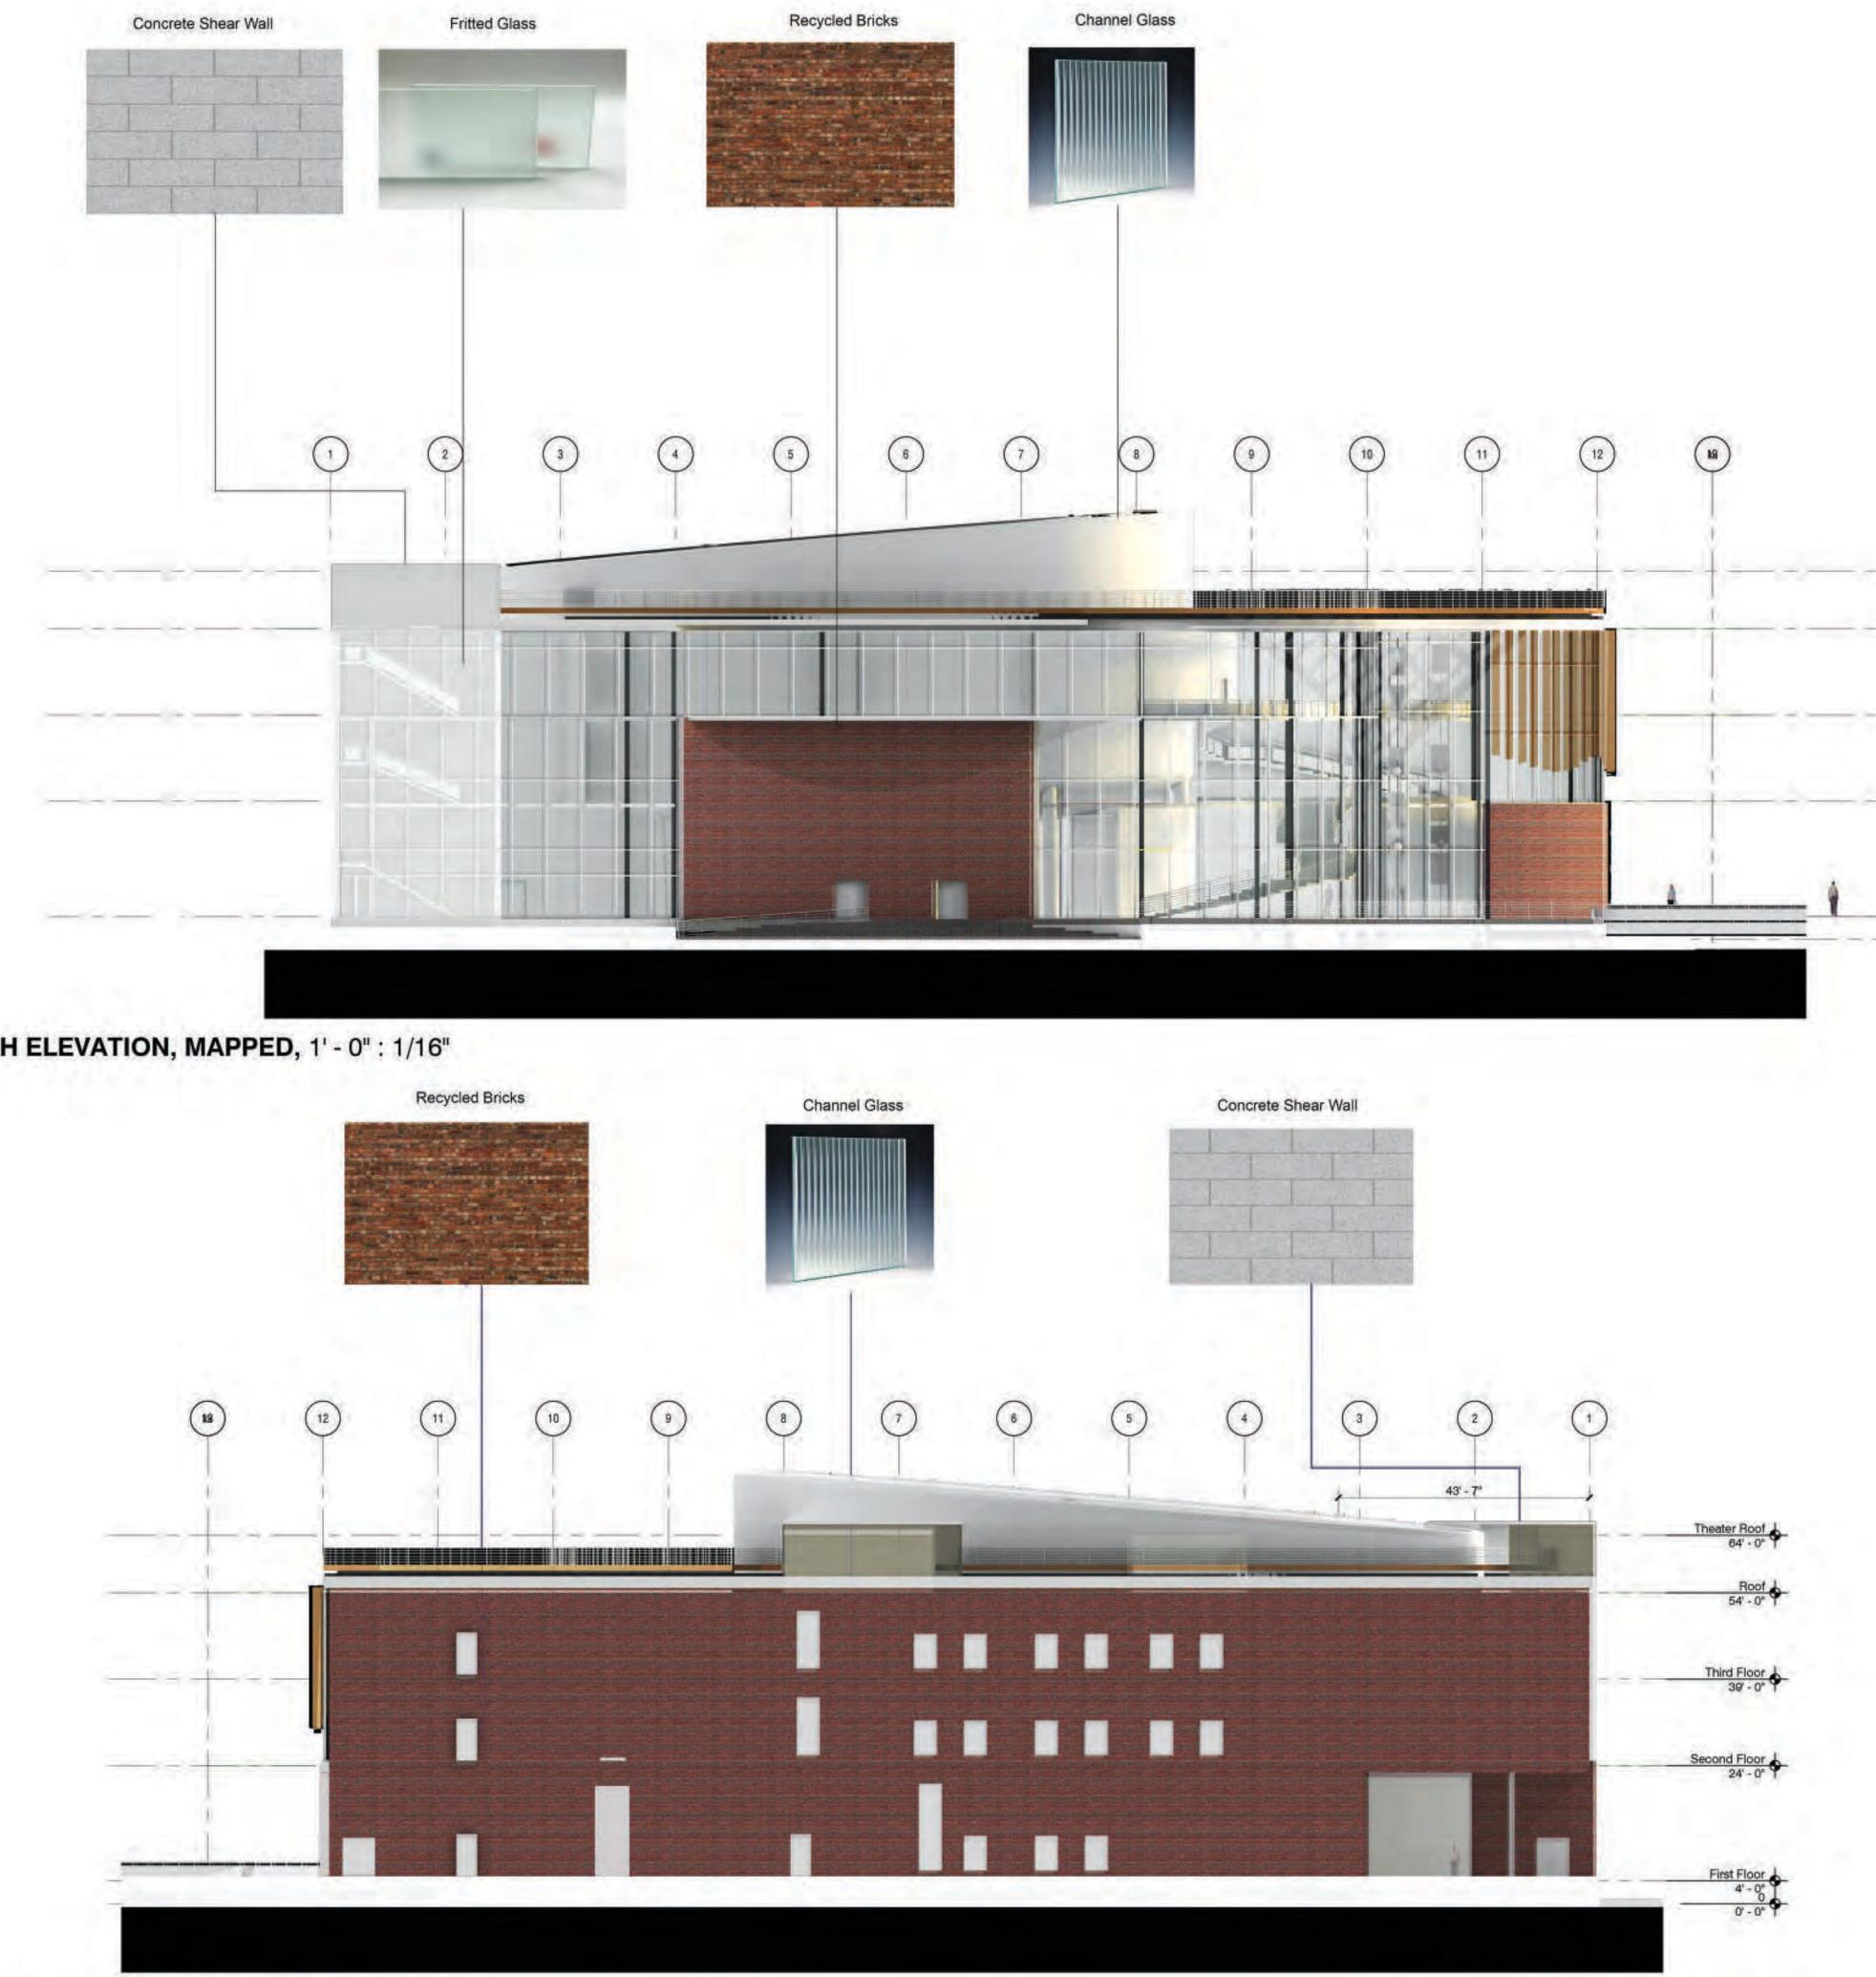



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PROJECT TEAM

ARCHITECTURE TECHNICAL CONSULTING

JOSEPH HAND Shop Architects 233 Broadway 11th Floor New York, NY 10279

STRUCTURAL AMY HARRINGTON PE Silman 32 Old Slip

New York, NY 10005

MECHANICAL & SUSTAINABILITY

JONCE WALKER LEED AP CSBA Thornton Tomasetti, Inc. 51 Madison Ave New York, NY 10010

ENCLOSURE KATHERINE CHAN

Walter P Moore 180 Maiden Ln #803 New York, NY 10038

100% CONSTRUCTION DOCUMENTS

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> PROJECT Greenpoint Theater 18 Greenpoint Ave. Brooklyn, NY 11222

DRAWING TITLE Enclosure Systems, Mapped Elevations N/S

DRAWING SCALE Various

N203


Theater Roof


Roof \$


Third Floor 39' - 0"

Second Floor



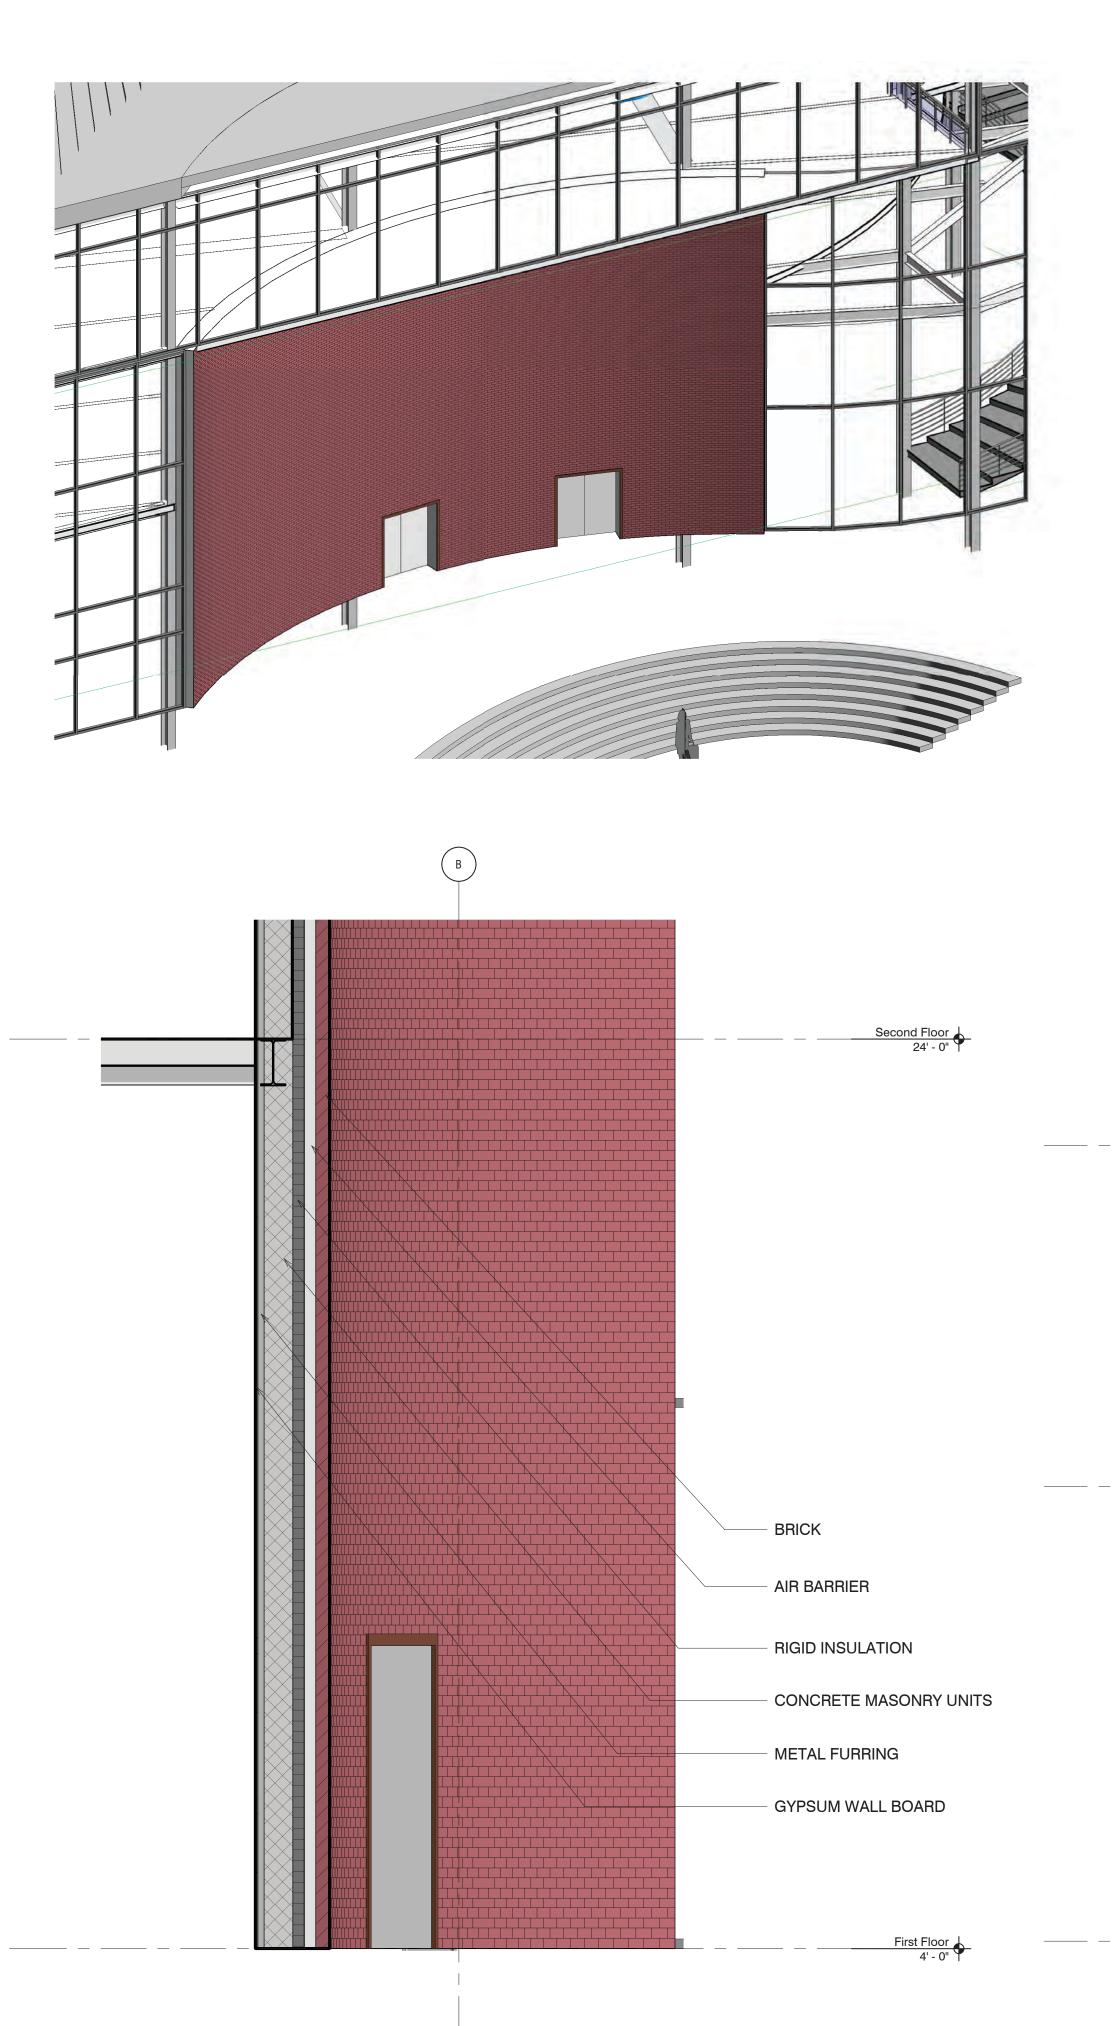

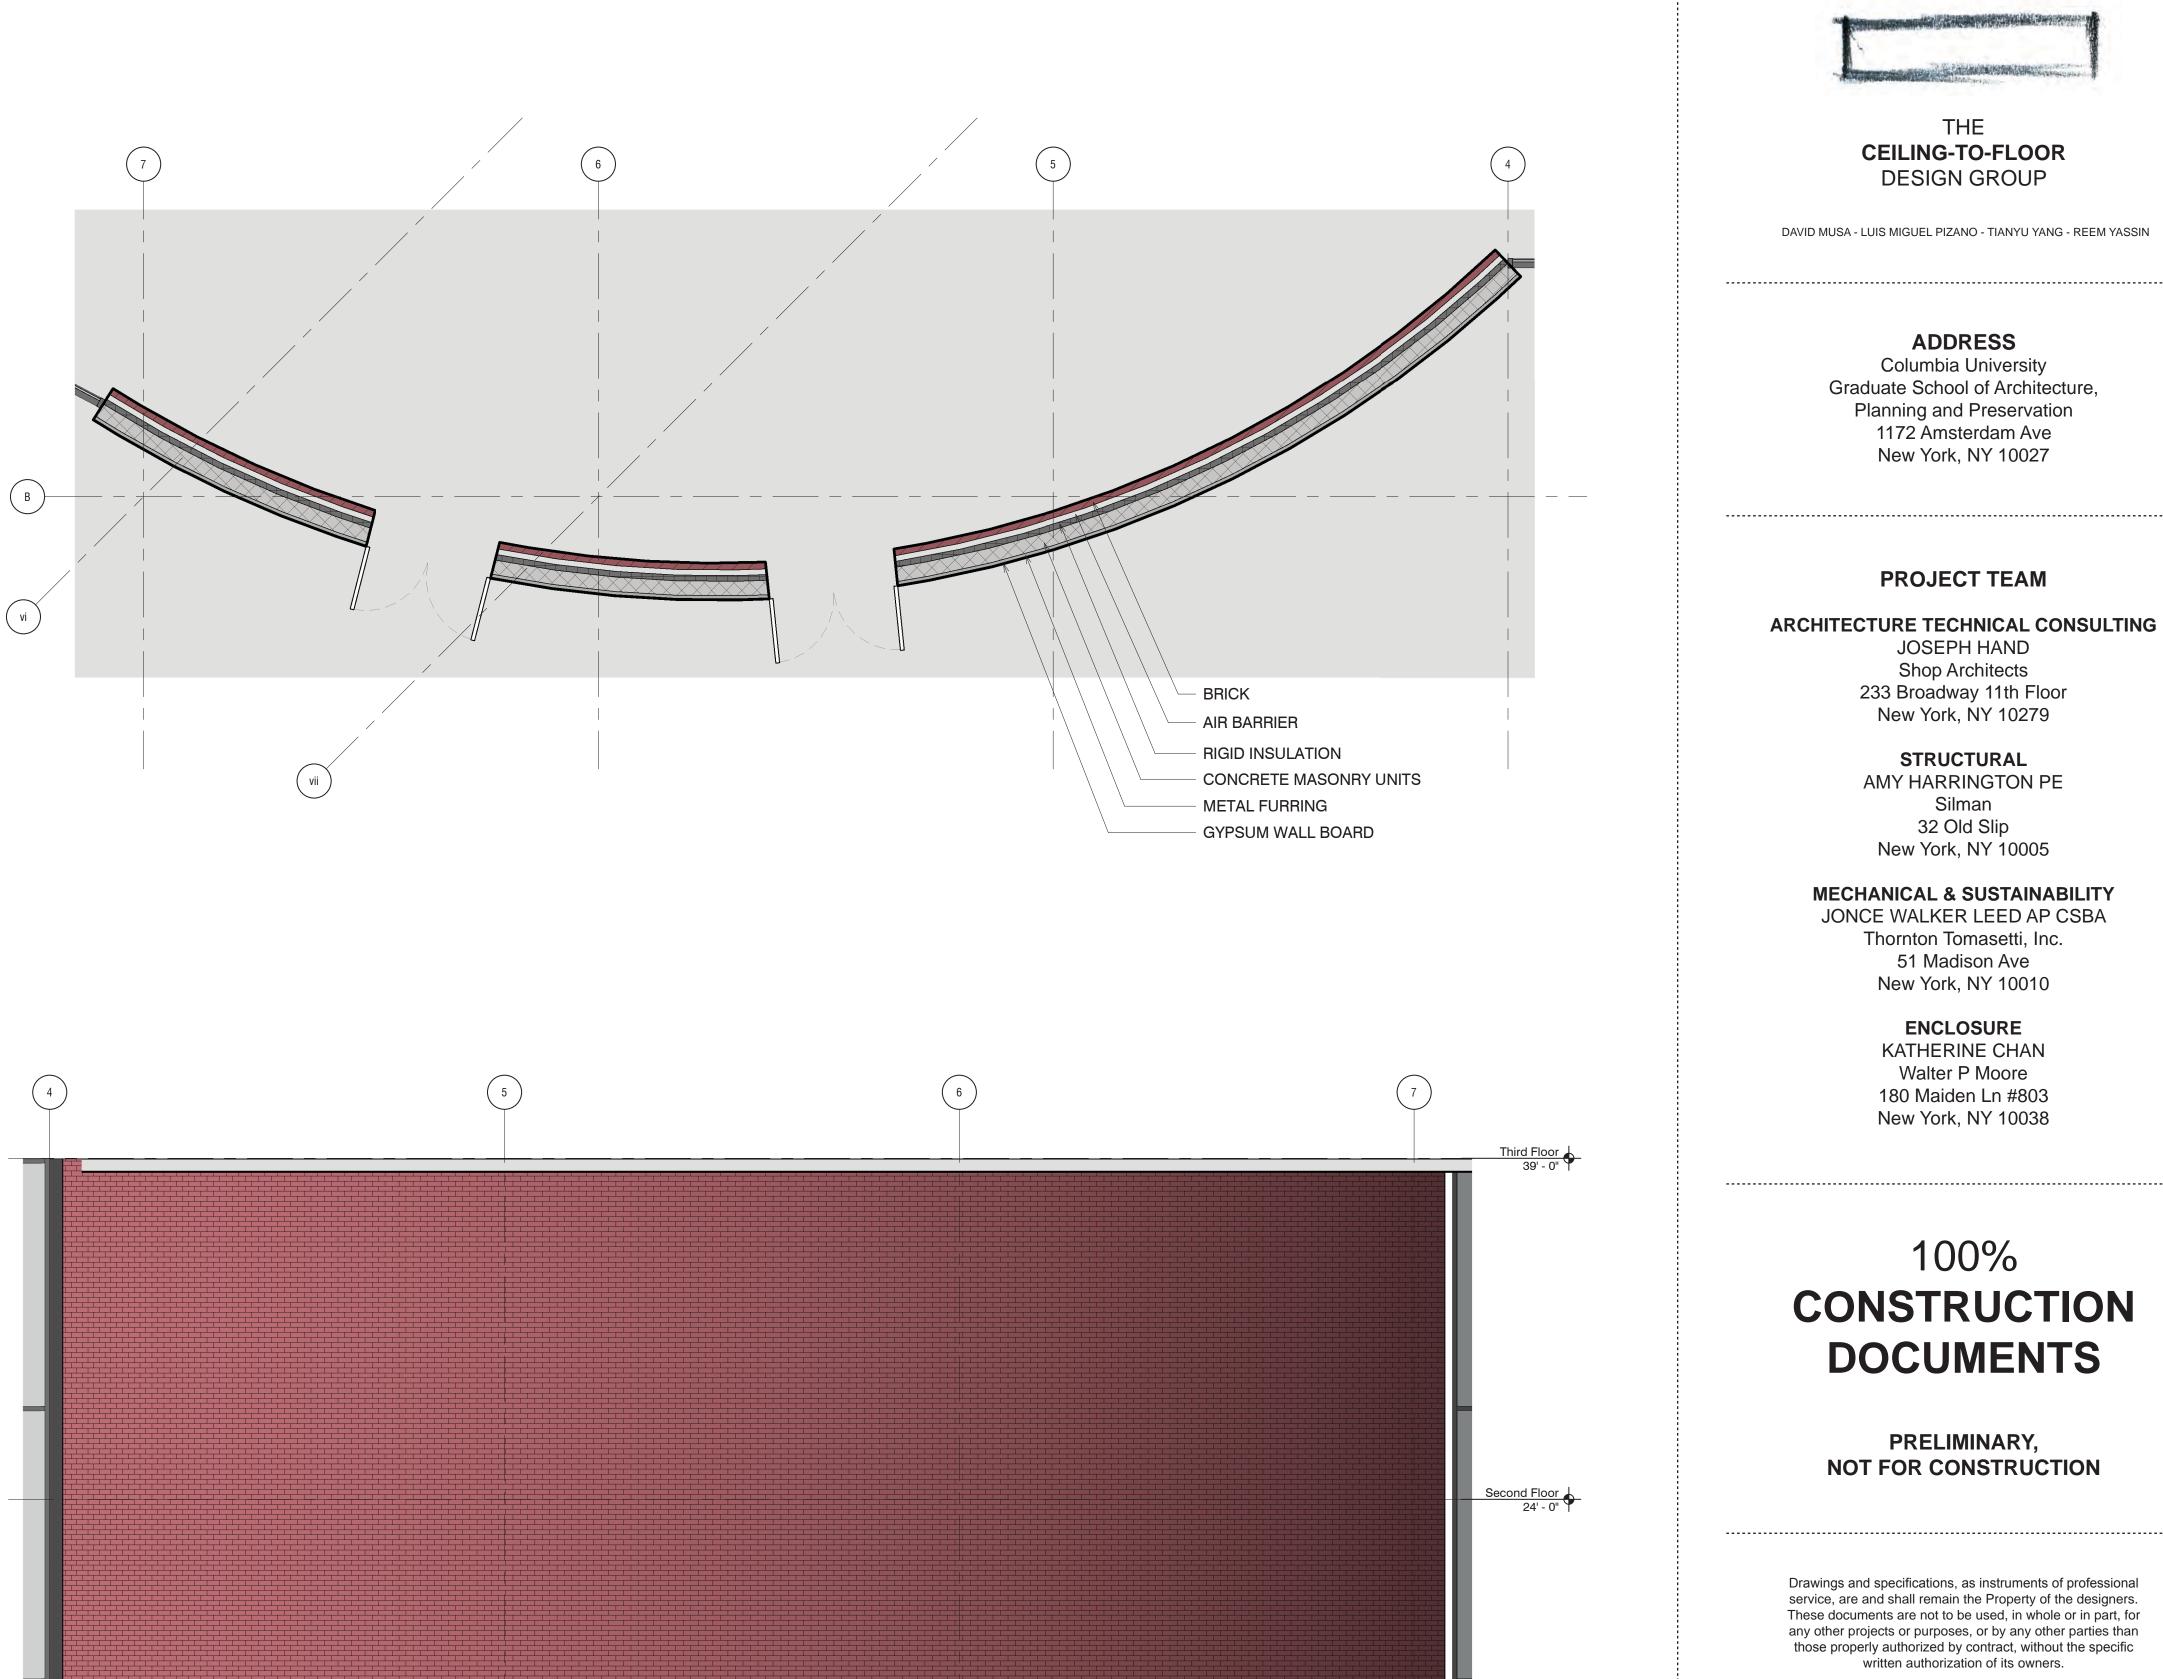

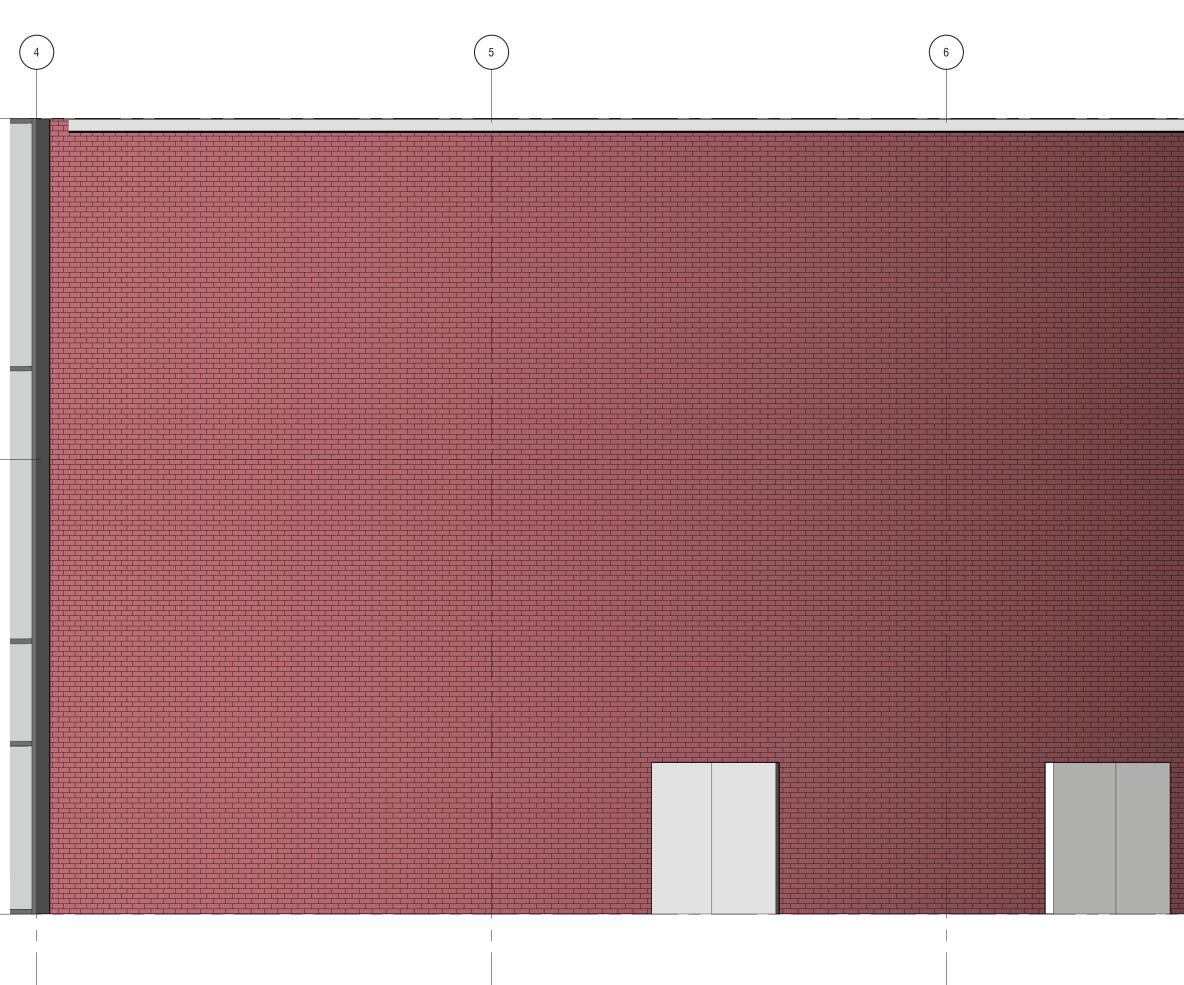


PROJECT Greenpoint Theater 18 Greenpoint Ave. Brooklyn, NY 11222

DRAWING TITLE System 1 Roadmap

First Floor 4' - 0"


DRAWING SCALE Various


Ζ 04

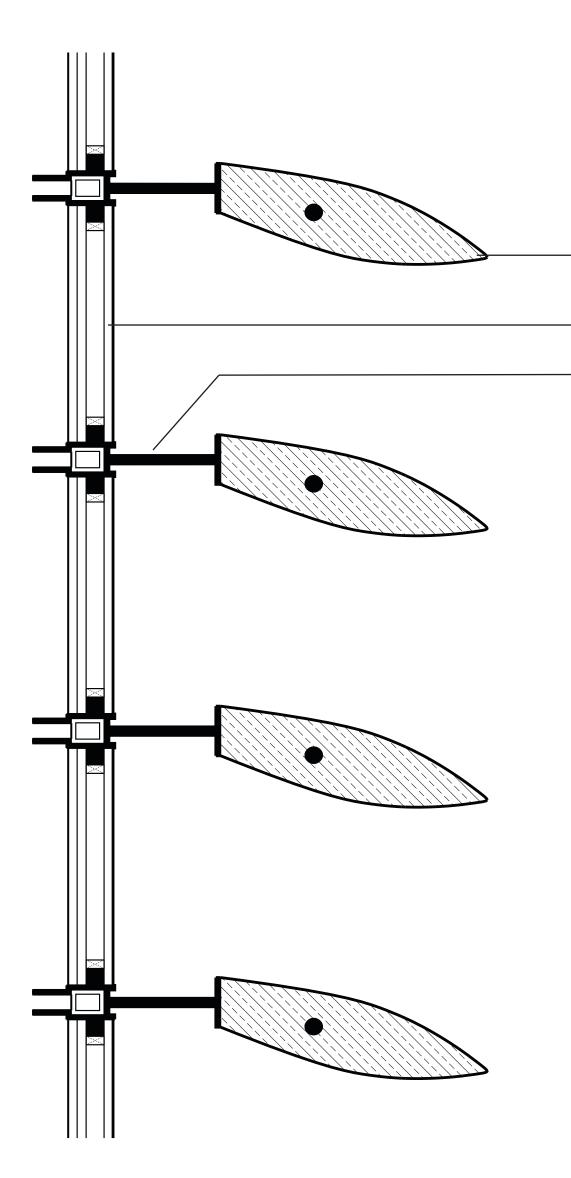


1' Reinforced Wood Fin


Low-E Argon Integrated Glazing Unit 6" Steel Clip

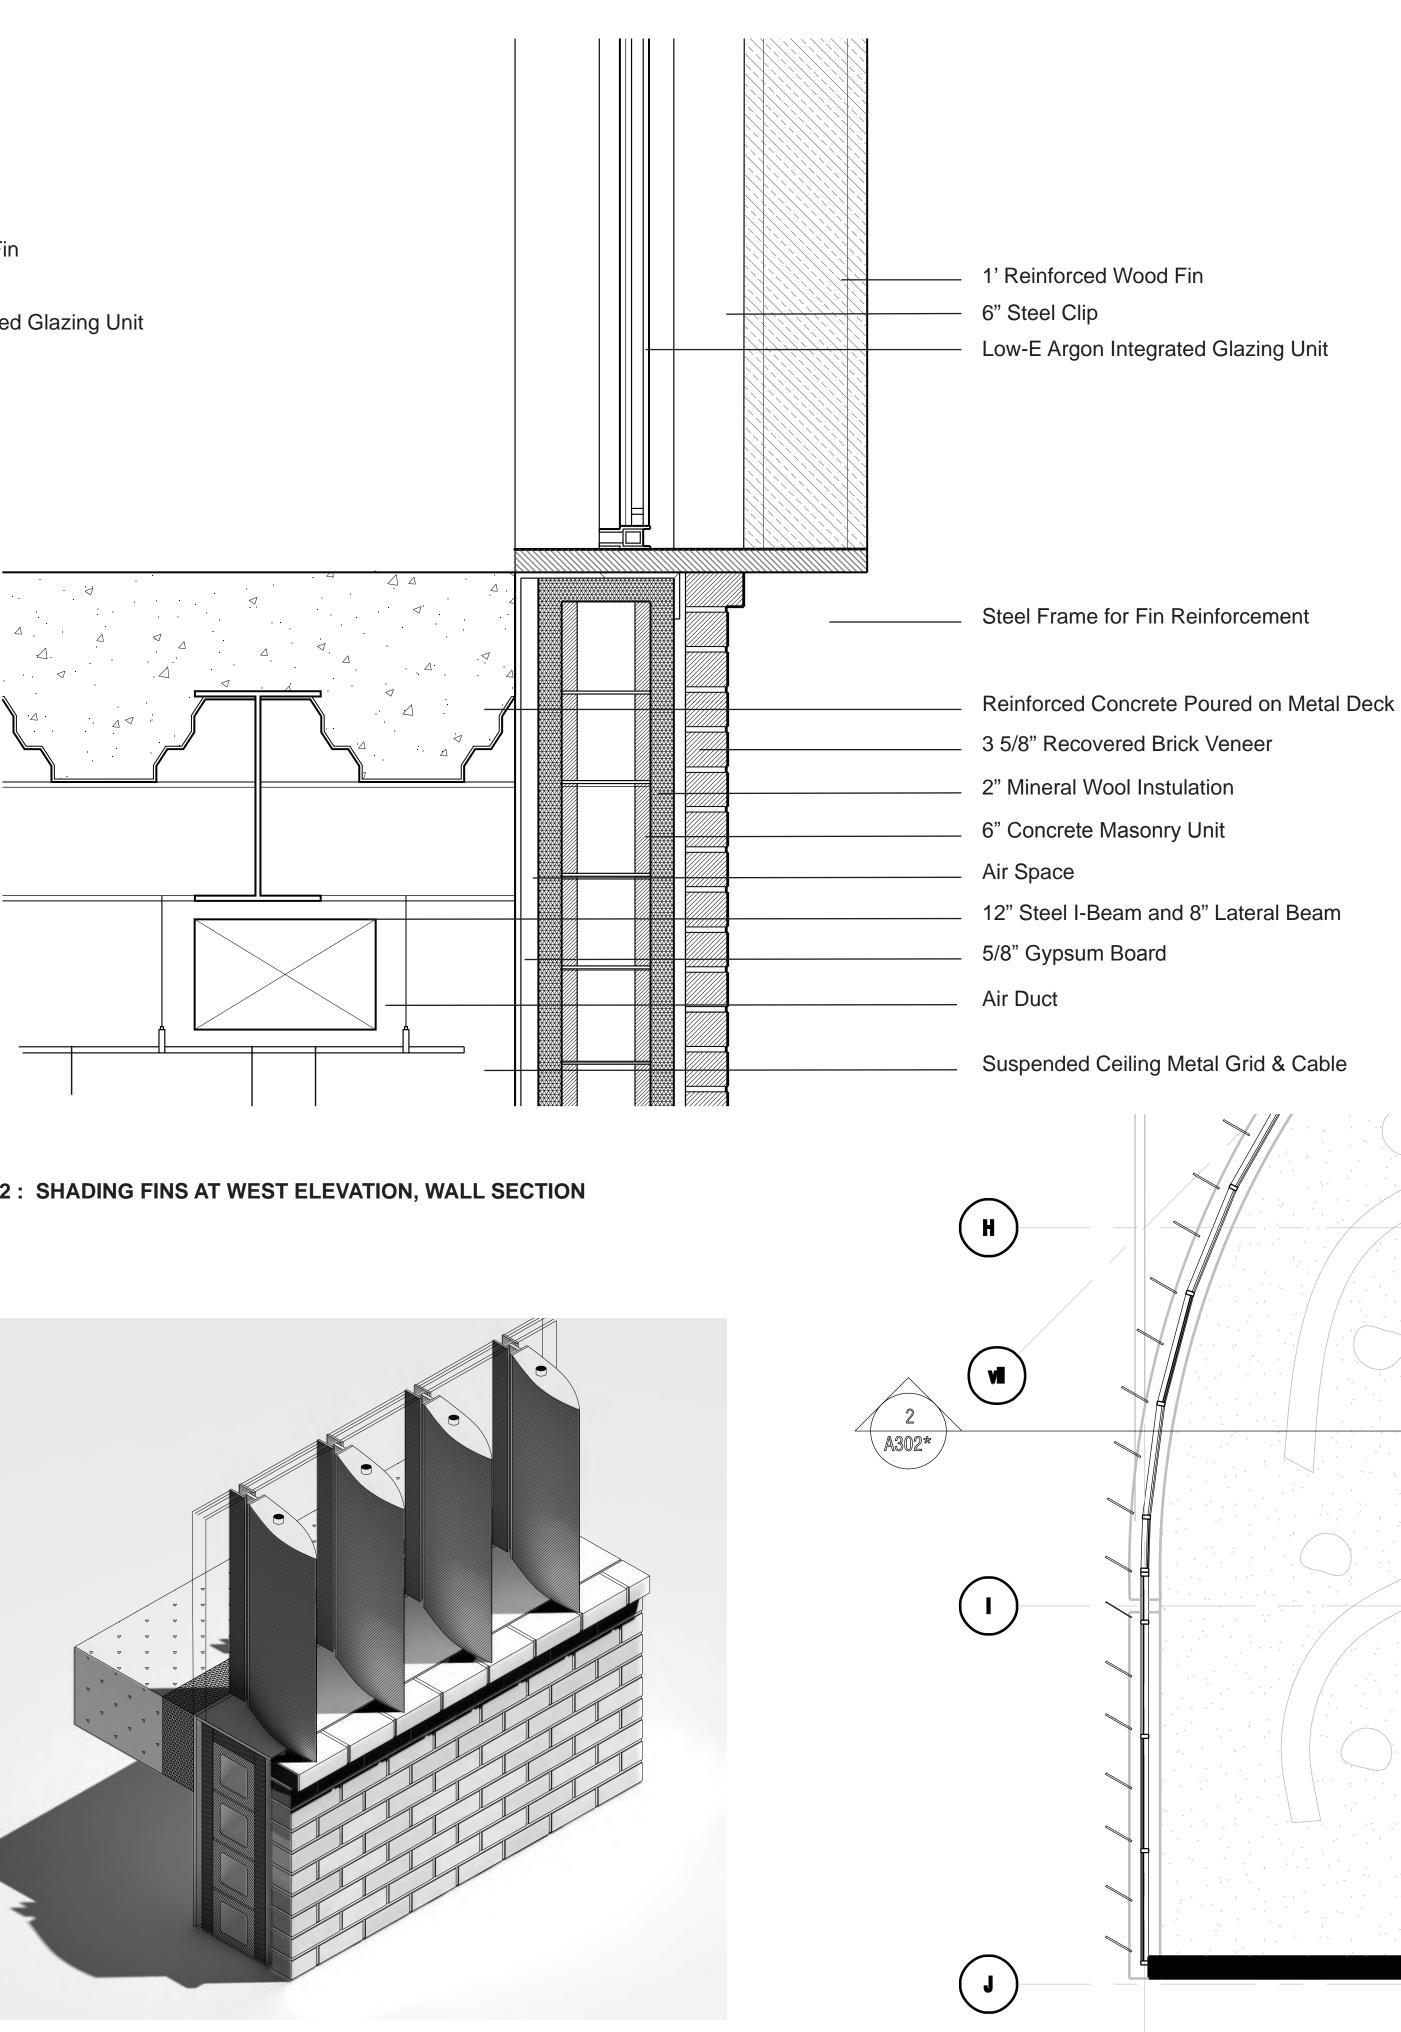

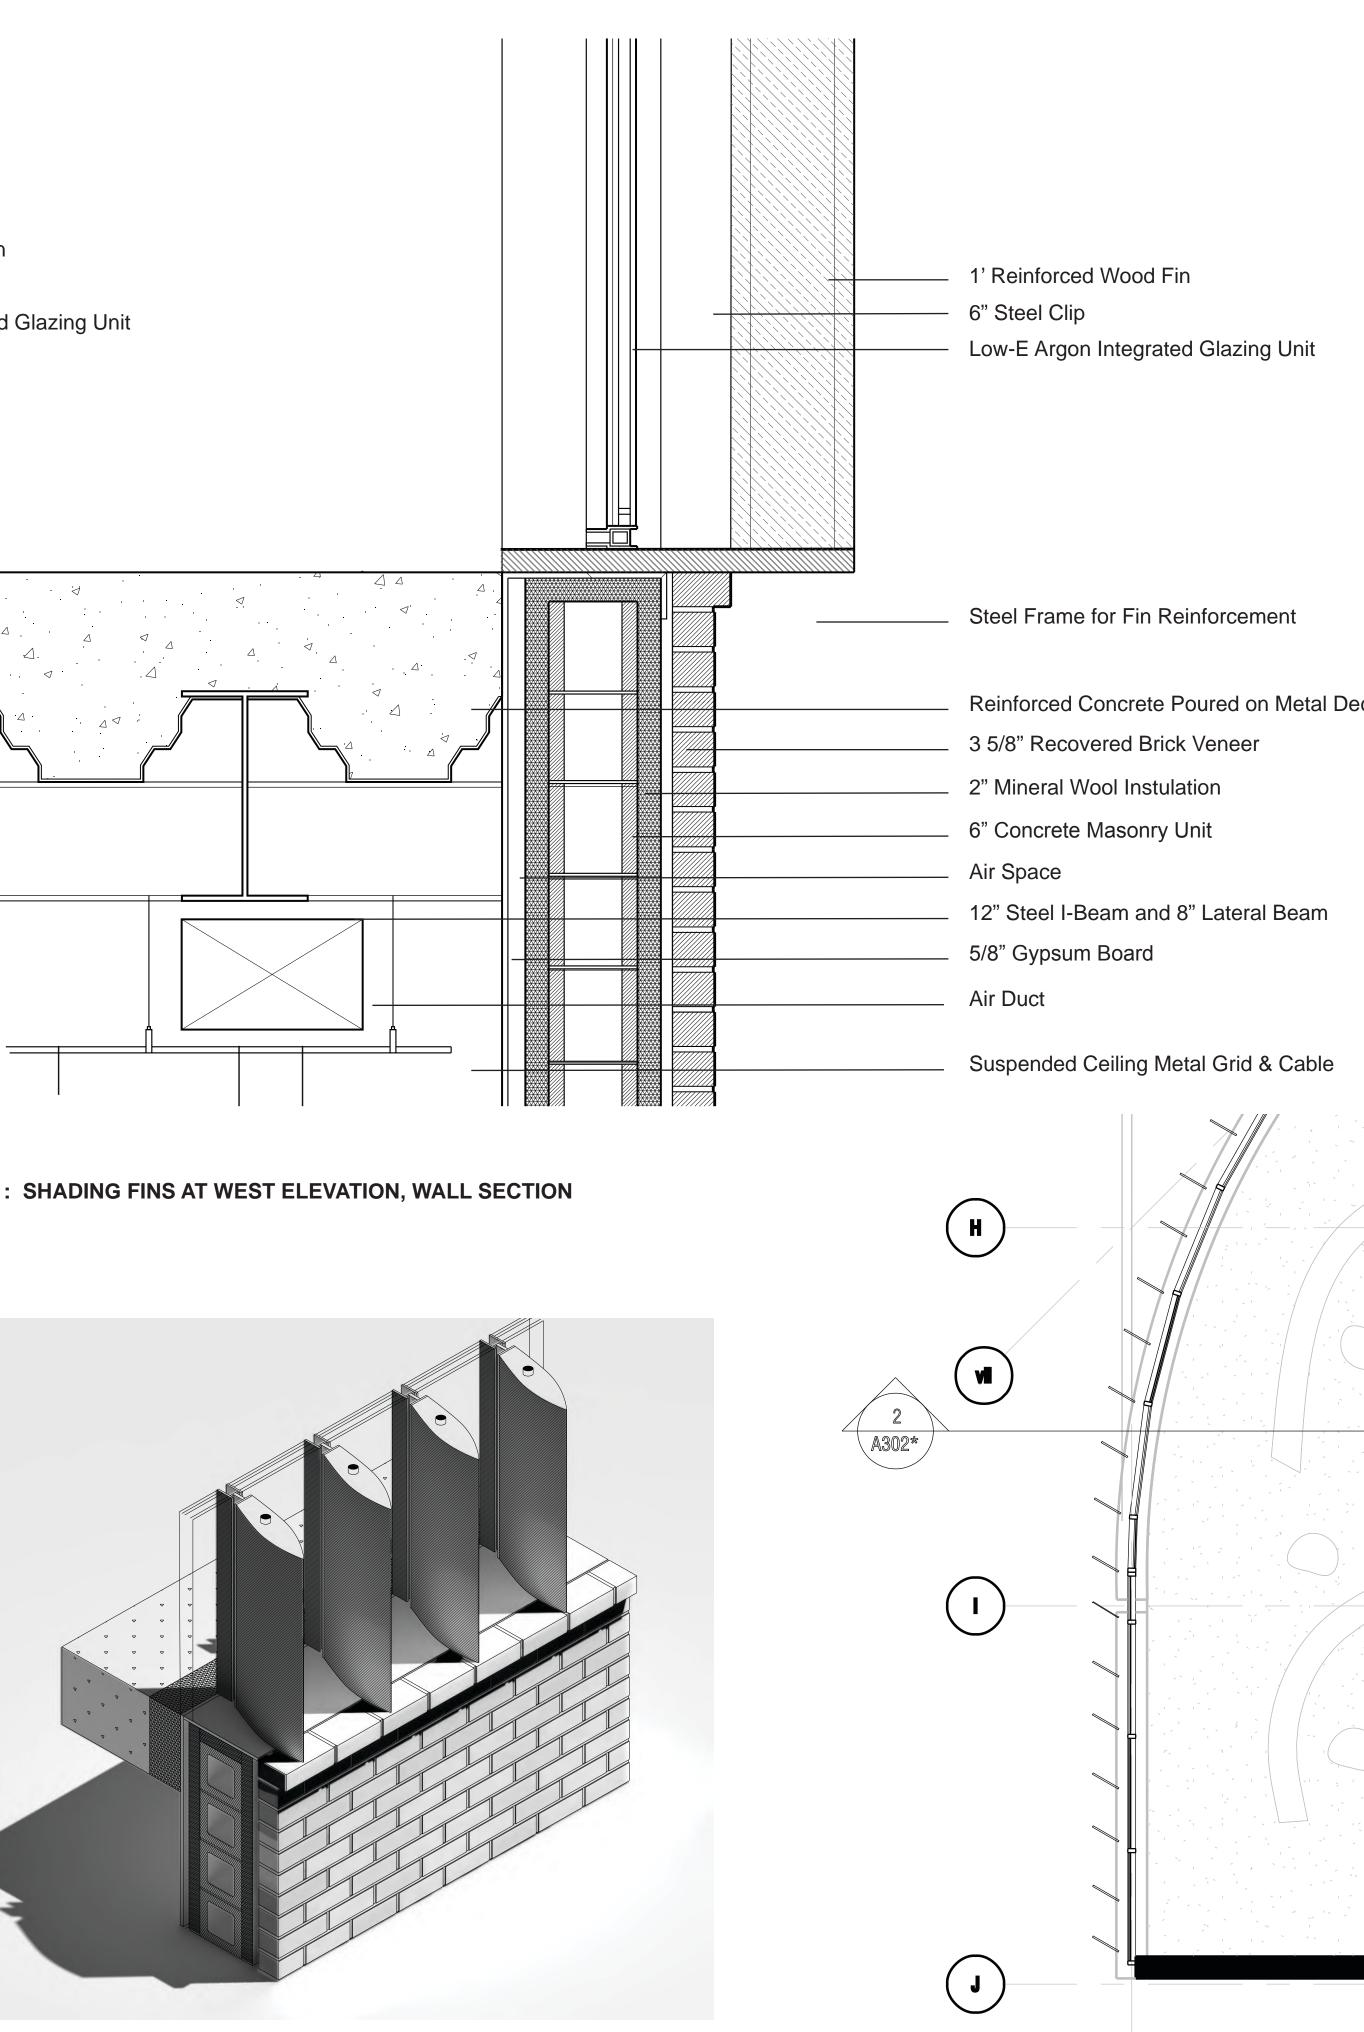

1: SHADING FINS AT WEST ELEVATION, PLAN DETAIL

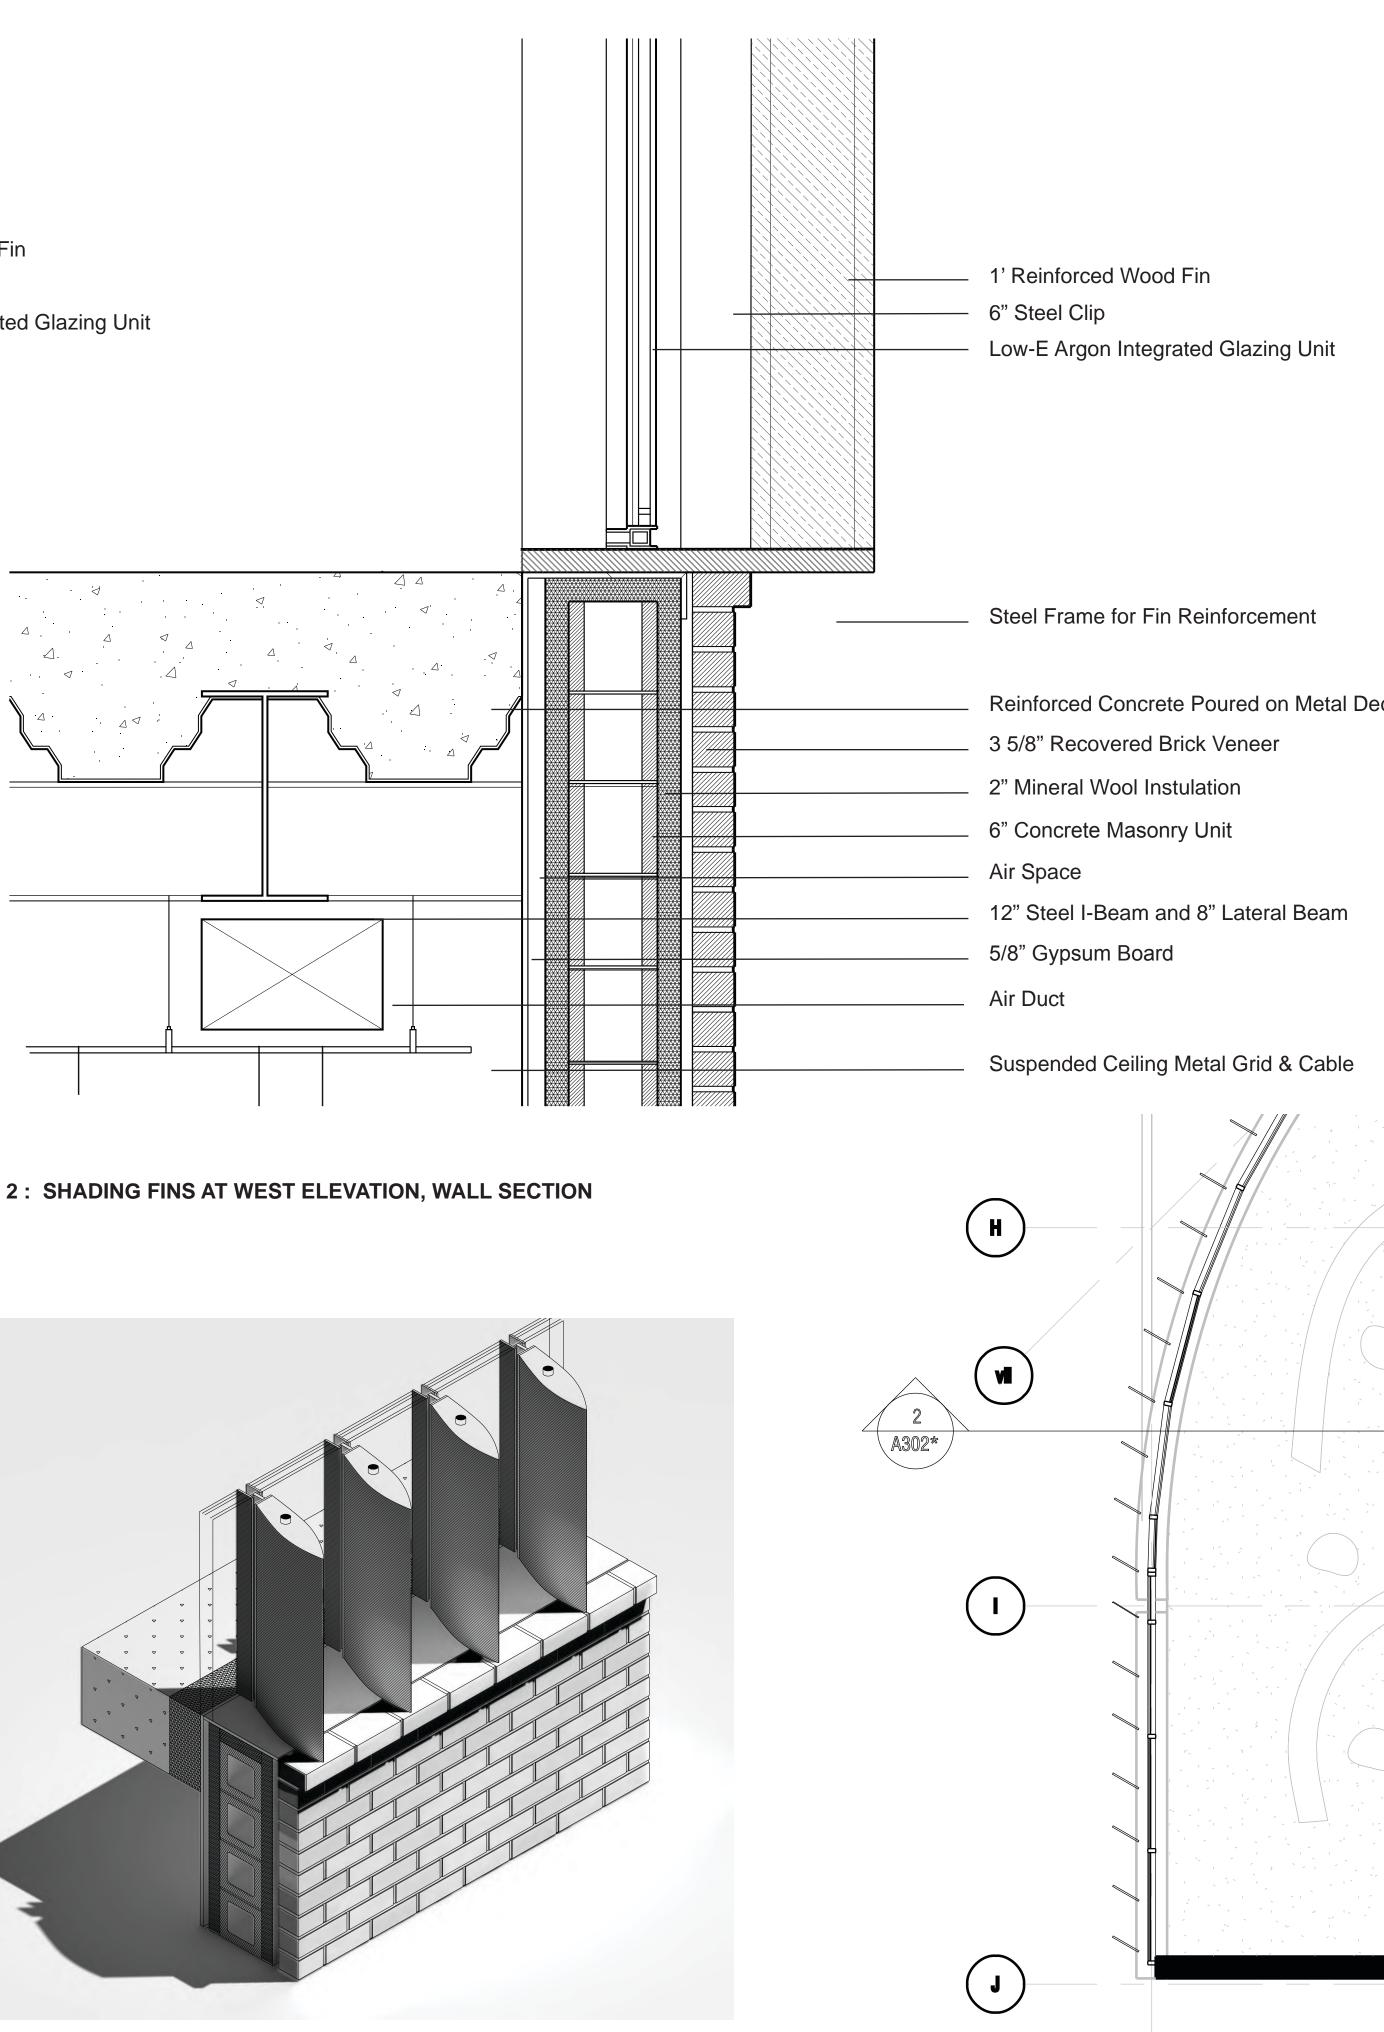

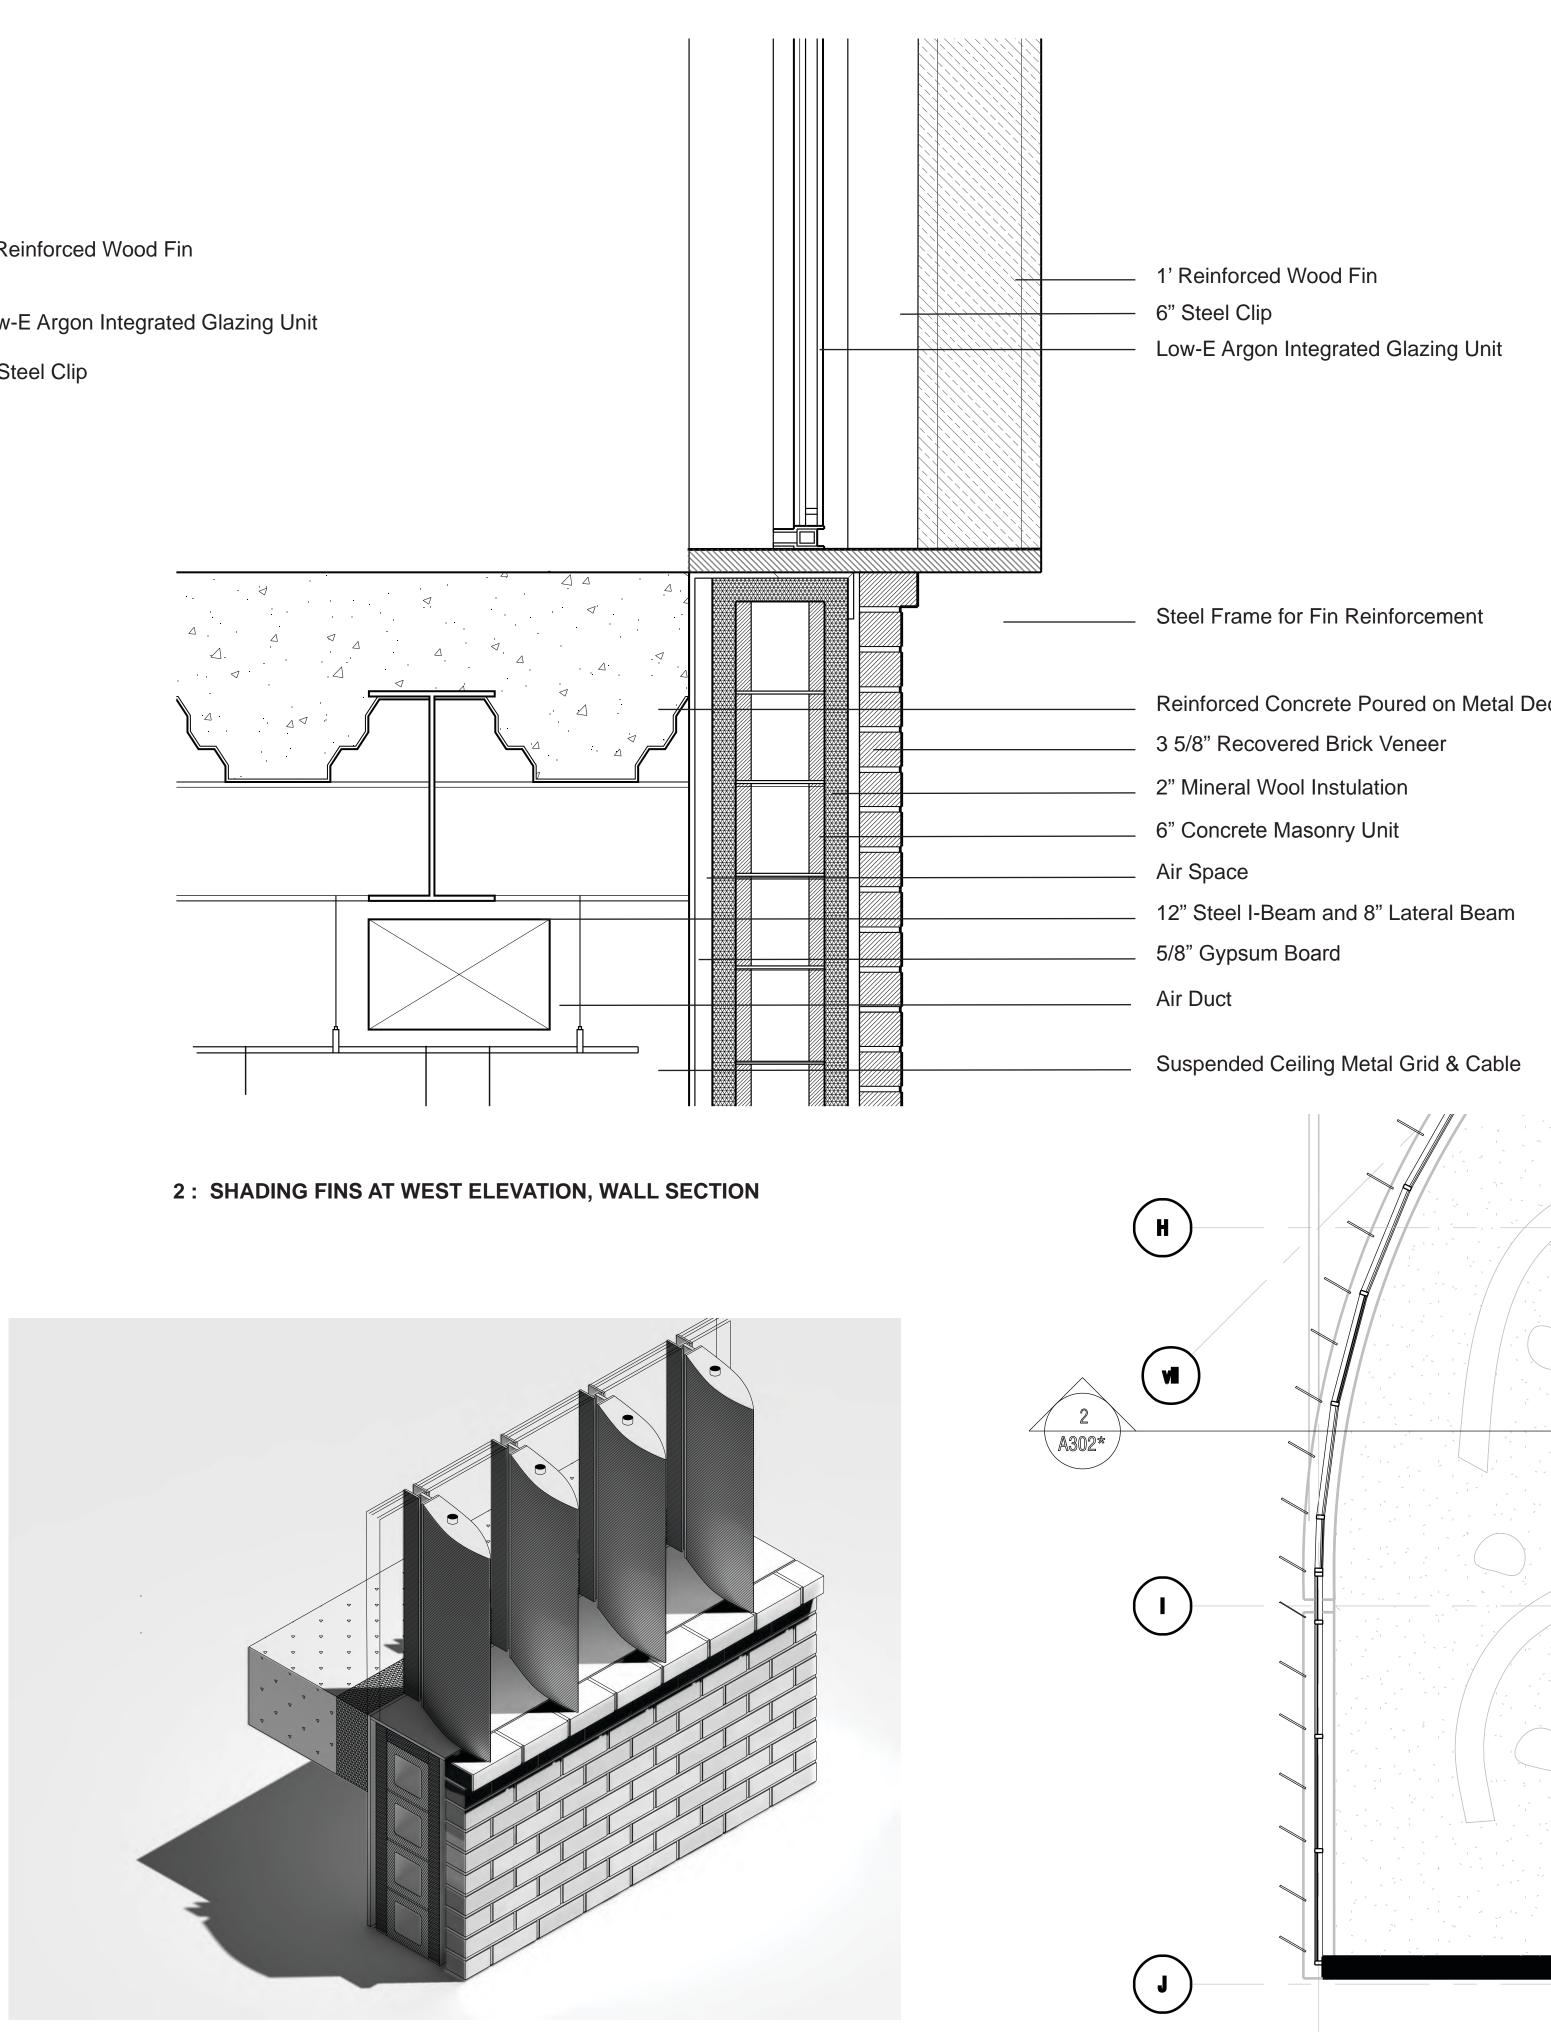

A CONTRACT OF A CO

THE **CEILING-TO-FLOOR** DESIGN GROUP

DAVID MUSA - LUIS MIGUEL PIZANO - TIANYU YANG - REEM YASSIN

ADDRESS

Columbia University Graduate School of Architecture, Planning and Preservation 1172 Amsterdam Ave New York, NY 10027

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PROJECT

Greenpoint Theater 18 Greenpoint Ave. Brooklyn, NY 11222

DRAWING TITLE System 2 Details

DRAWING SCALE Various

M205